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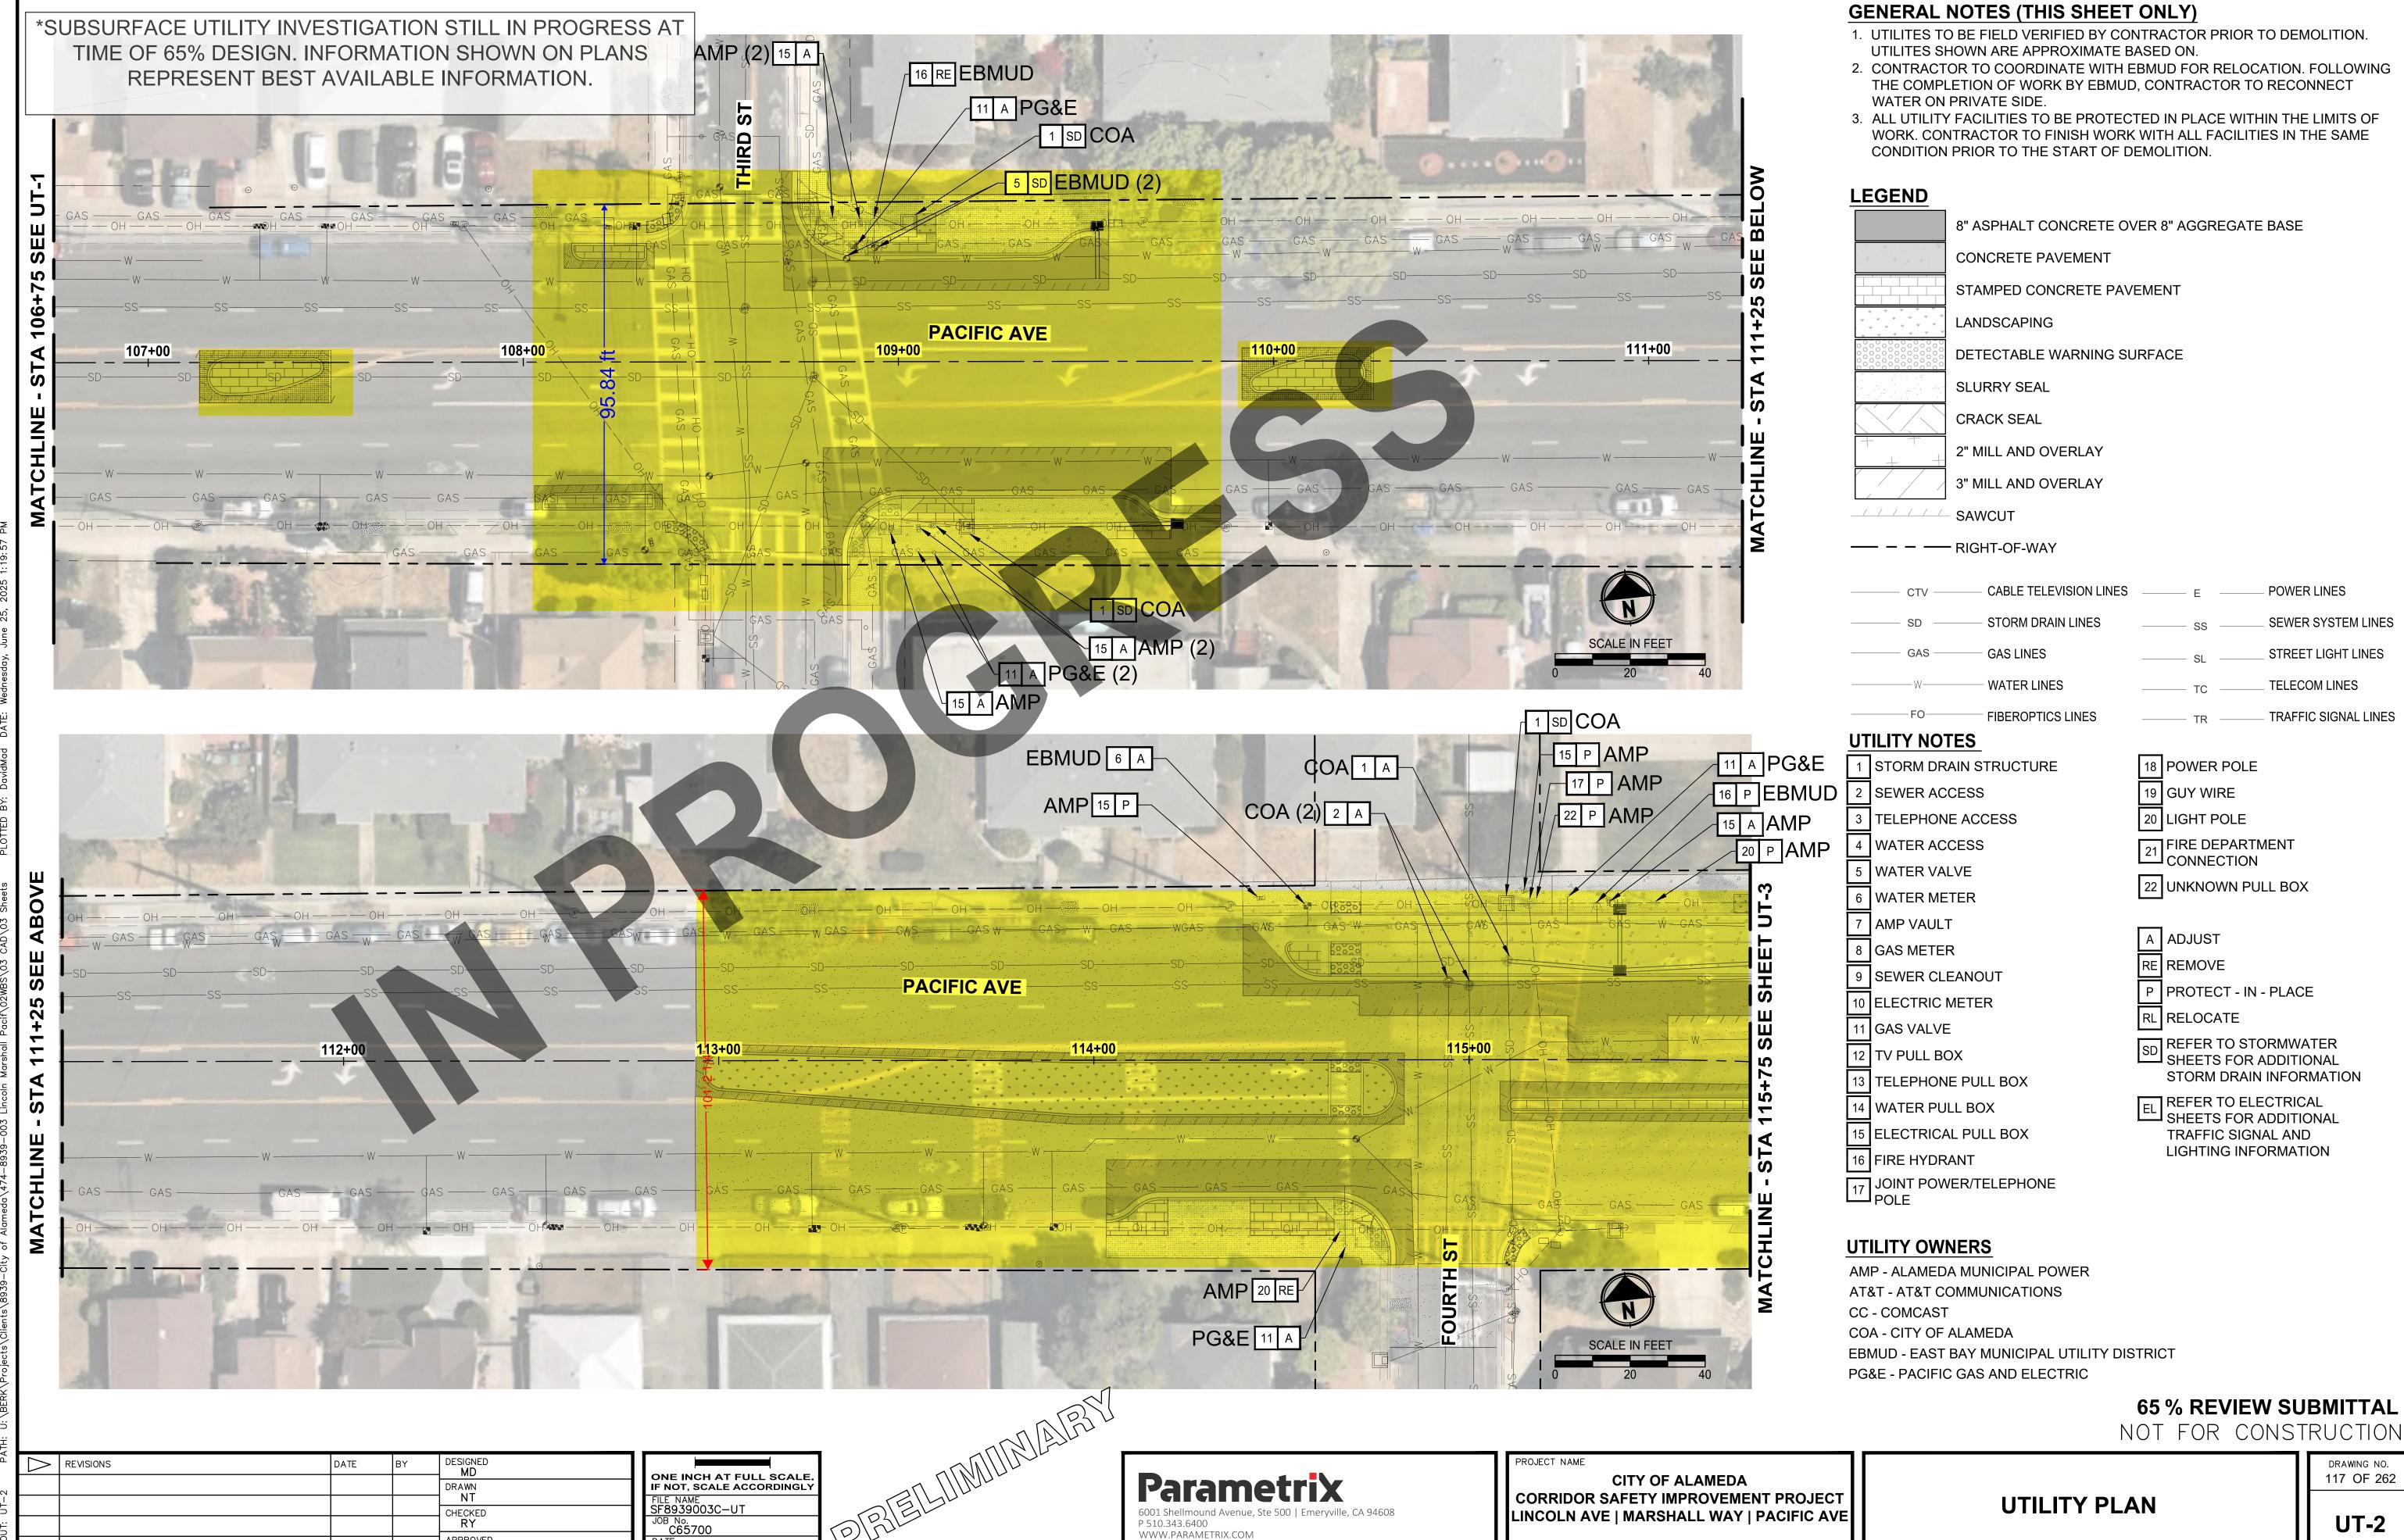
APPROVED DP

DATE 06/2025

DRAWING NO. 116 OF 262

**UTILITY PLAN** 

LINCOLN AVE | MARSHALL WAY | PACIFIC AVE




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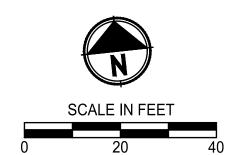
DATE 06/2025

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DRAWING NO. 117 OF 262

\*SUBSURFACE UTILITY INVESTIGATION STILL IN PROGRESS AT TIME OF 65% DESIGN. INFORMATION SHOWN ON PLANS REPRESENT BEST AVAILABLE INFORMATION.



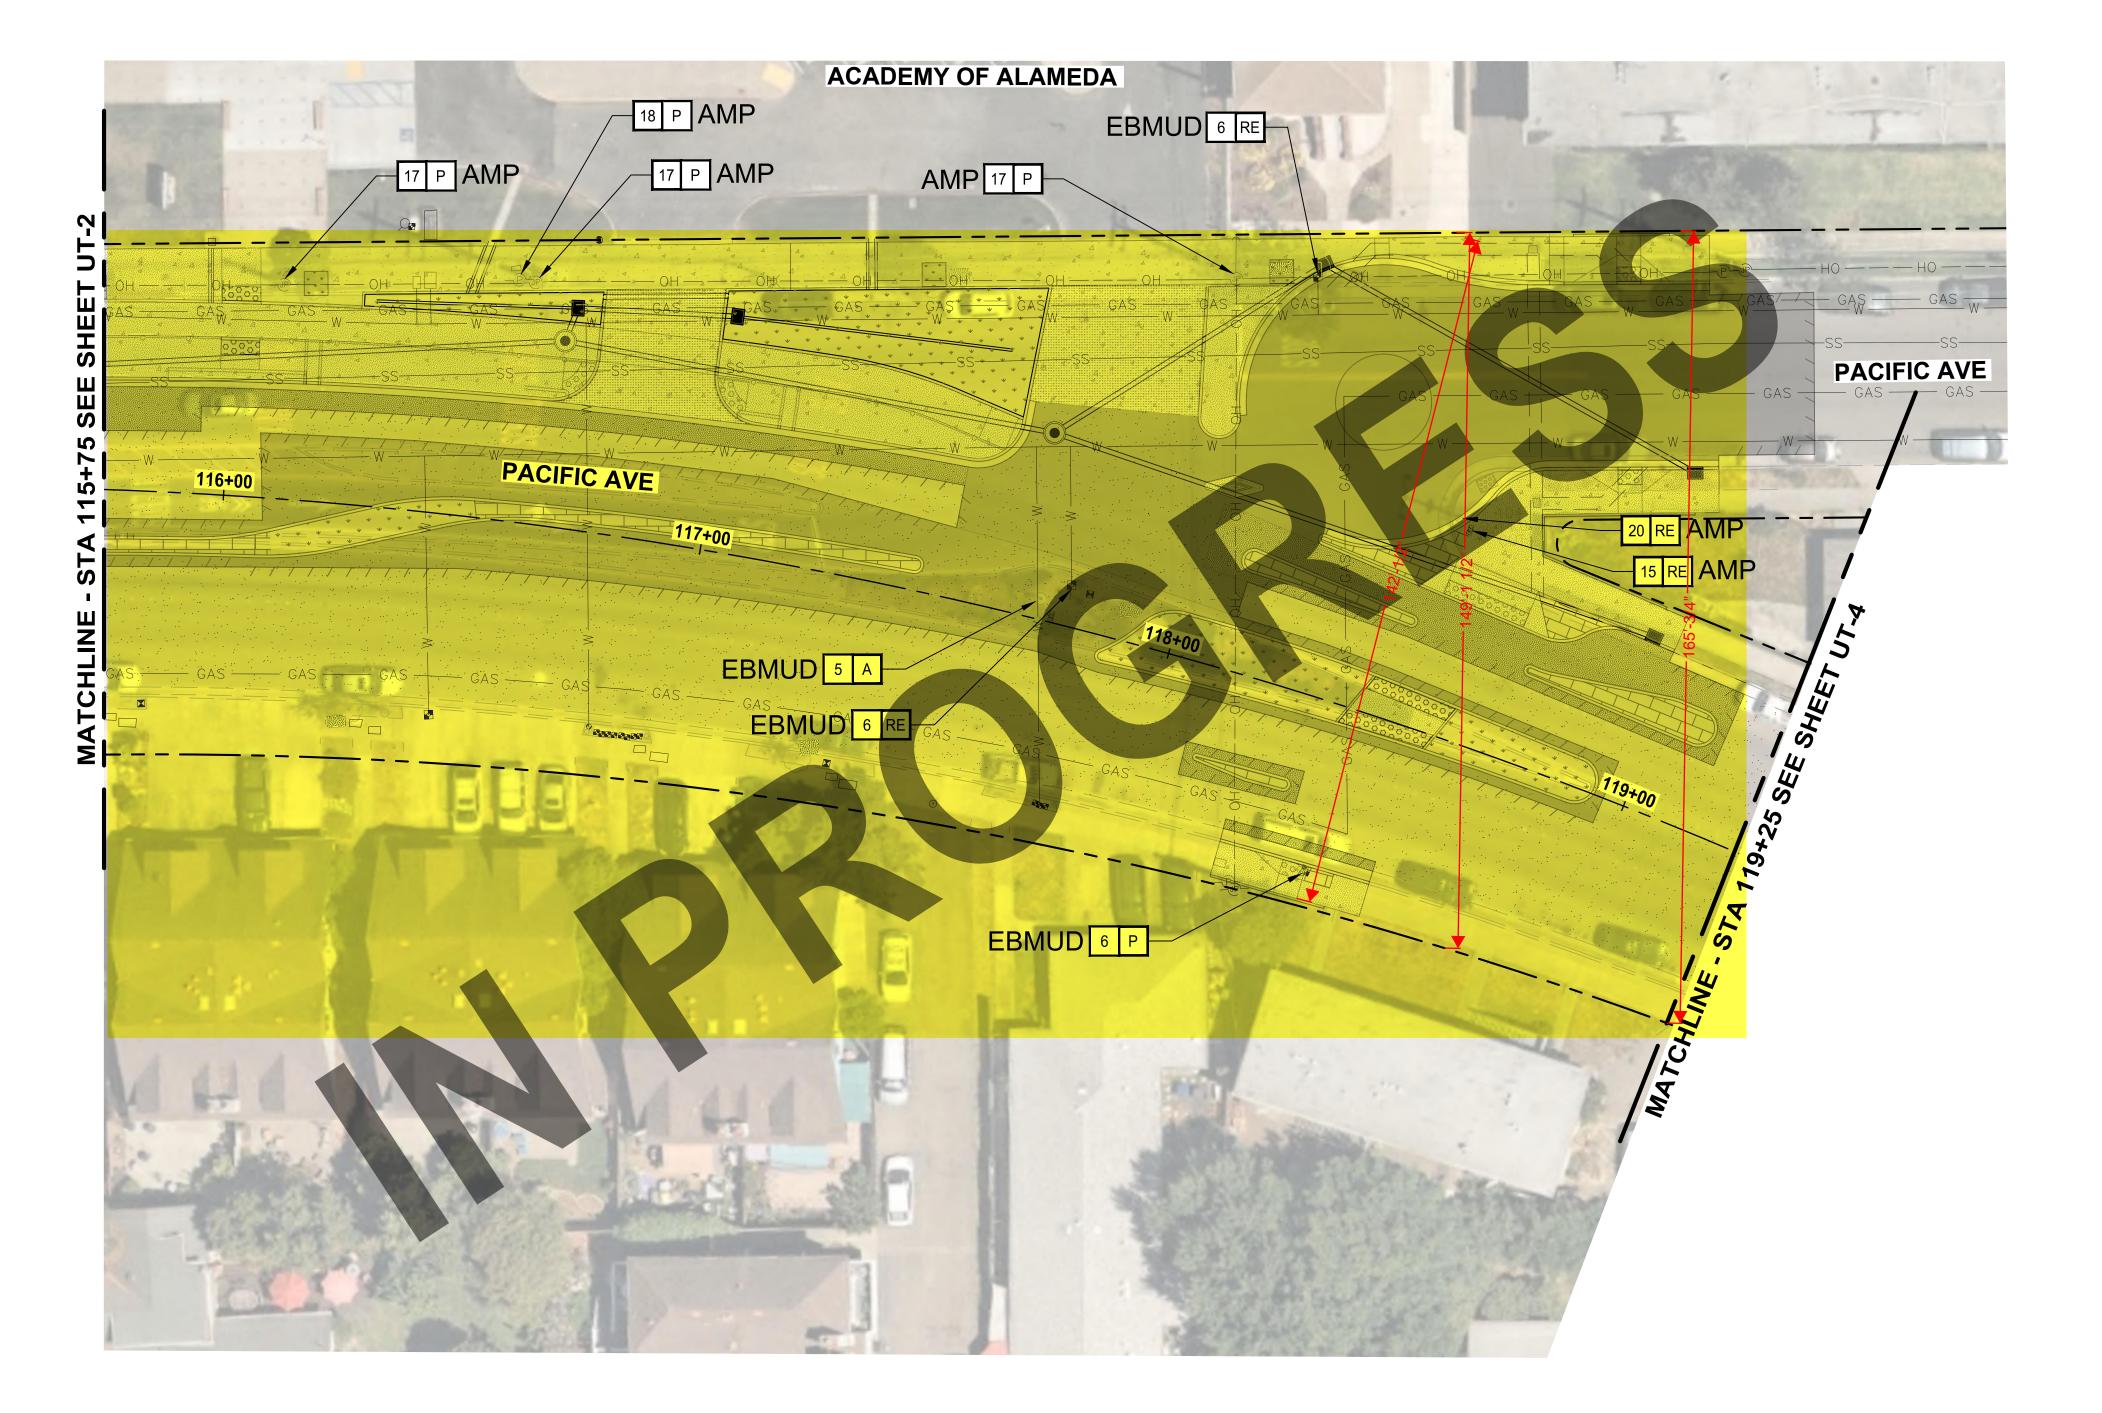

PROJECT NAME

## **GENERAL NOTES (THIS SHEET ONLY)**

- 1. UTILITES TO BE FIELD VERIFIED BY CONTRACTOR PRIOR TO DEMOLITION. UTILITES SHOWN ARE APPROXIMATE BASED ON.
- 2. CONTRACTOR TO COORDINATE WITH EBMUD FOR RELOCATION. FOLLOWING THE COMPLETION OF WORK BY EBMUD, CONTRACTOR TO RECONNECT WATER ON PRIVATE SIDE.
- 3. ALL UTILITY FACILITIES TO BE PROTECTED IN PLACE WITHIN THE LIMITS OF WORK. CONTRACTOR TO FINISH WORK WITH ALL FACILITIES IN THE SAME CONDITION PRIOR TO THE START OF DEMOLITION.

**LEGEND** 8" ASPHALT CONCRETE OVER 8" AGGREGATE BASE CONCRETE PAVEMENT STAMPED CONCRETE PAVEMENT LANDSCAPING DETECTABLE WARNING SURFACE SLURRY SEAL CRACK SEAL 2" MILL AND OVERLAY 3" MILL AND OVERLAY SAWCUT - RIGHT-OF-WAY CABLE TELEVISION LINES POWER LINES STORM DRAIN LINES SEWER SYSTEM LINES GAS LINES STREET LIGHT LINES WATER LINES TELECOM LINES - FIBEROPTICS LINES TRAFFIC SIGNAL LINES **UTILITY NOTES** 18 POWER POLE 1 STORM DRAIN STRUCTURE 2 SEWER ACCESS 19 GUY WIRE 20 LIGHT POLE 3 TELEPHONE ACCESS FIRE DEPARTMENT CONNECTION 4 WATER ACCESS 5 WATER VALVE 22 UNKNOWN PULL BOX 6 WATER METER 7 AMP VAULT

# REFER TO ELECTRICAL SHEETS FOR ADDITIONAL

14 WATER PULL BOX 15 ELECTRICAL PULL BOX

13 TELEPHONE PULL BOX

- 16 FIRE HYDRANT

8 GAS METER

11 GAS VALVE

12 TV PULL BOX

9 SEWER CLEANOUT

10 ELECTRIC METER

JOINT POWER/TELEPHONE POLE

## **UTILITY OWNERS**

AMP - ALAMEDA MUNICIPAL POWER AT&T - AT&T COMMUNICATIONS CC - COMCAST

COA - CITY OF ALAMEDA

EBMUD - EAST BAY MUNICIPAL UTILITY DISTRICT

PG&E - PACIFIC GAS AND ELECTRIC

## 65 % REVIEW SUBMITTAL

DRAWING NO.

UT-3

A ADJUST

RE REMOVE

RL RELOCATE

P PROTECT - IN - PLACE

SD REFER TO STORMWATER SHEETS FOR ADDITIONAL

TRAFFIC SIGNAL AND LIGHTING INFORMATION

STORM DRAIN INFORMATION

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118 OF 262


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				CHECKED RY
				APPROVED

ONE INCH AT FULL SCALE. IF NOT, SCALE ACCORDINGLY	
FILE NAME SF8939003C-UT	
JOB No. C65700	
DATE 06/2025	

**Parametrix** P 510.343.6400 WWW.PARAMETRIX.COM

**CITY OF ALAMEDA** CORRIDOR SAFETY IMPROVEMENT PROJECT LINCOLN AVE | MARSHALL WAY | PACIFIC AVE

**UTILITY PLAN** 

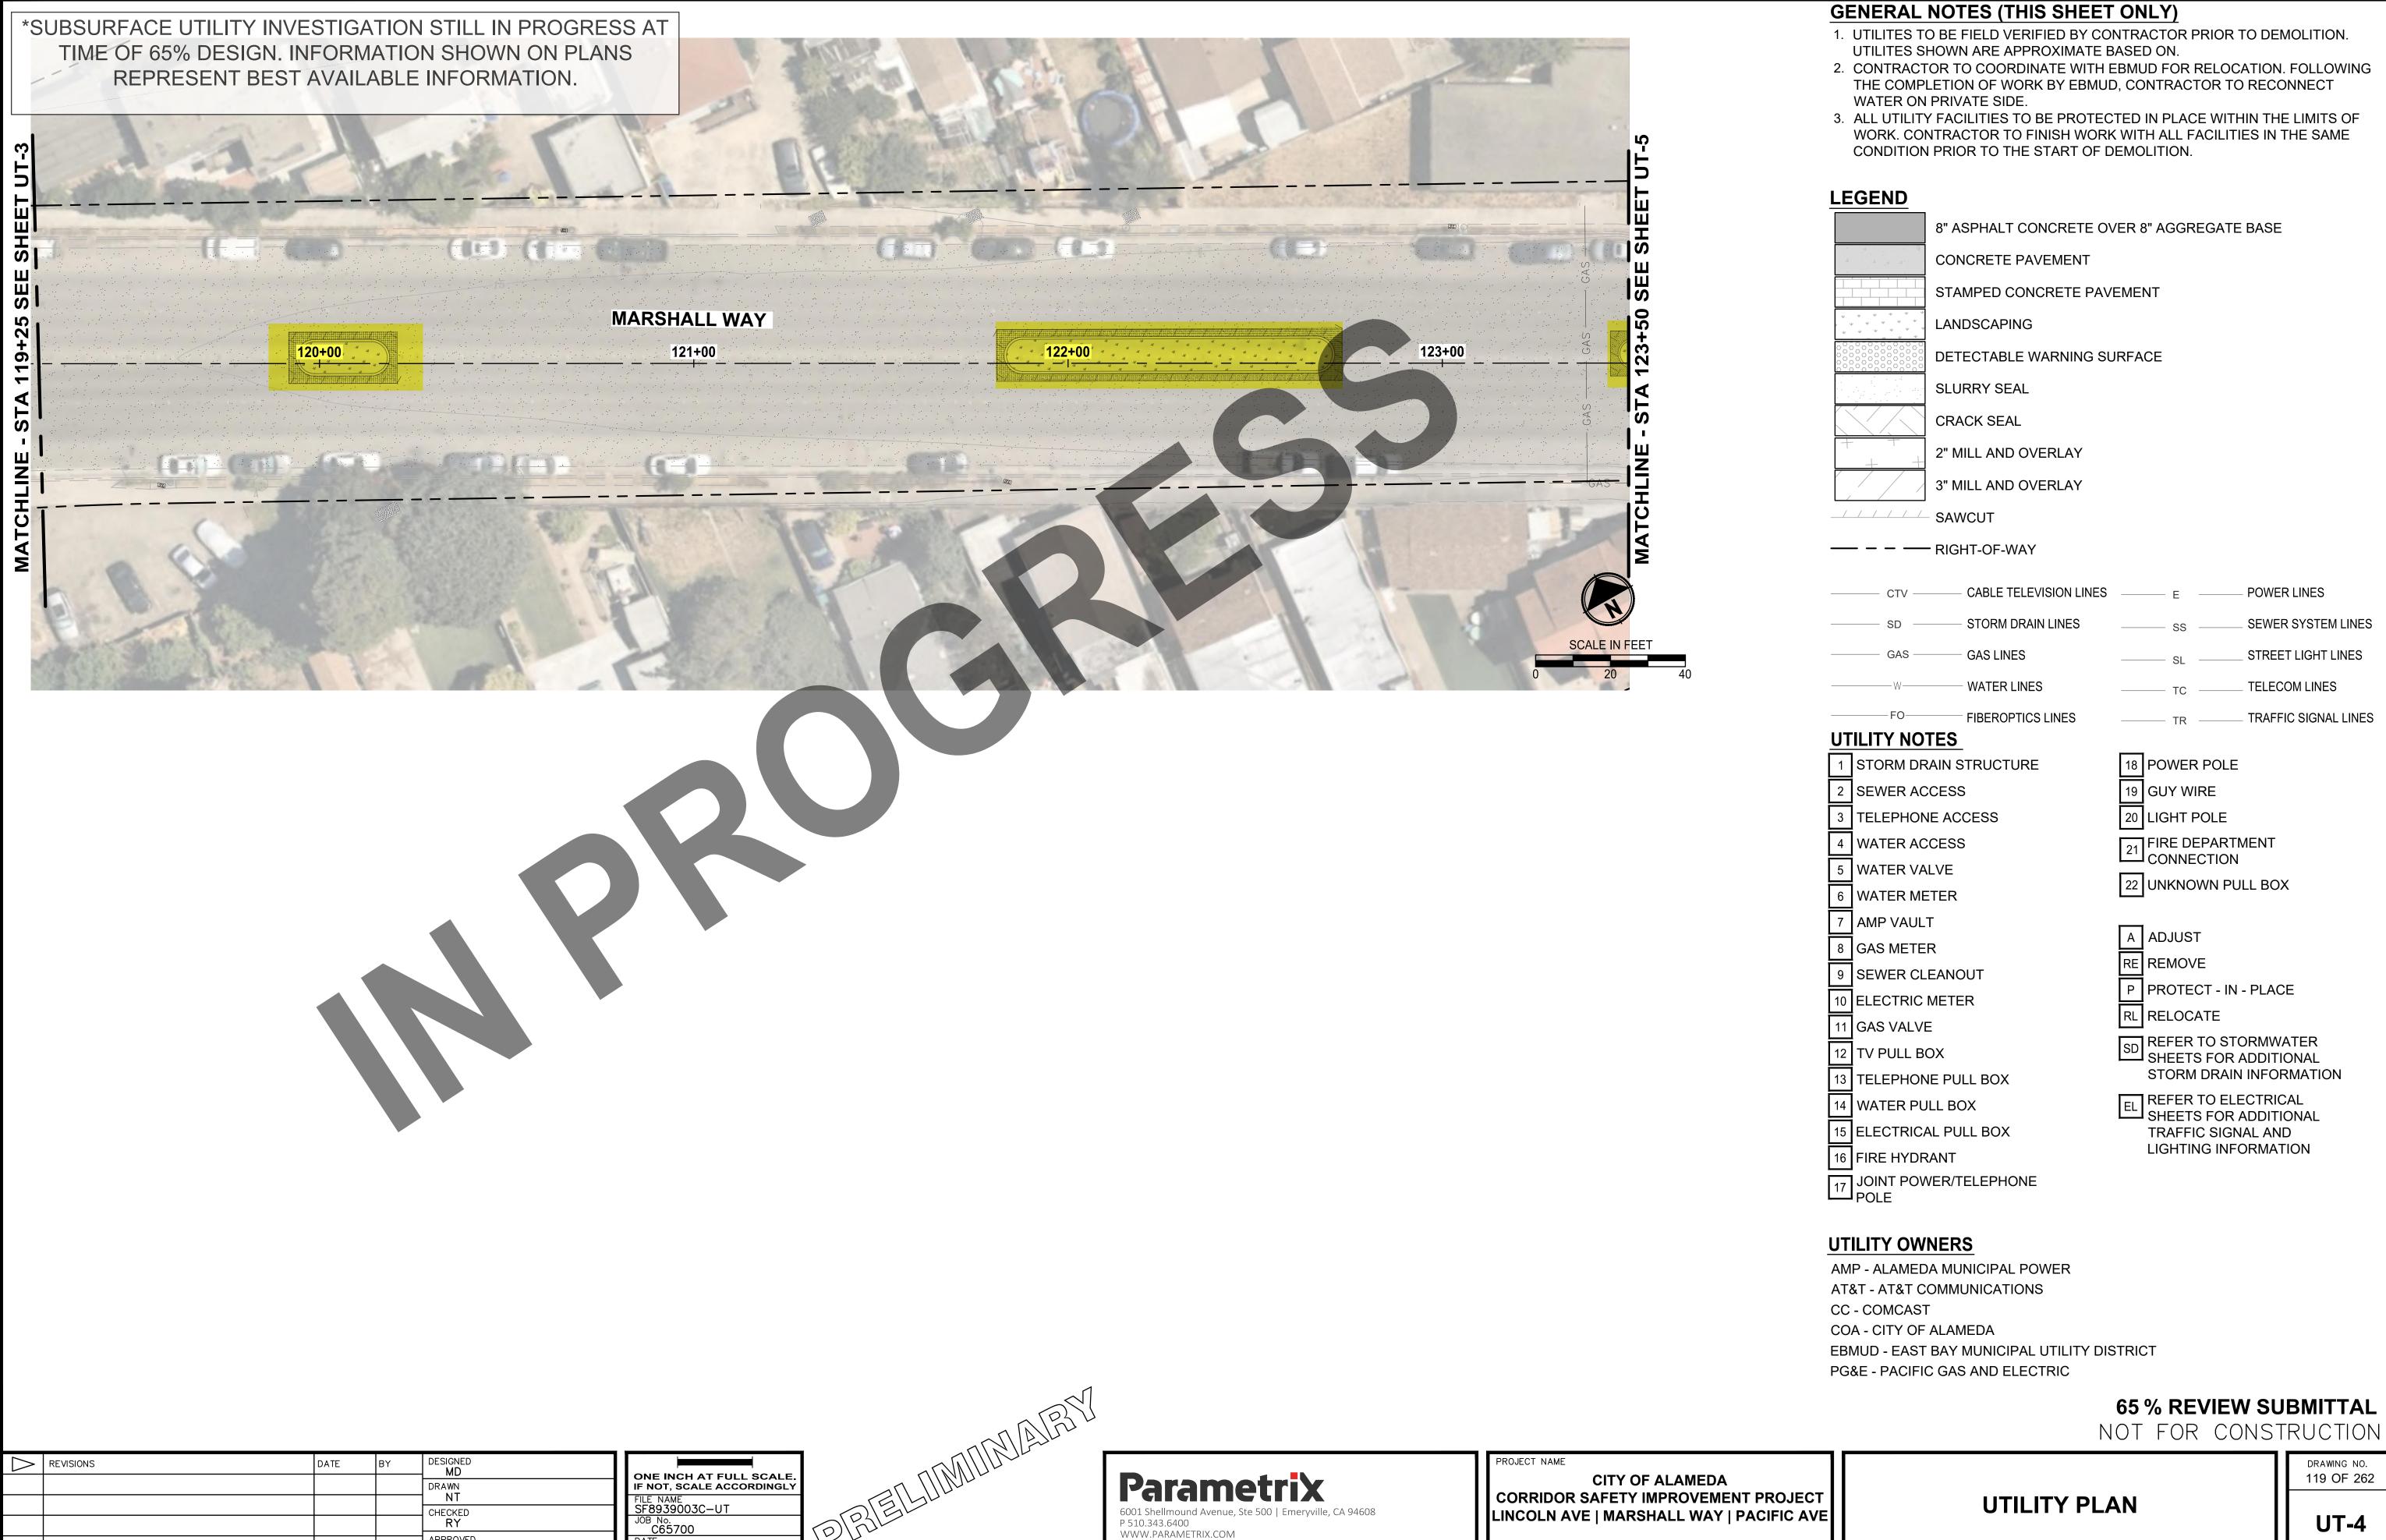

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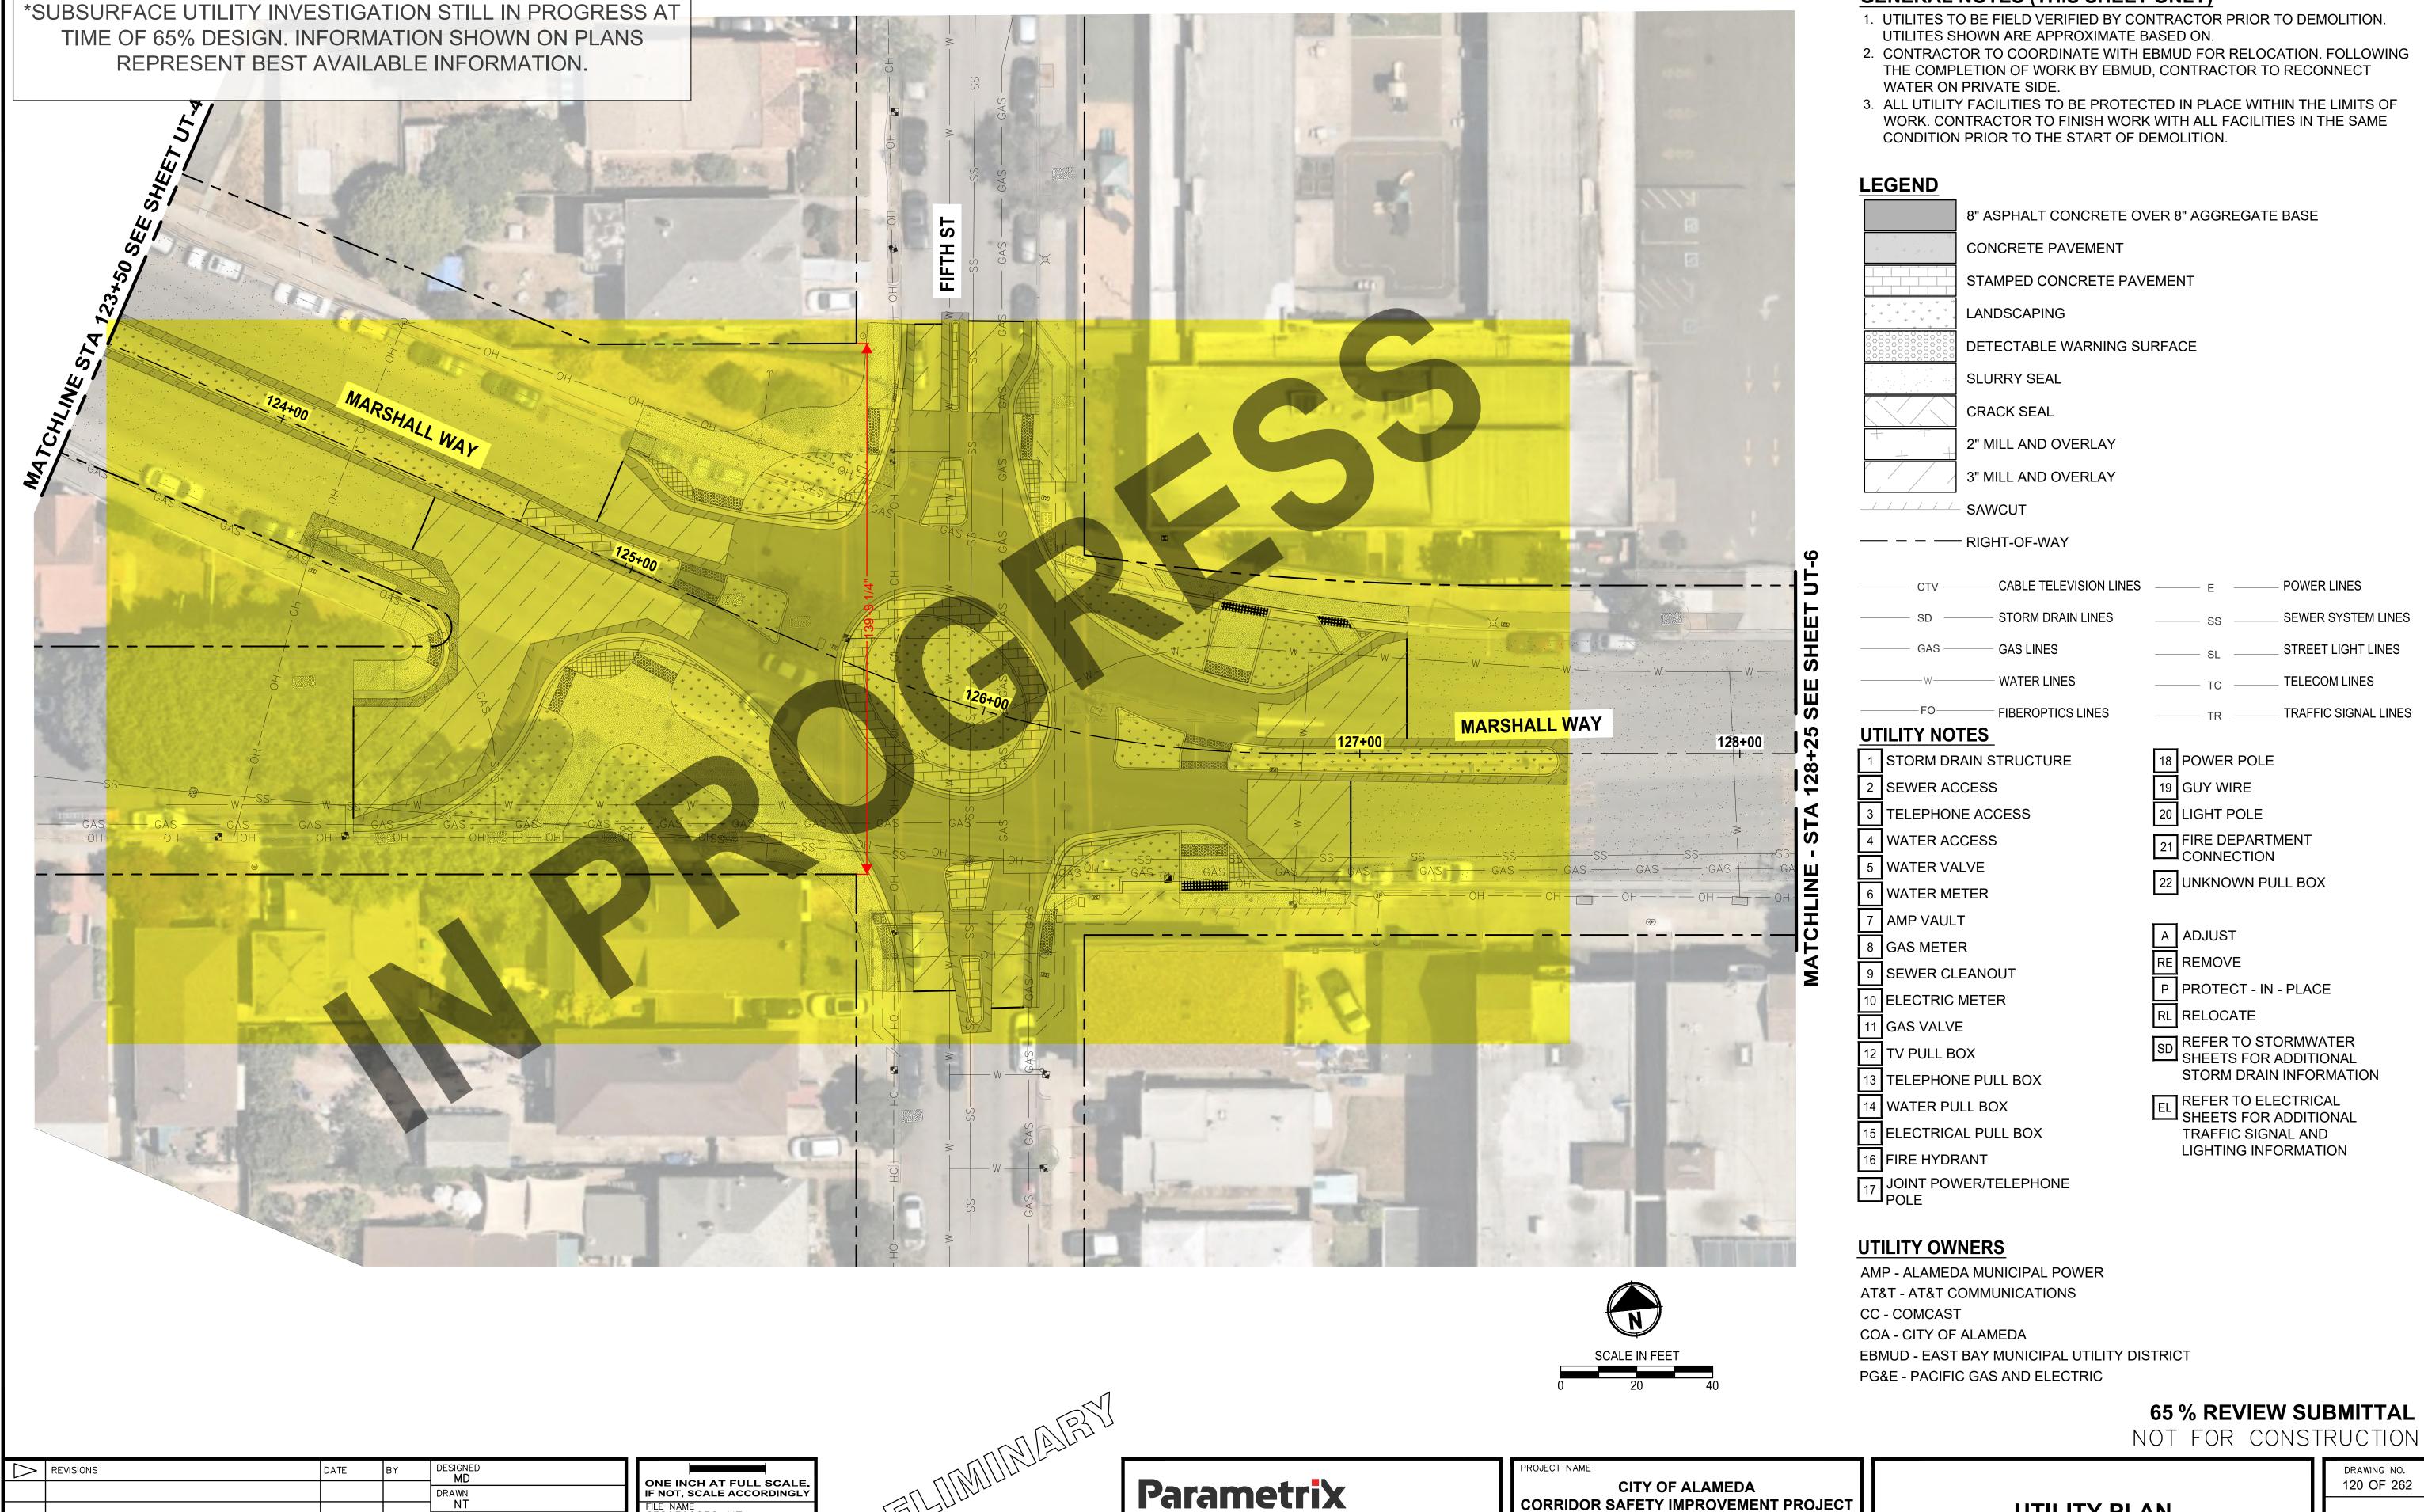
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DATE 06/2025

DRAWING NO. 119 OF 262

**UTILITY PLAN** 

LINCOLN AVE | MARSHALL WAY | PACIFIC AVE



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APPROVED **DP** 

FILE NAME SF8939003C-UT JOB No. C65700

DATE 06/2025


**UTILITY PLAN** 

CORRIDOR SAFETY IMPROVEMENT PROJECT

LINCOLN AVE | MARSHALL WAY | PACIFIC AVE

**GENERAL NOTES (THIS SHEET ONLY)** 

120 OF 262

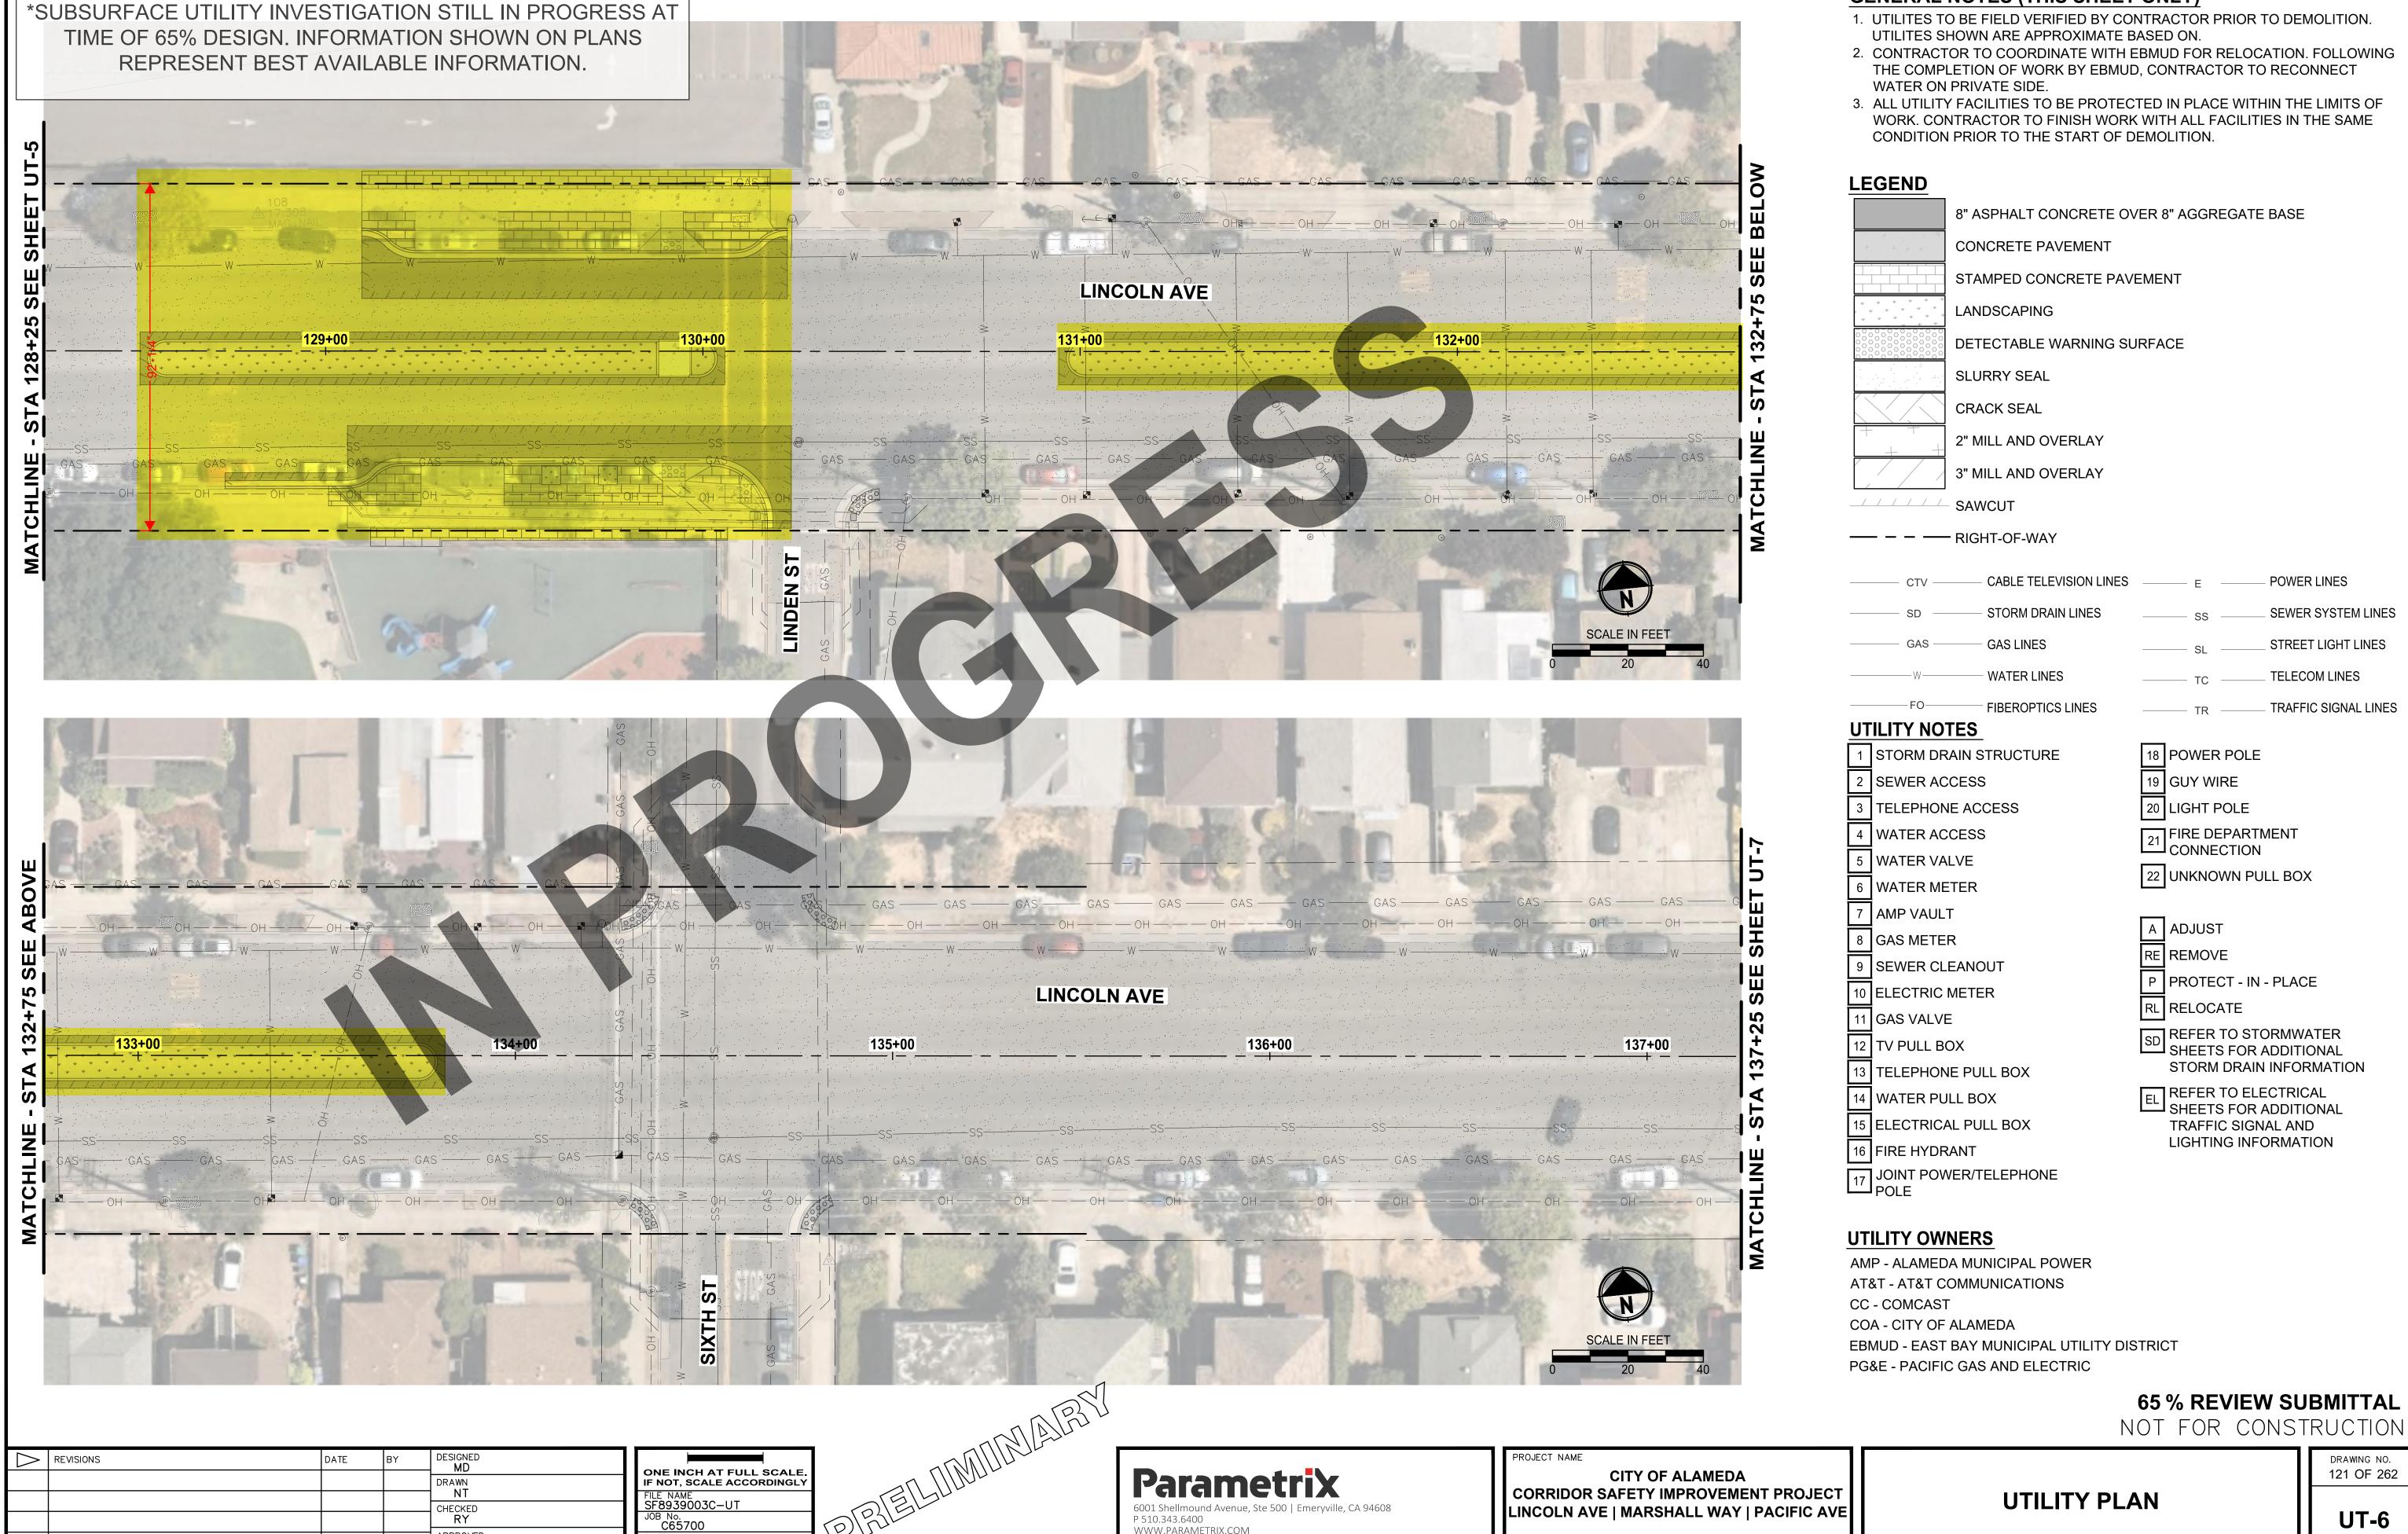

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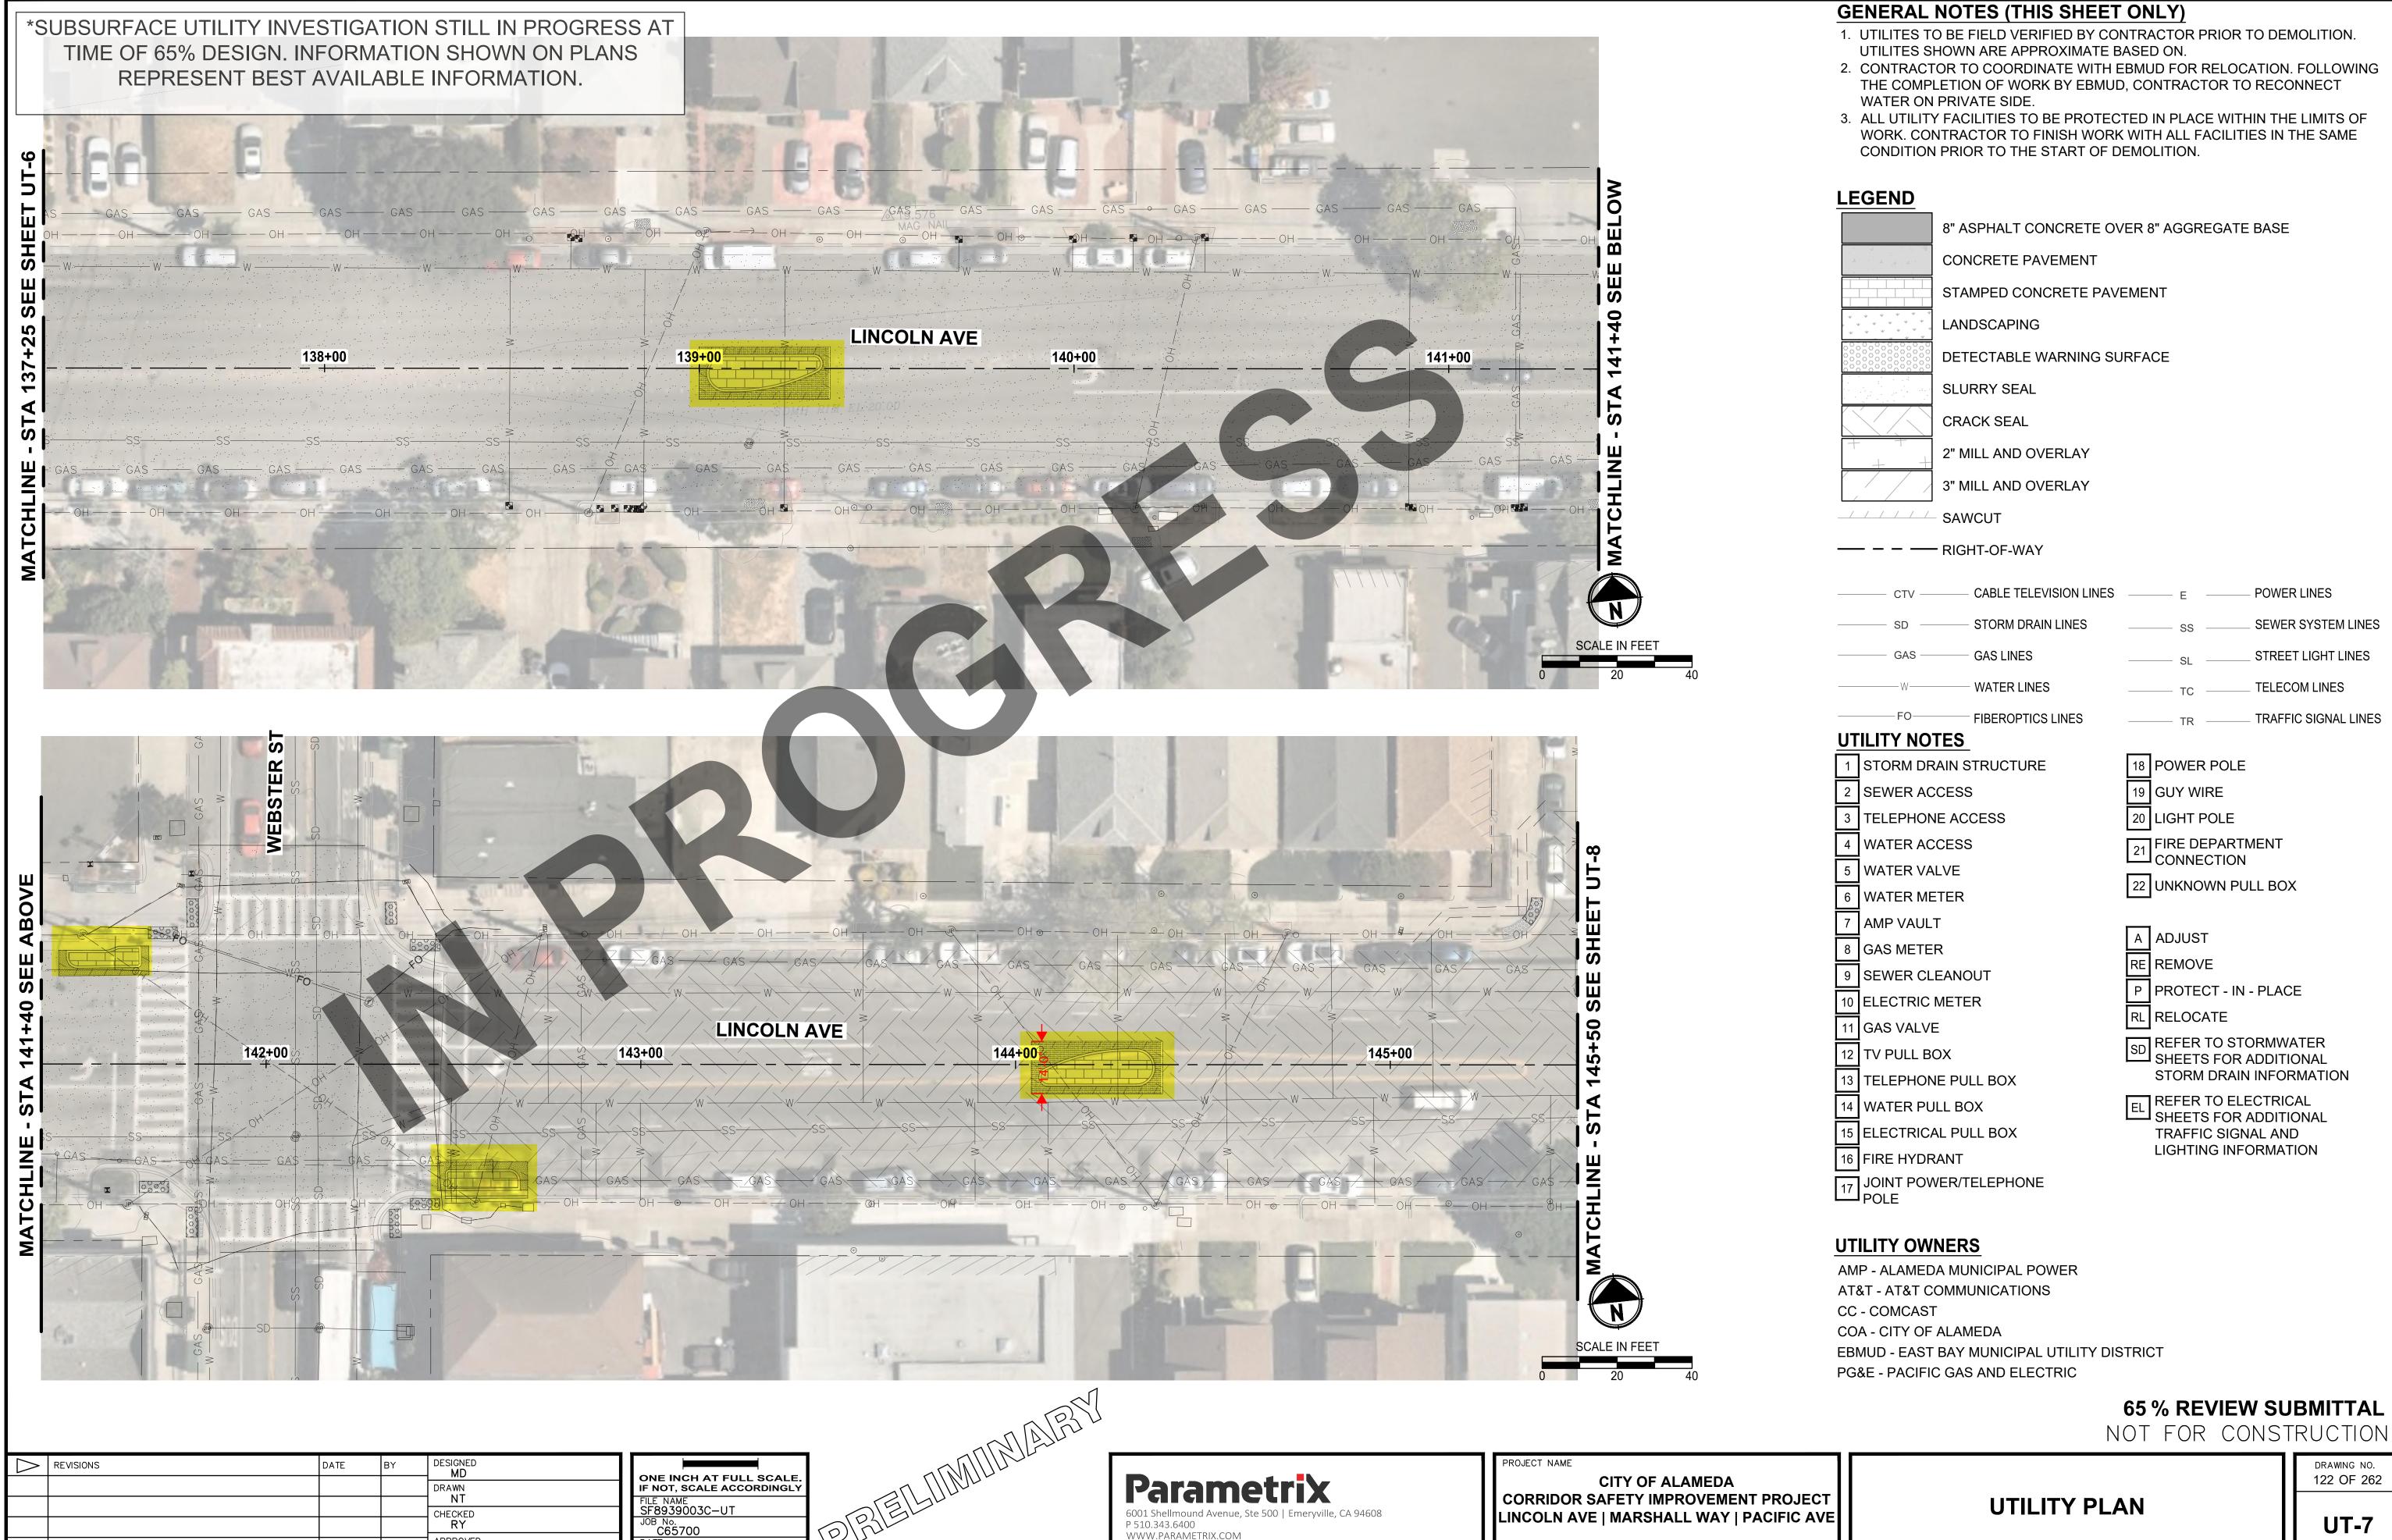
APPROVED DP

DATE 06/2025

**UTILITY PLAN** 

LINCOLN AVE | MARSHALL WAY | PACIFIC AVE

**GENERAL NOTES (THIS SHEET ONLY)** 



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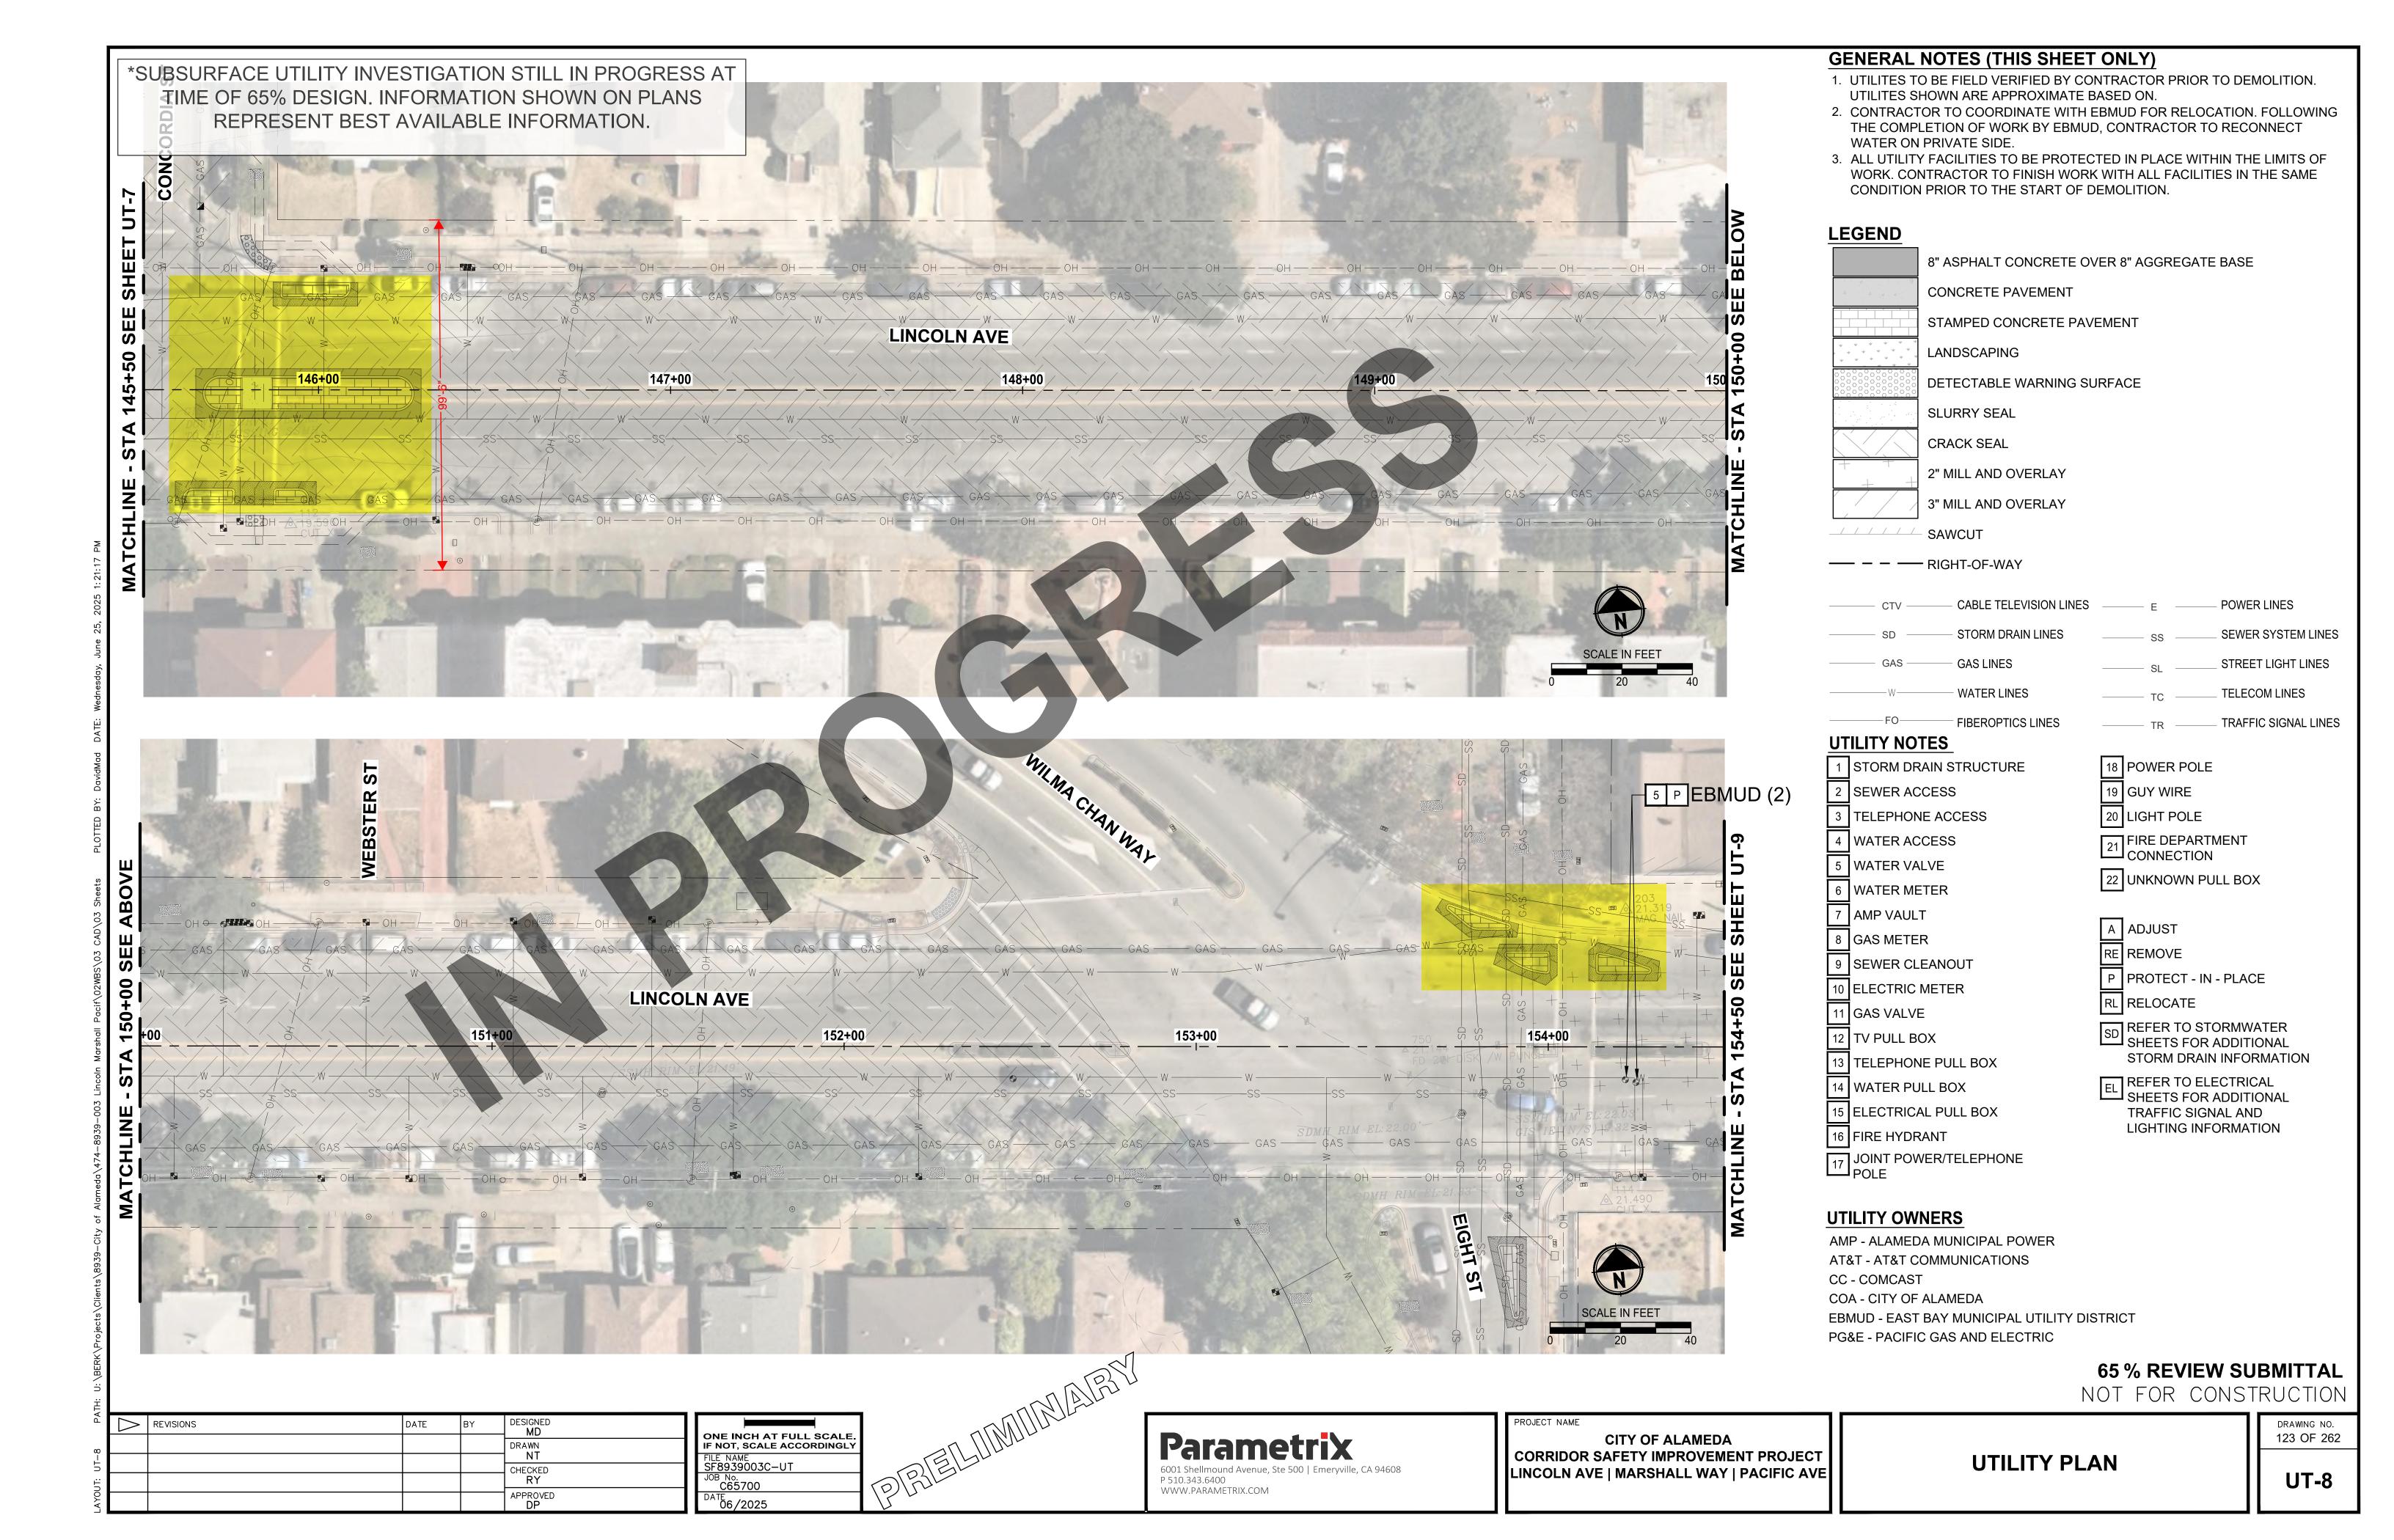
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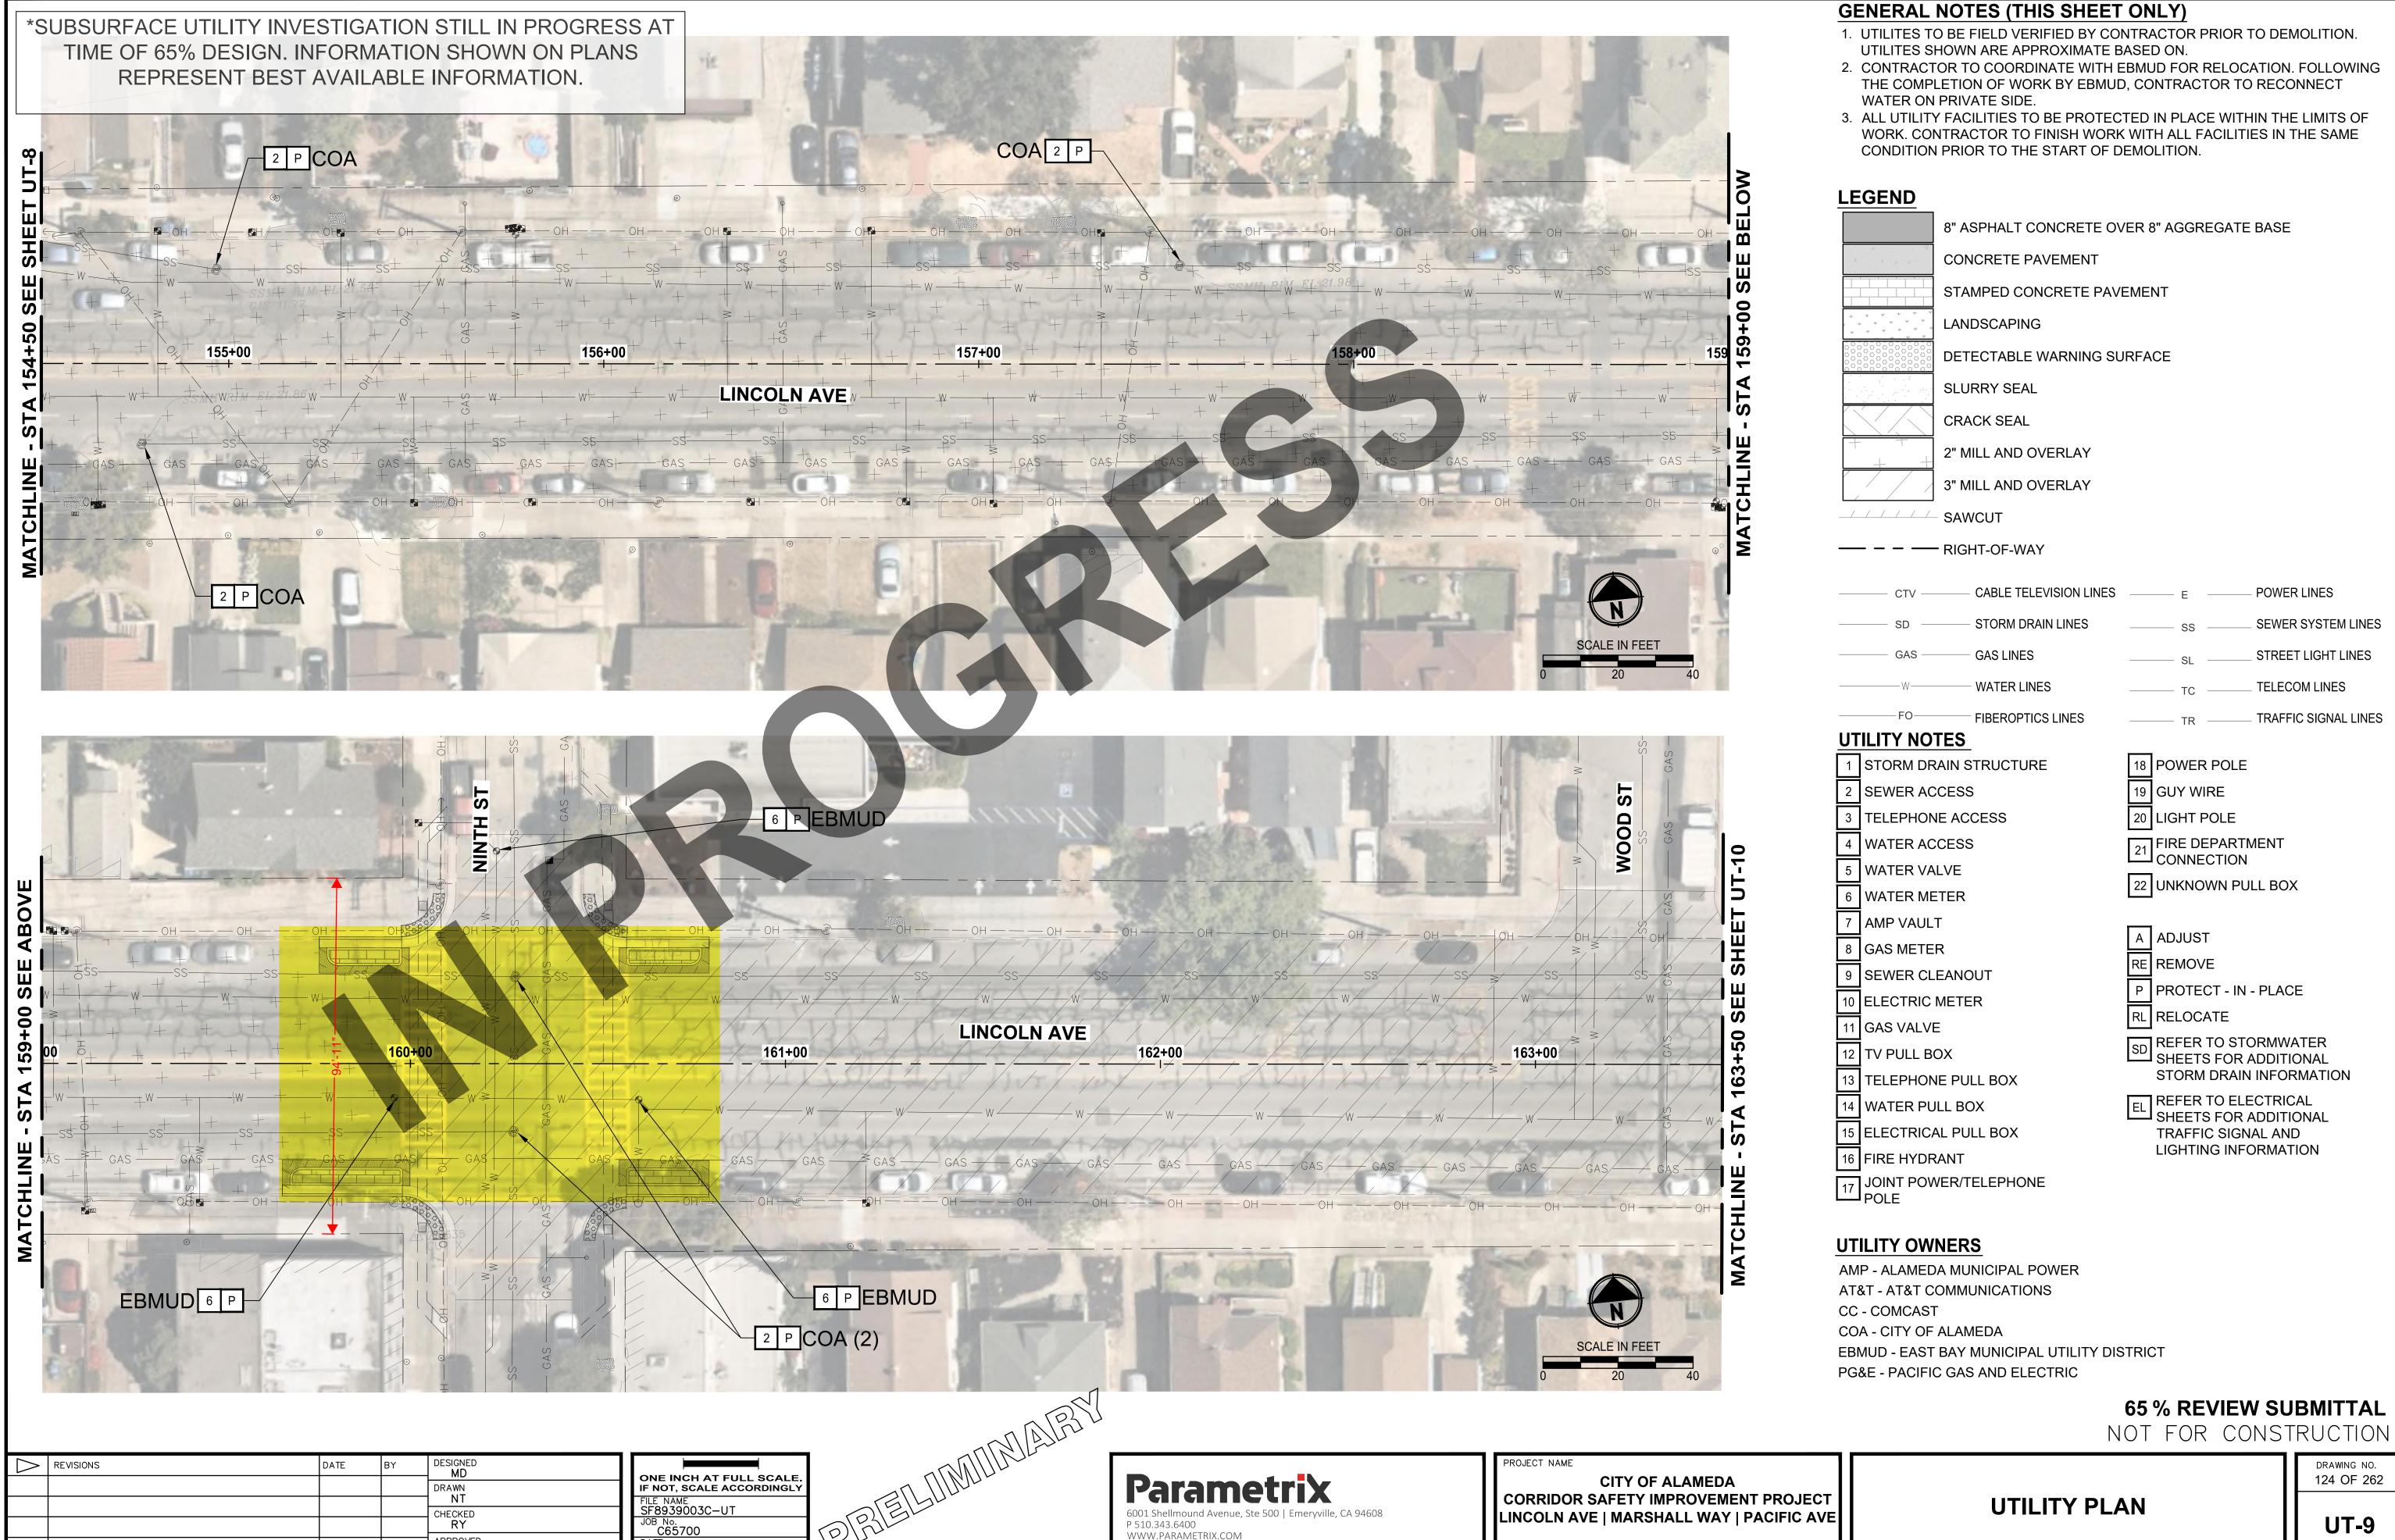
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DATE 06/2025

**UTILITY PLAN** 

LINCOLN AVE | MARSHALL WAY | PACIFIC AVE






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DATE 06/2025

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124 OF 262

**UTILITY PLAN** 




APPROVED DP

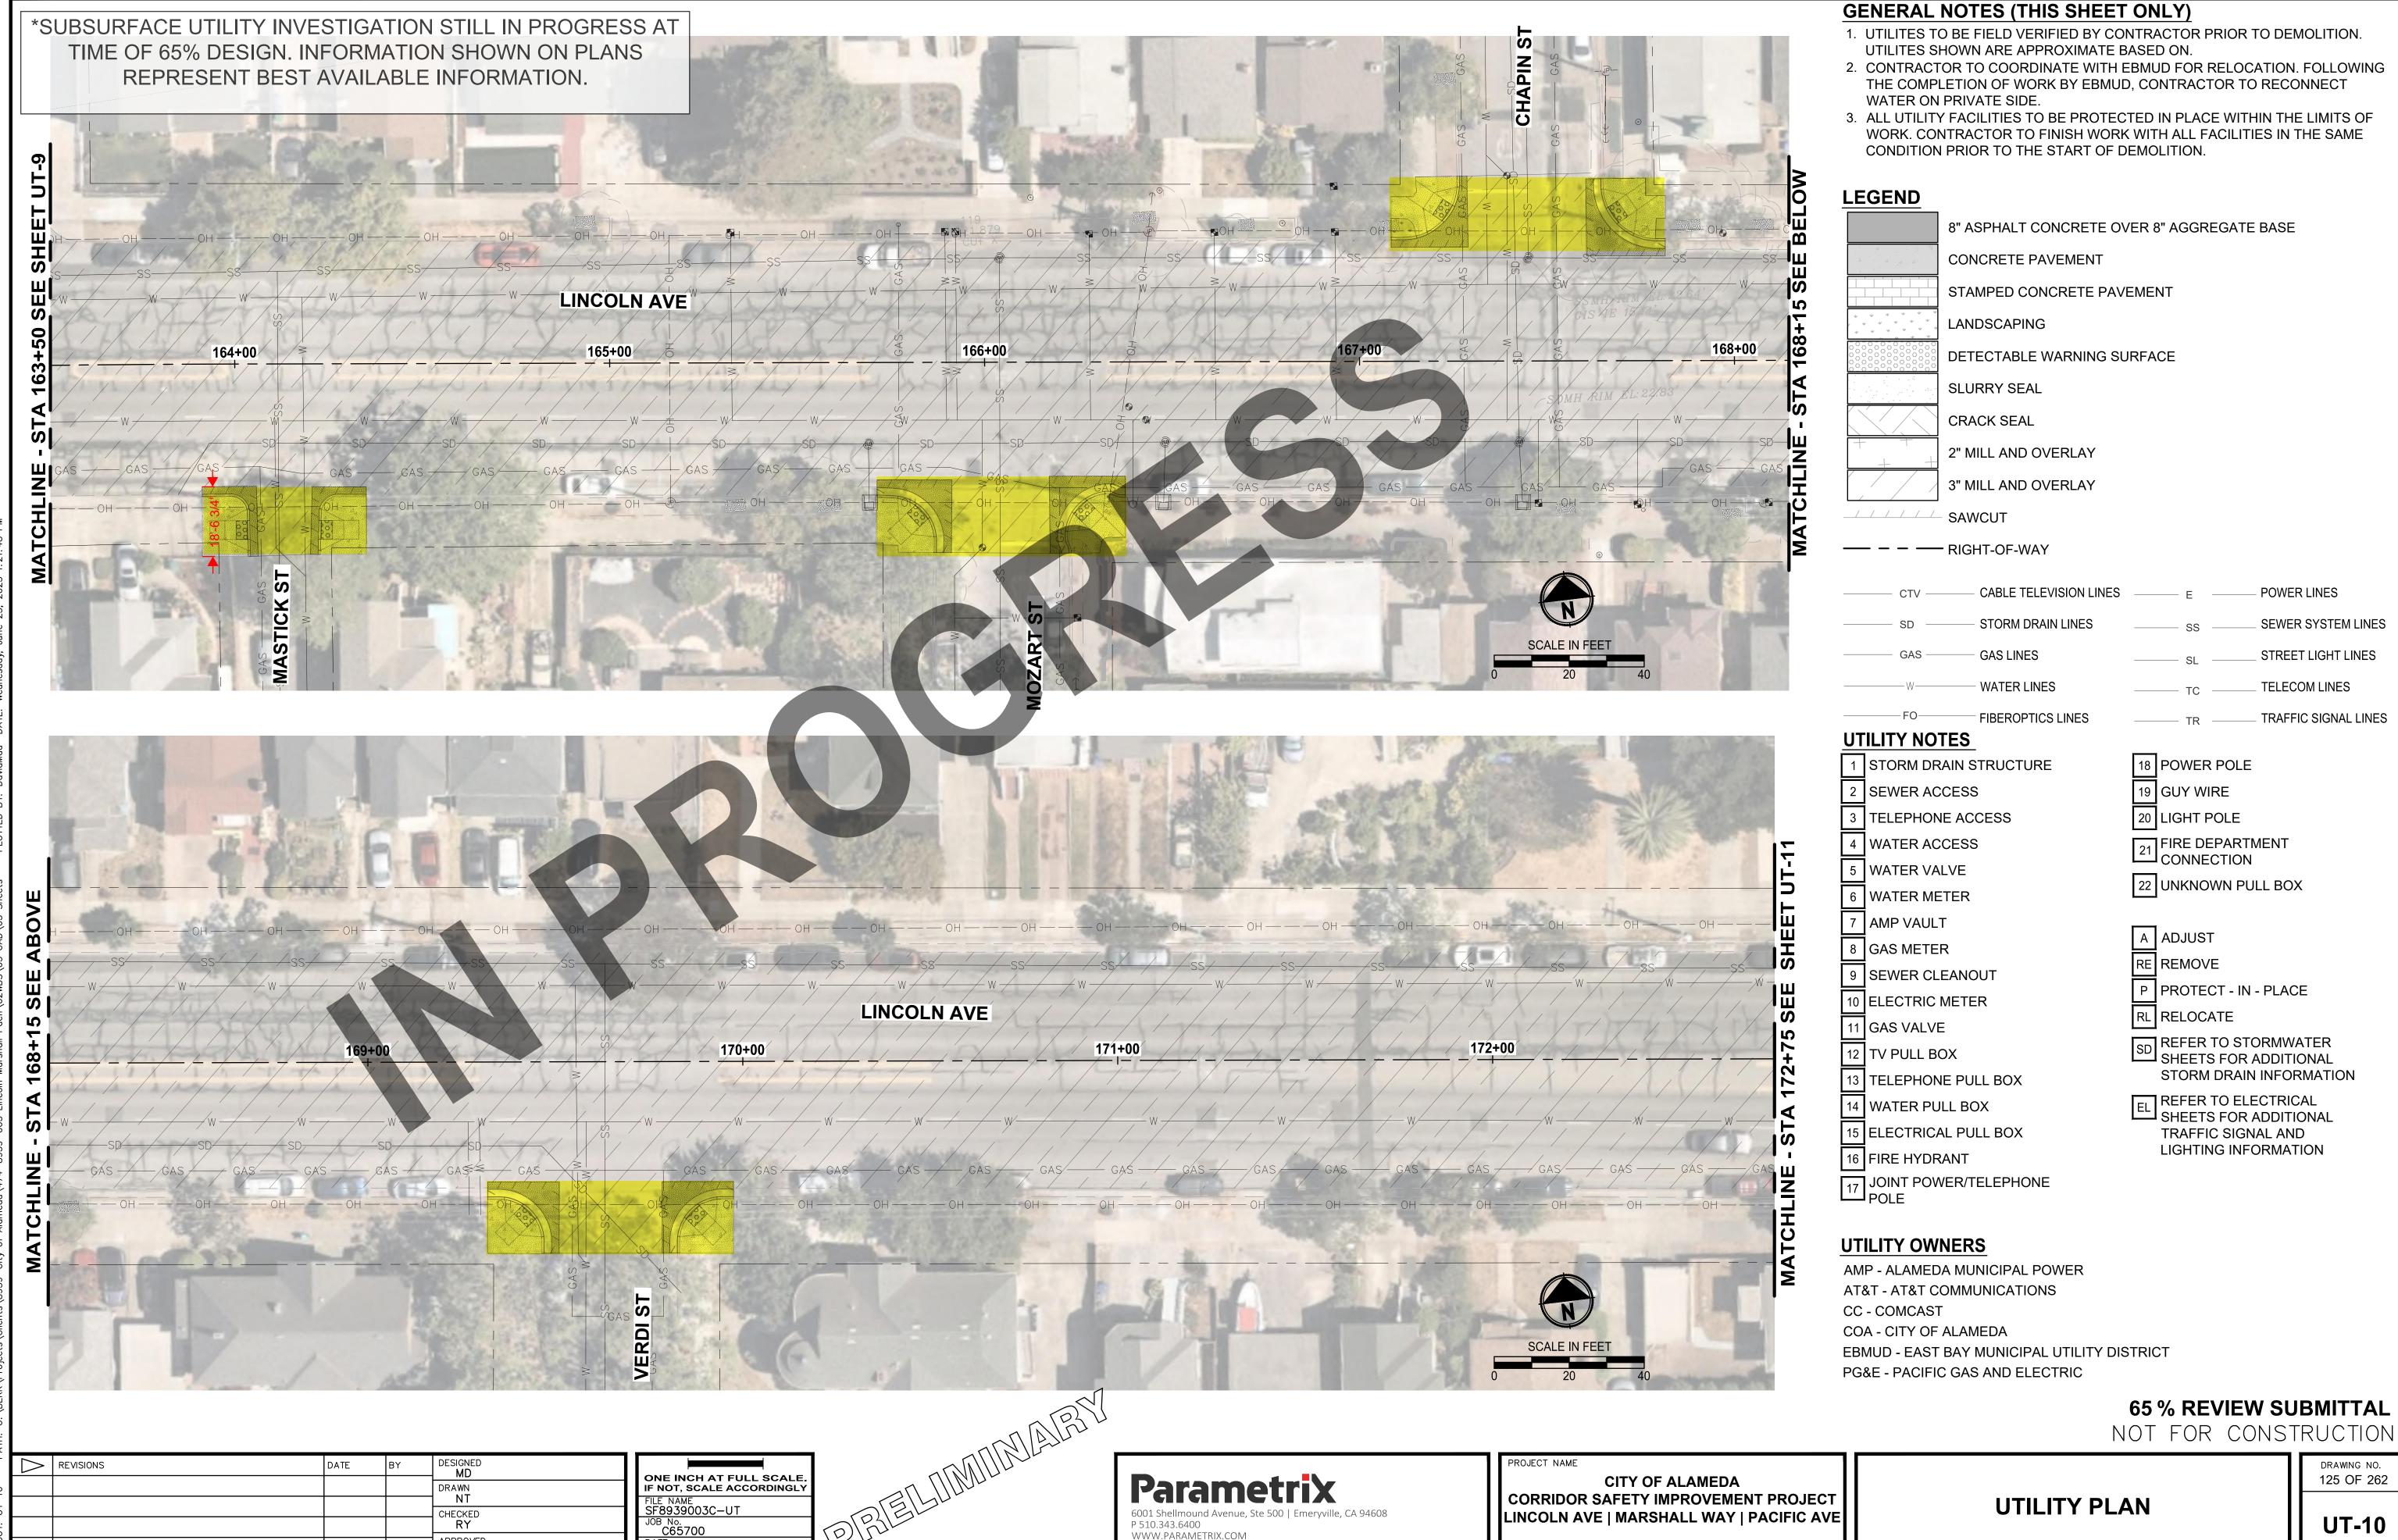DATE 06/2025

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DRAWING NO. 125 OF 262

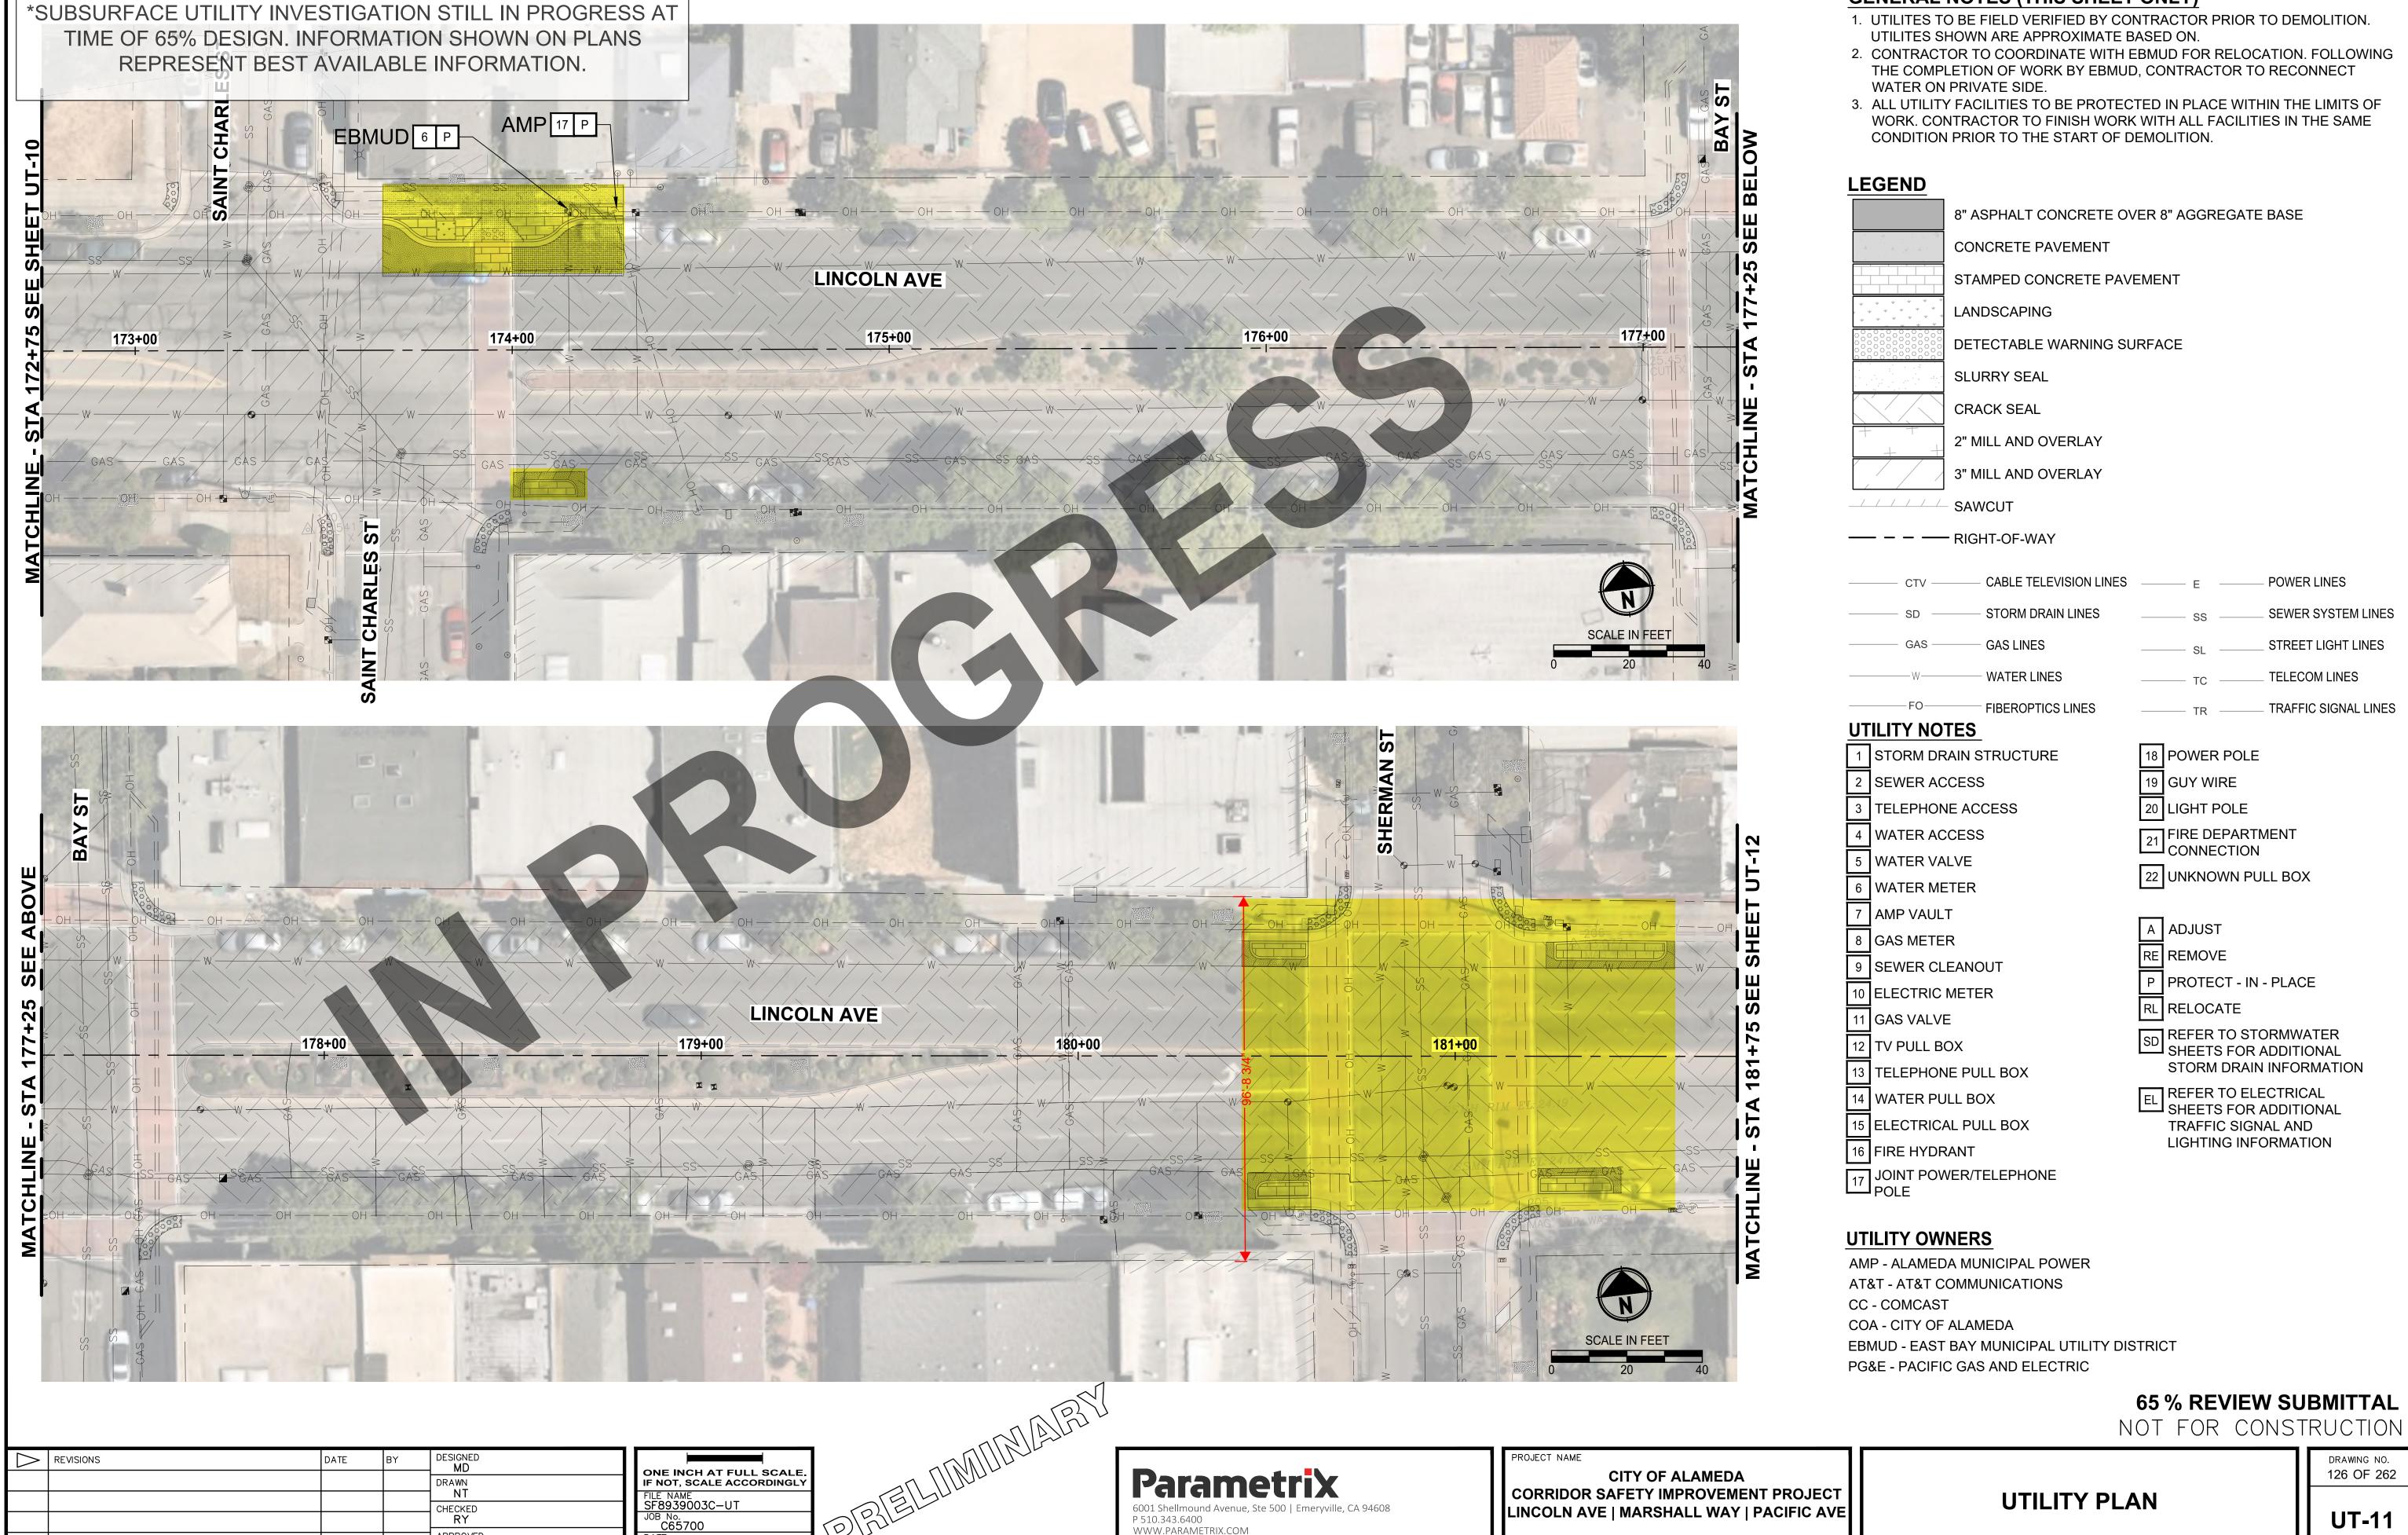

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APPROVED **DP** 


DATE 06/2025

**UTILITY PLAN** 

LINCOLN AVE | MARSHALL WAY | PACIFIC AVE

**GENERAL NOTES (THIS SHEET ONLY)** 

DRAWING NO. 126 OF 262

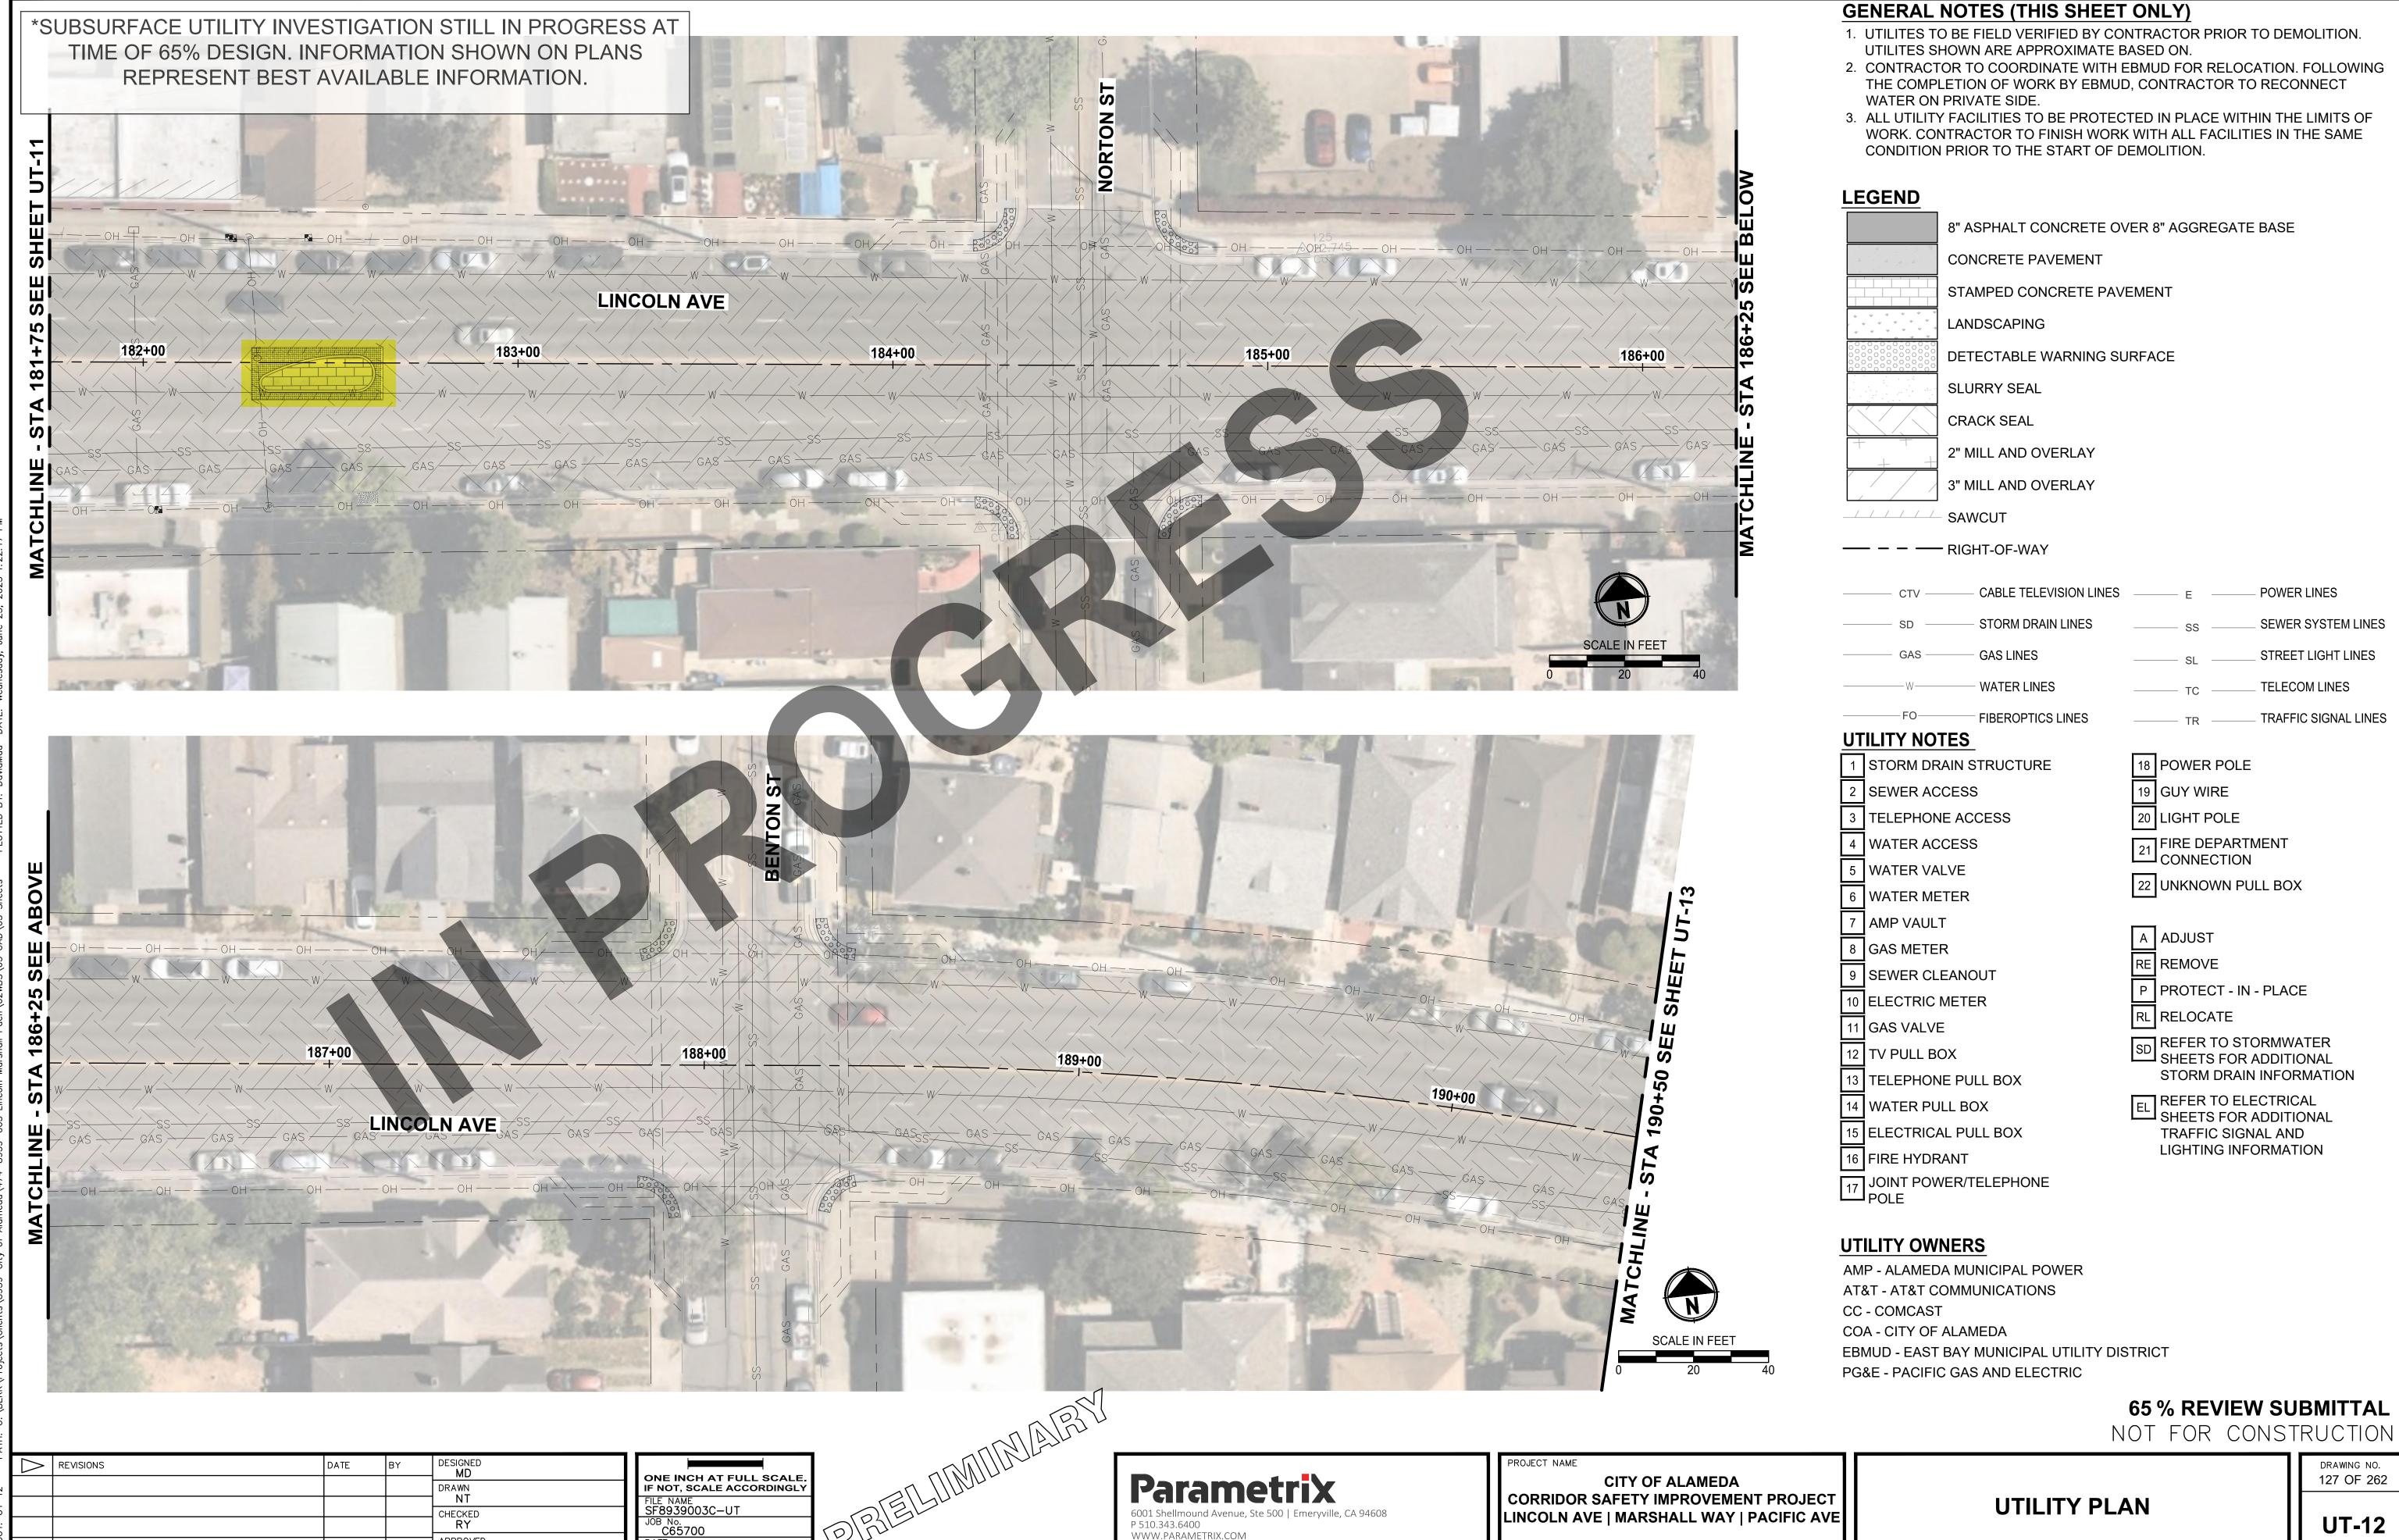


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DATE 06/2025

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FILE NAME SF8939003C-UT JOB No. C65700

DATE 06/2025

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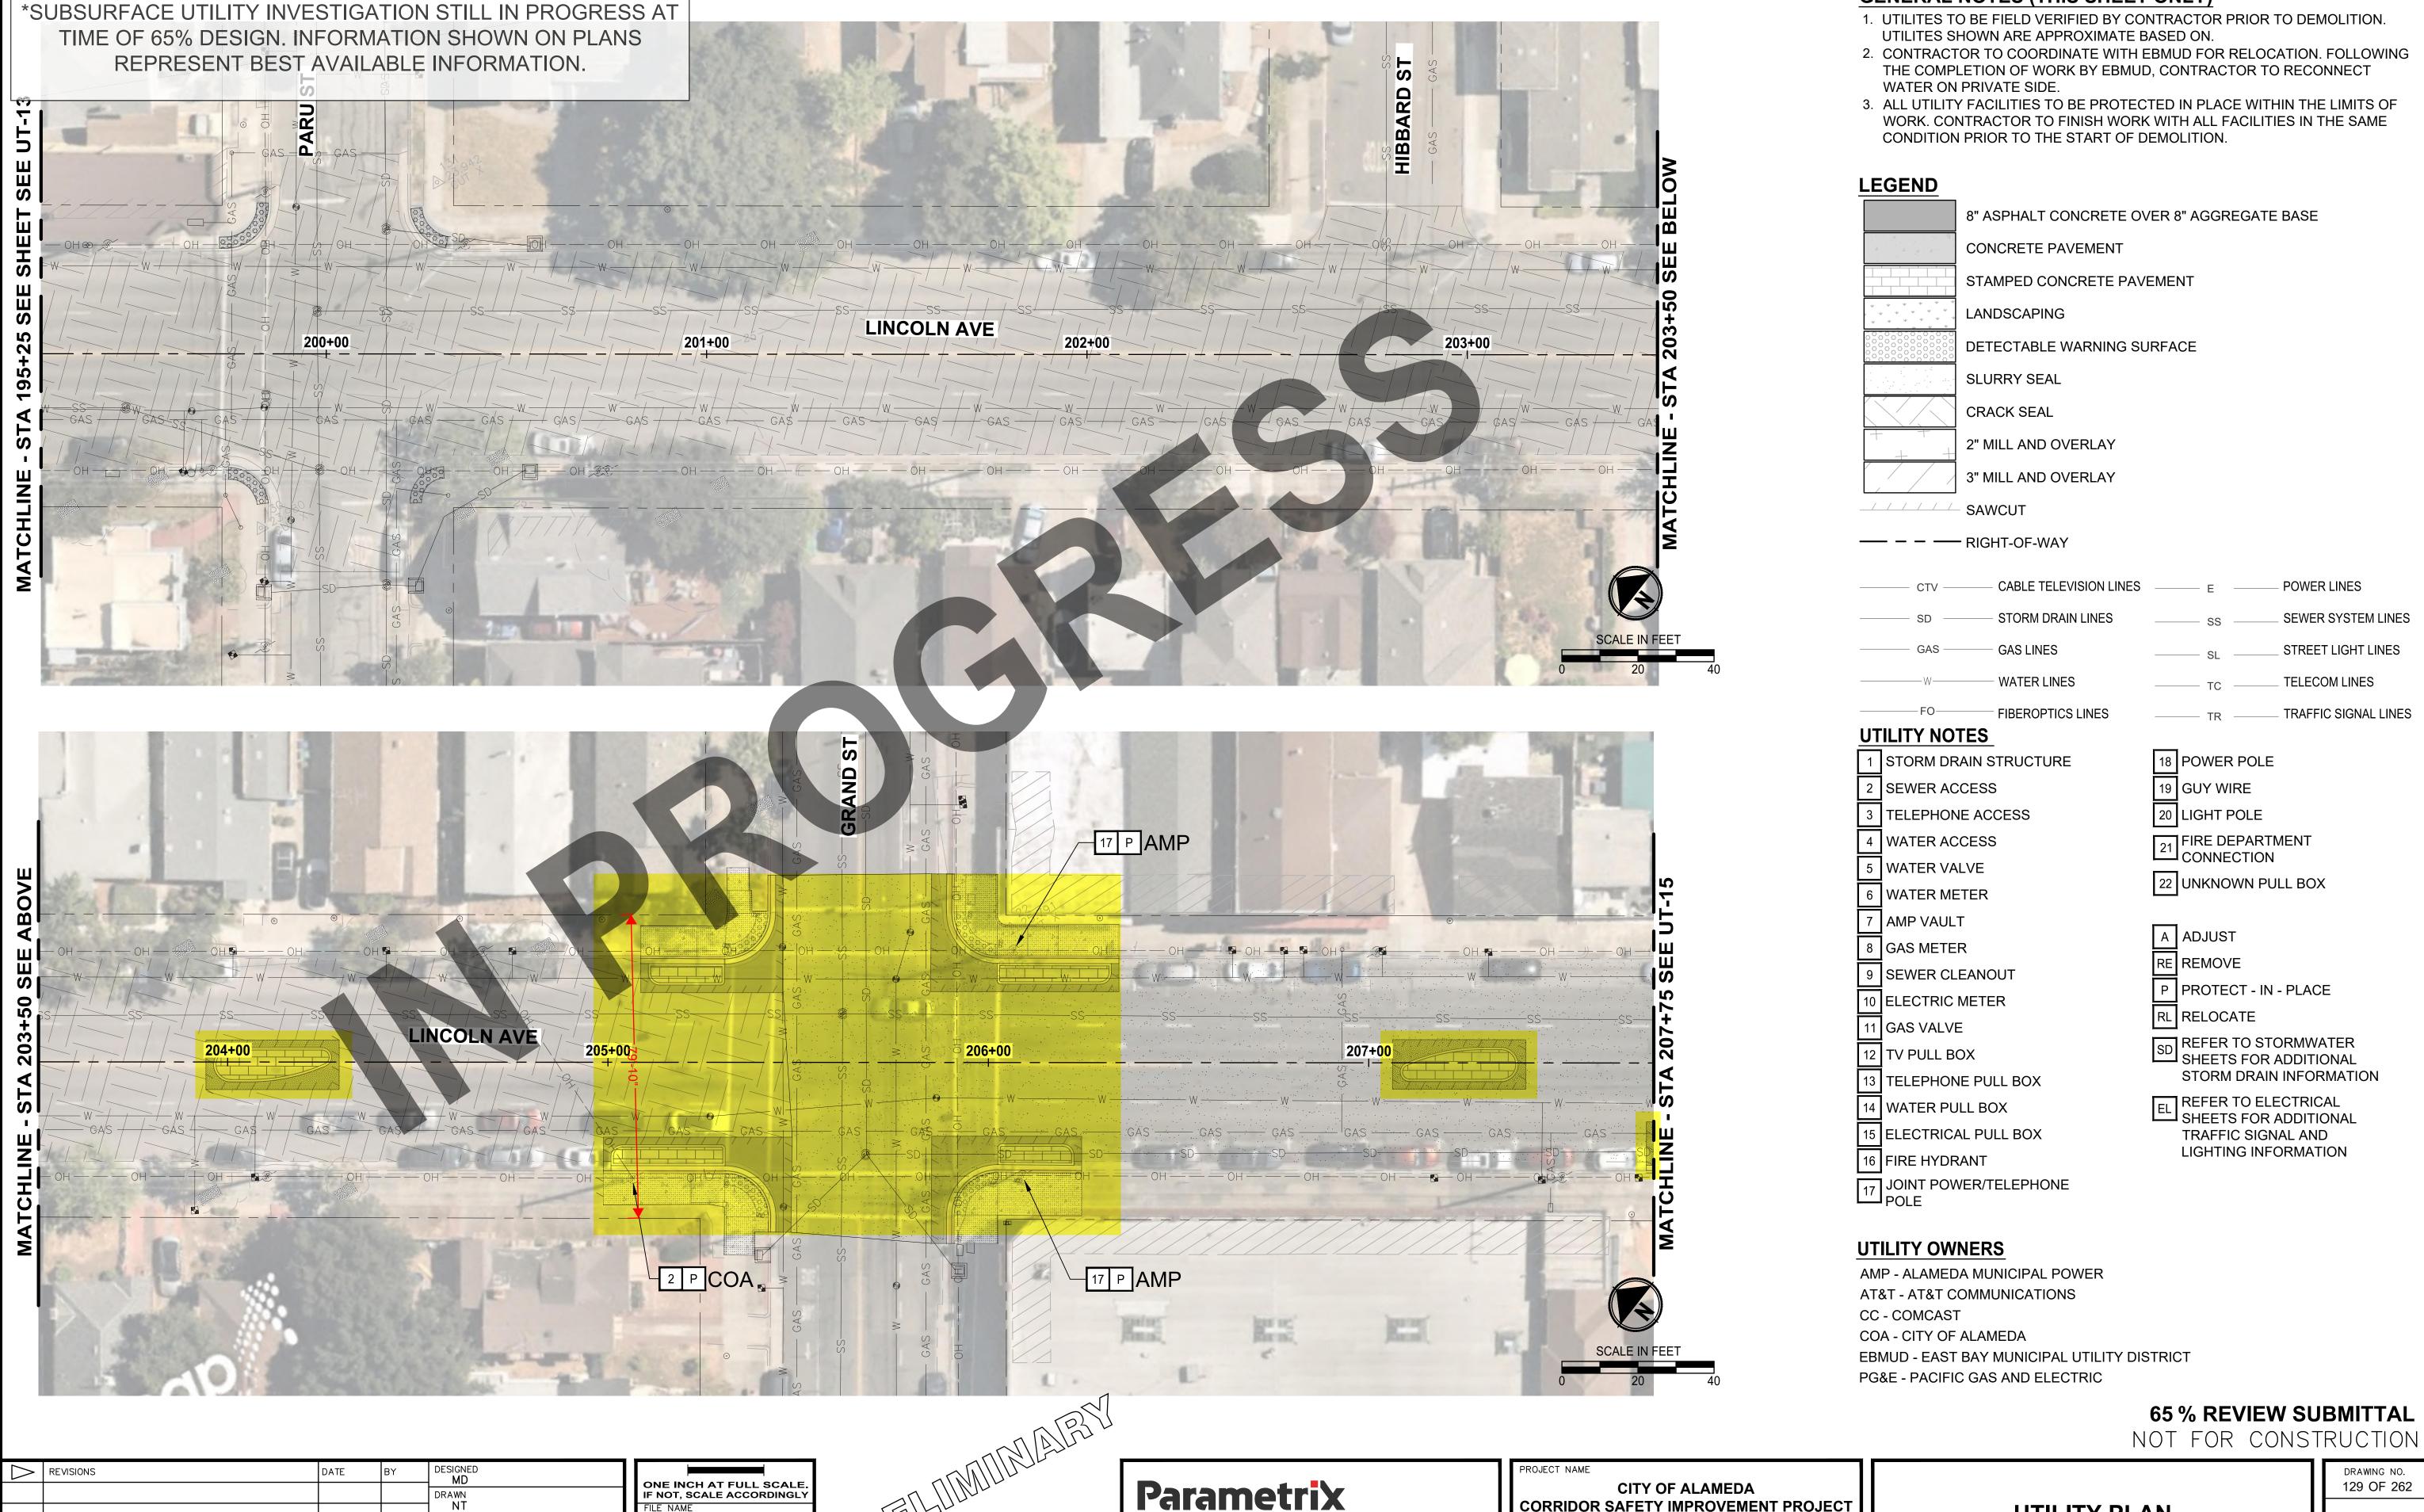
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**UTILITY PLAN** 

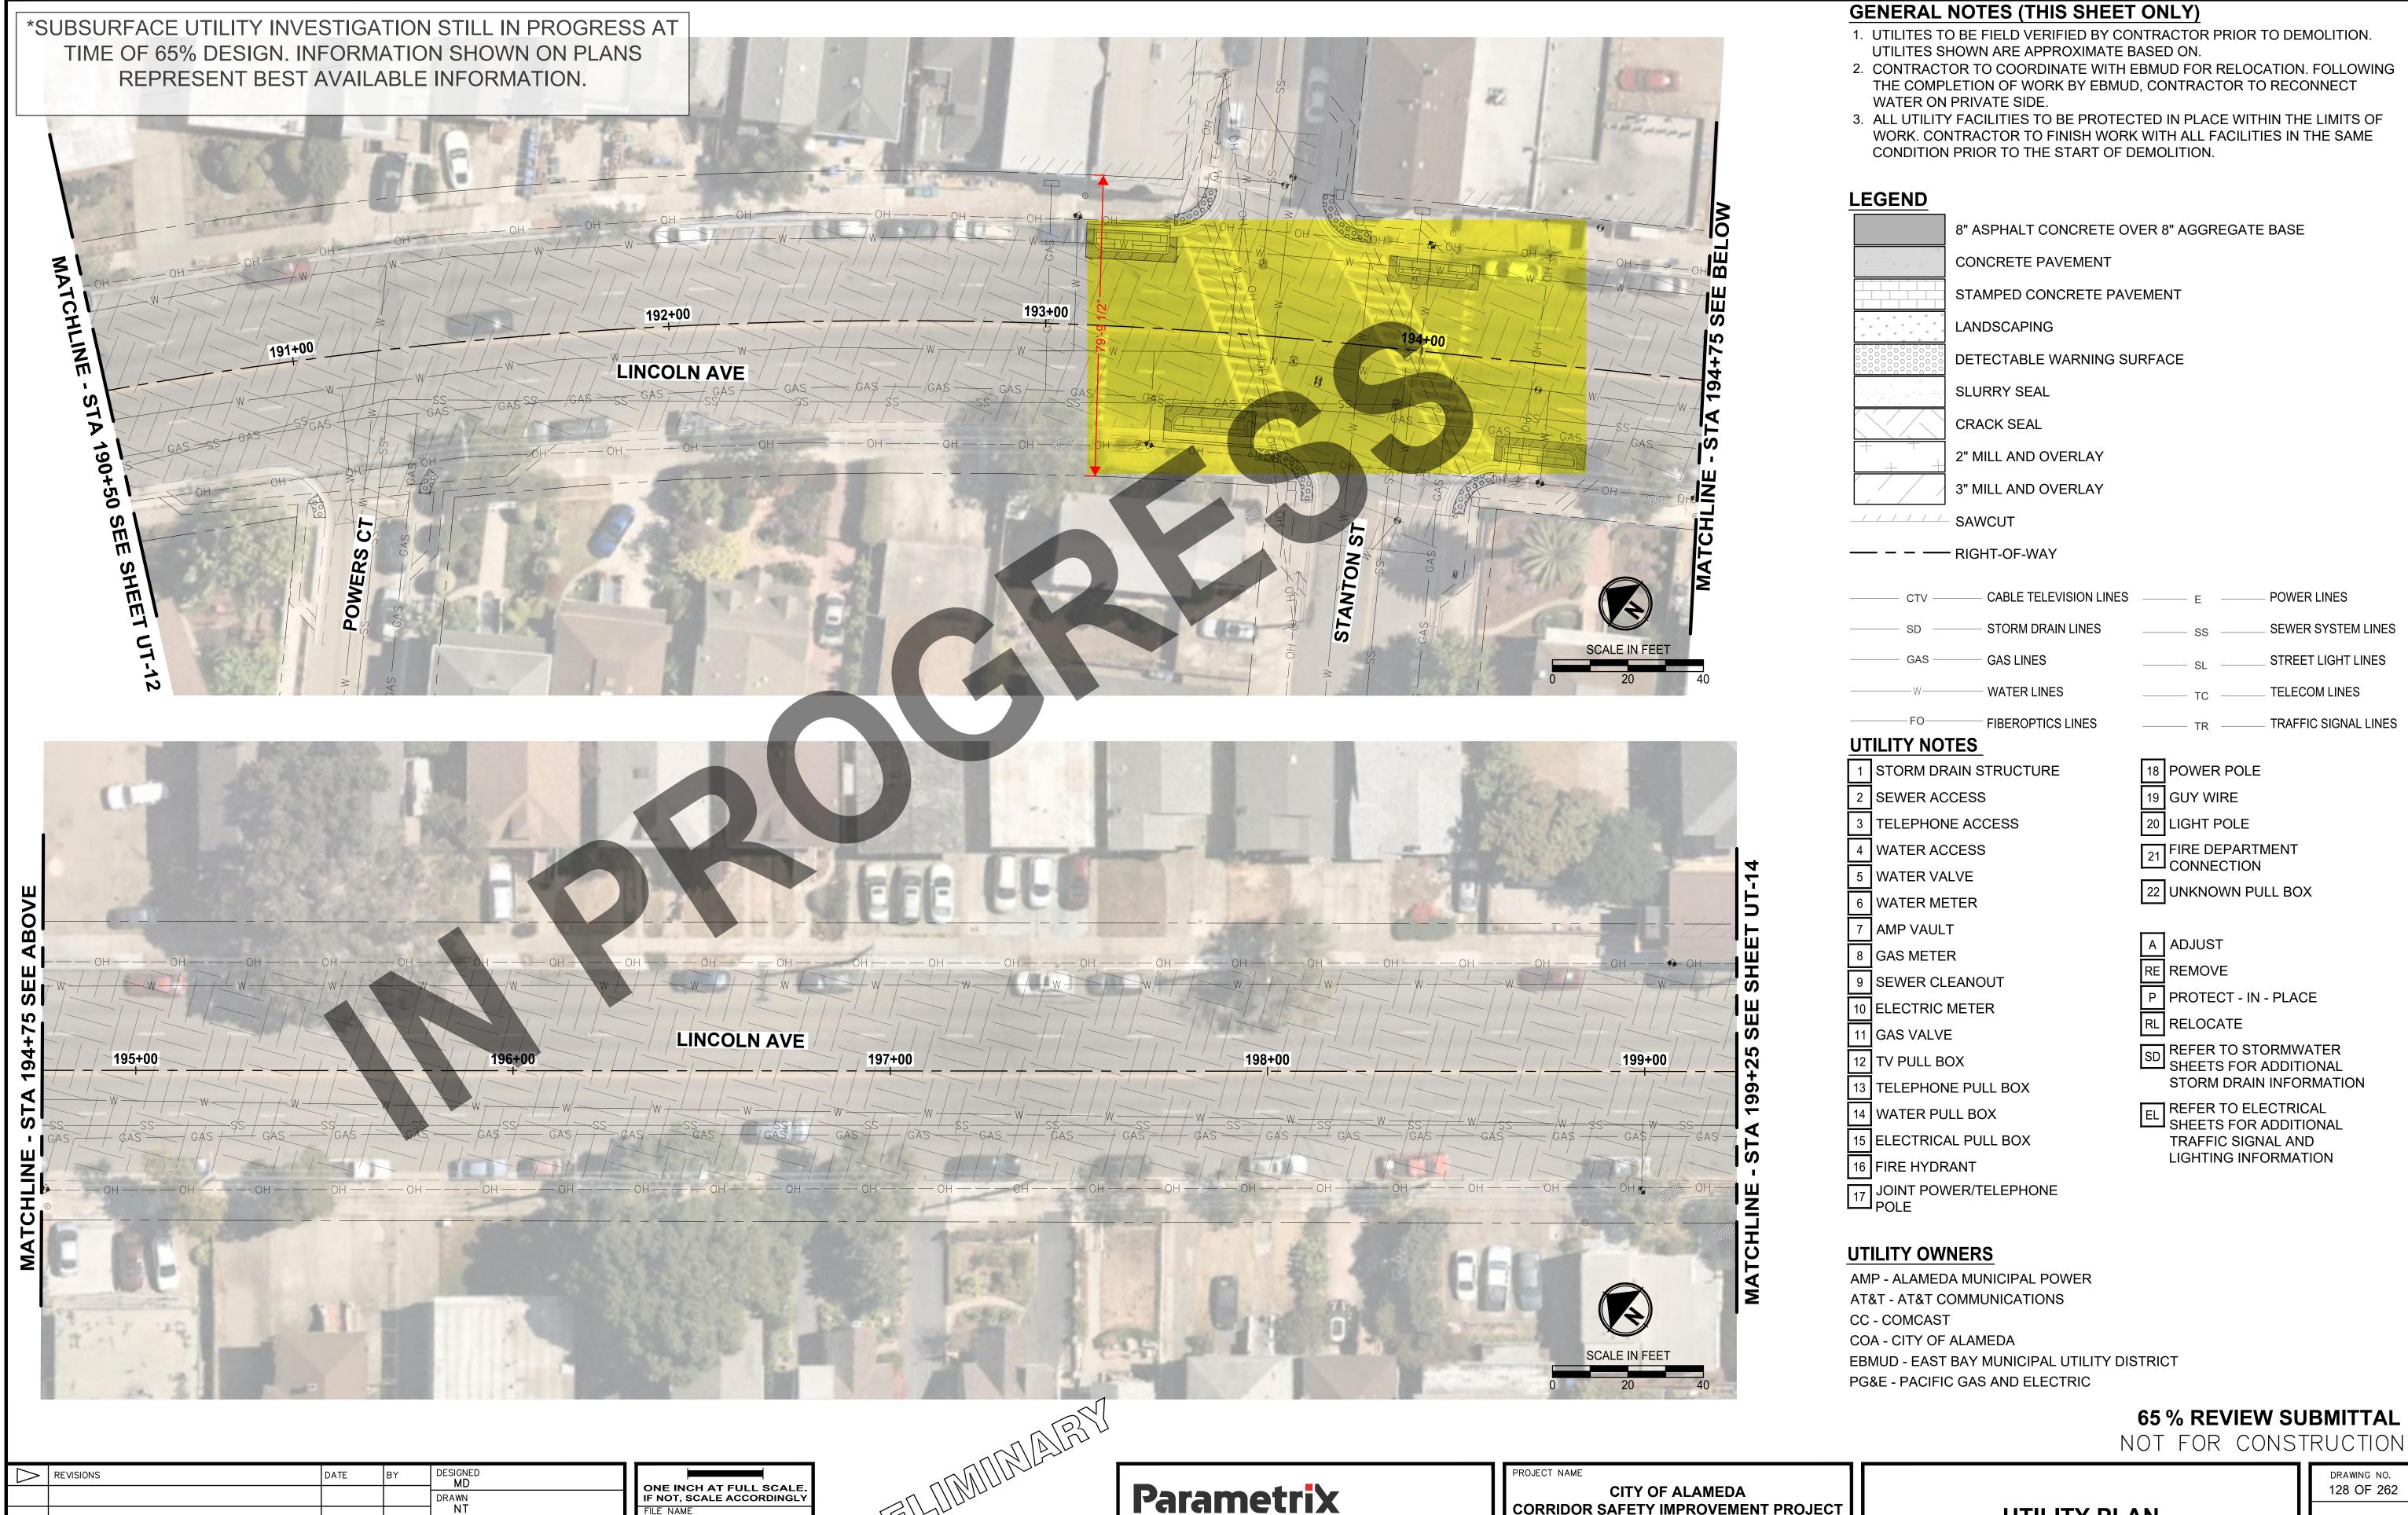DRAWING NO. 128 OF 262

CORRIDOR SAFETY IMPROVEMENT PROJECT

LINCOLN AVE | MARSHALL WAY | PACIFIC AVE



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FILE NAME SF8939003C-UT JOB No. C65700

DATE 06/2025

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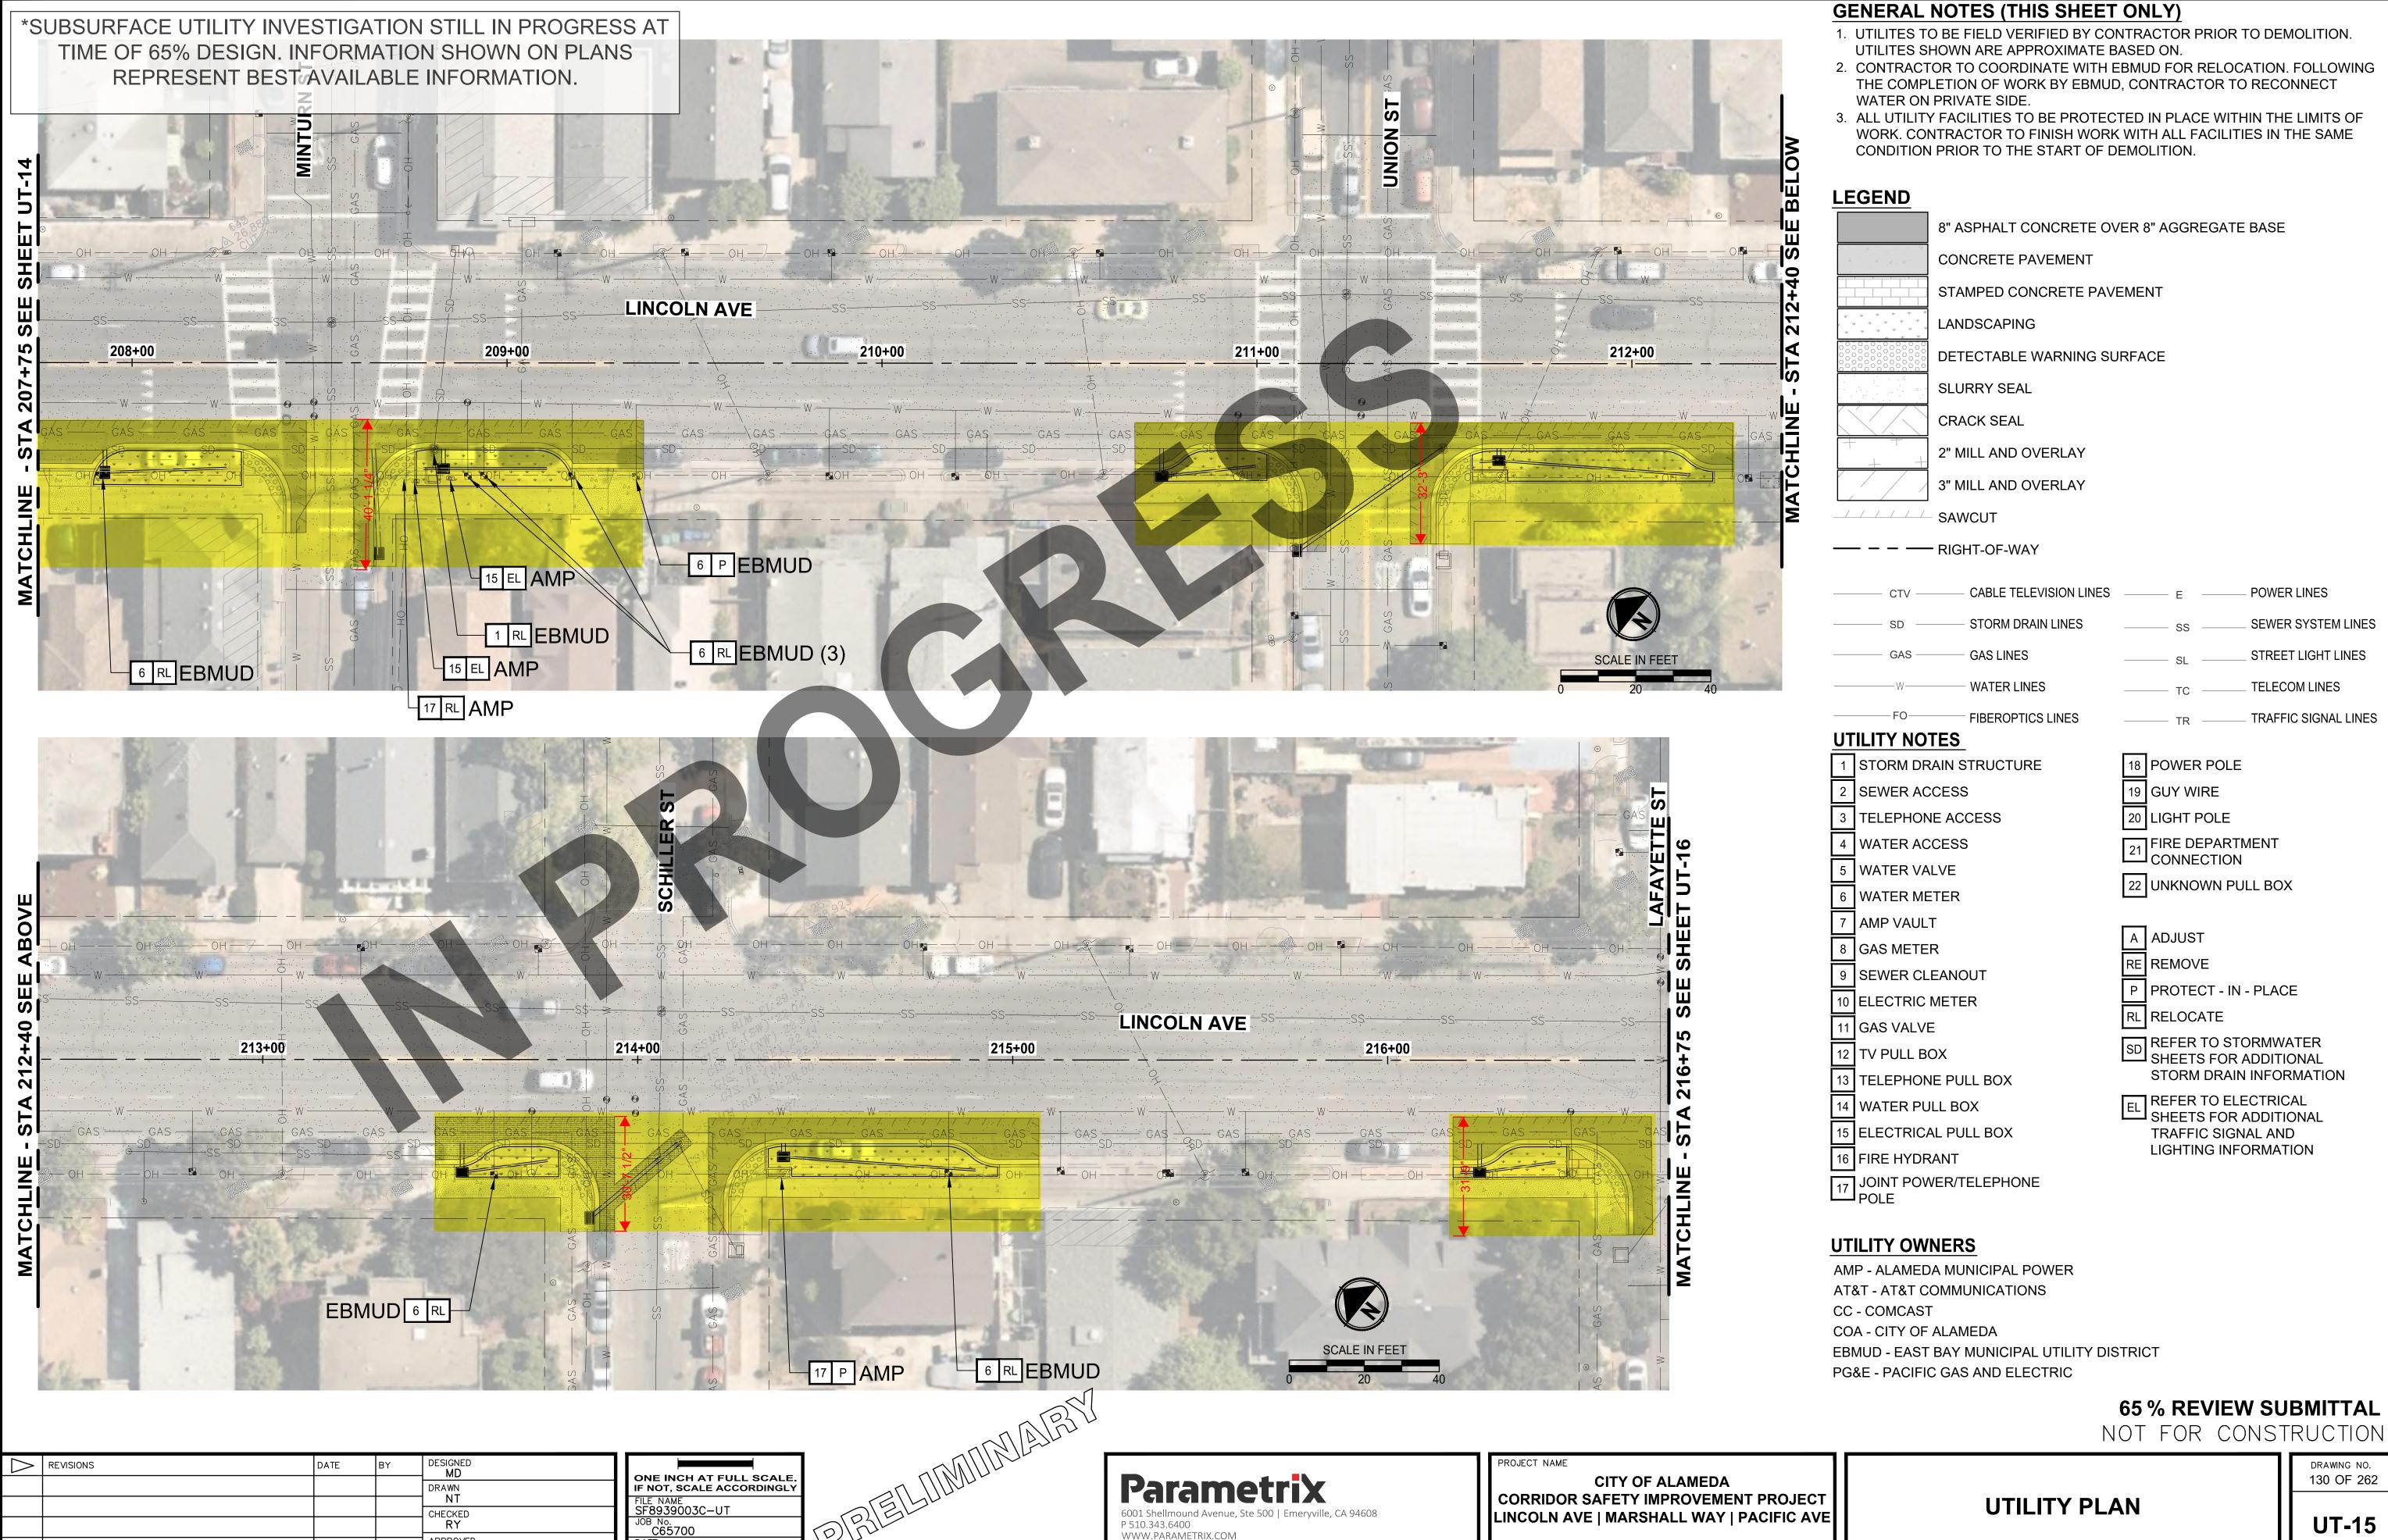
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**UTILITY PLAN** 

CORRIDOR SAFETY IMPROVEMENT PROJECT

LINCOLN AVE | MARSHALL WAY | PACIFIC AVE


**GENERAL NOTES (THIS SHEET ONLY)** 



APPROVED **DP** 

DATE 06/2025

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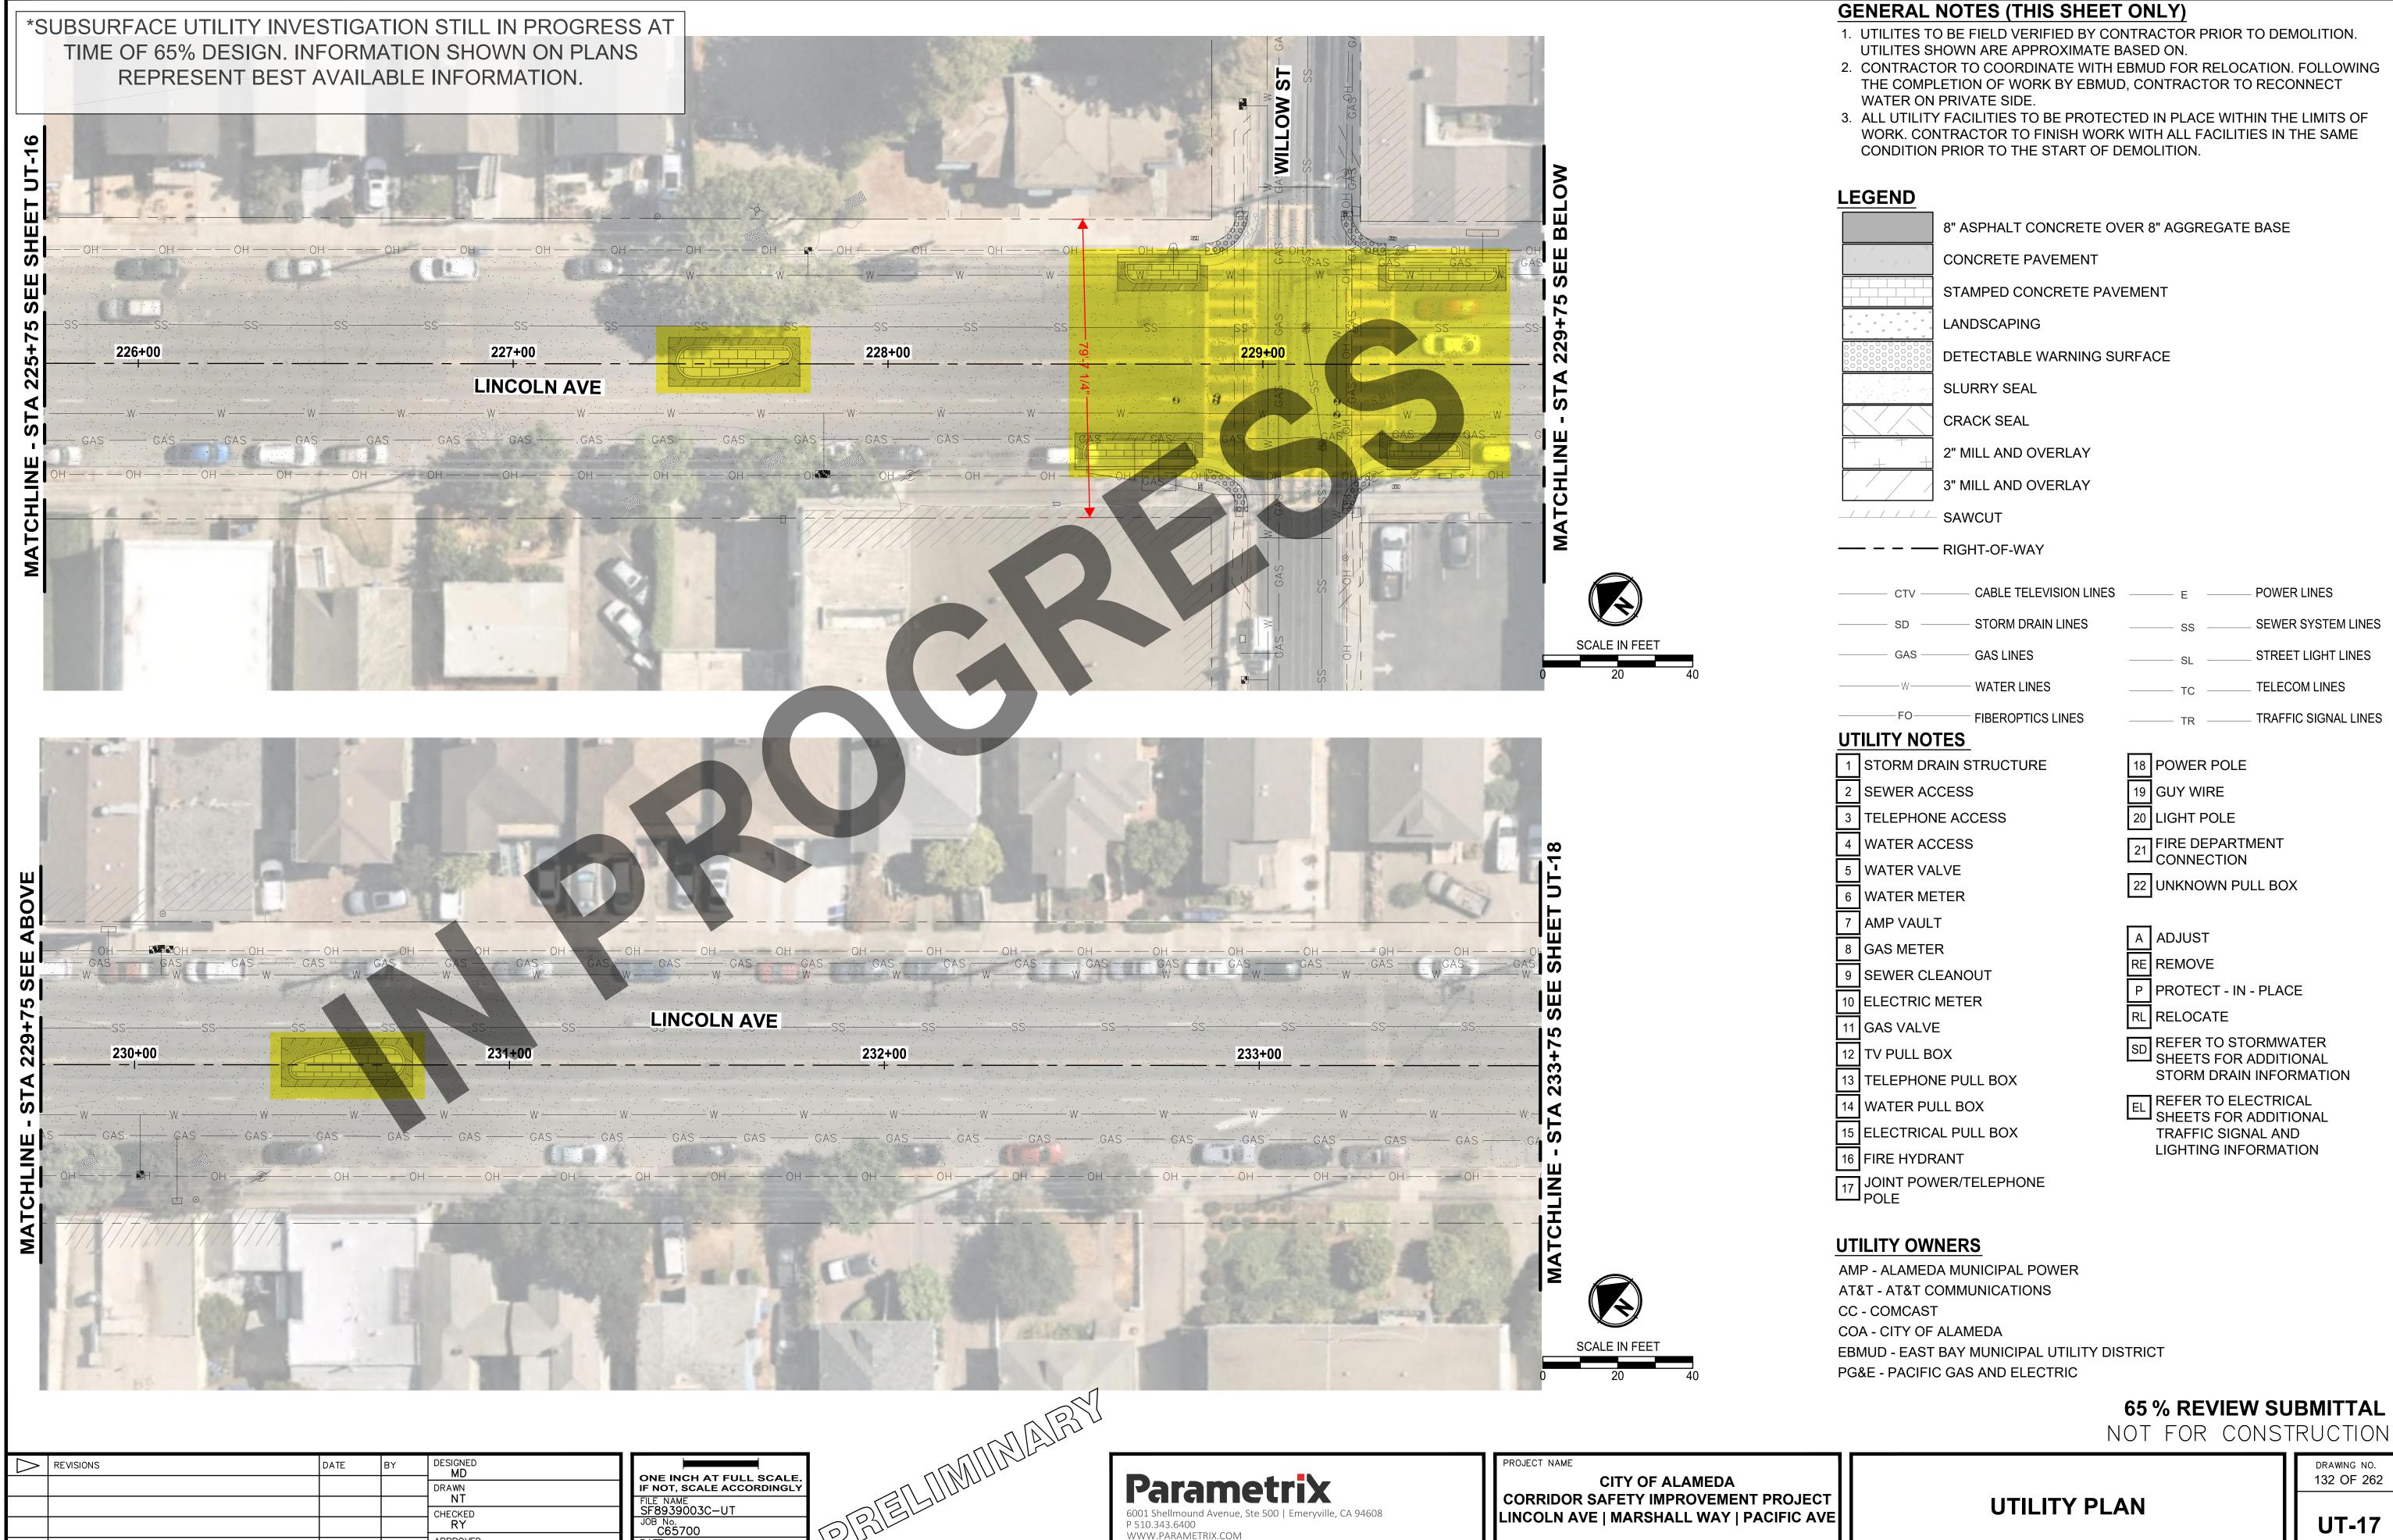
APPROVED **DP** 

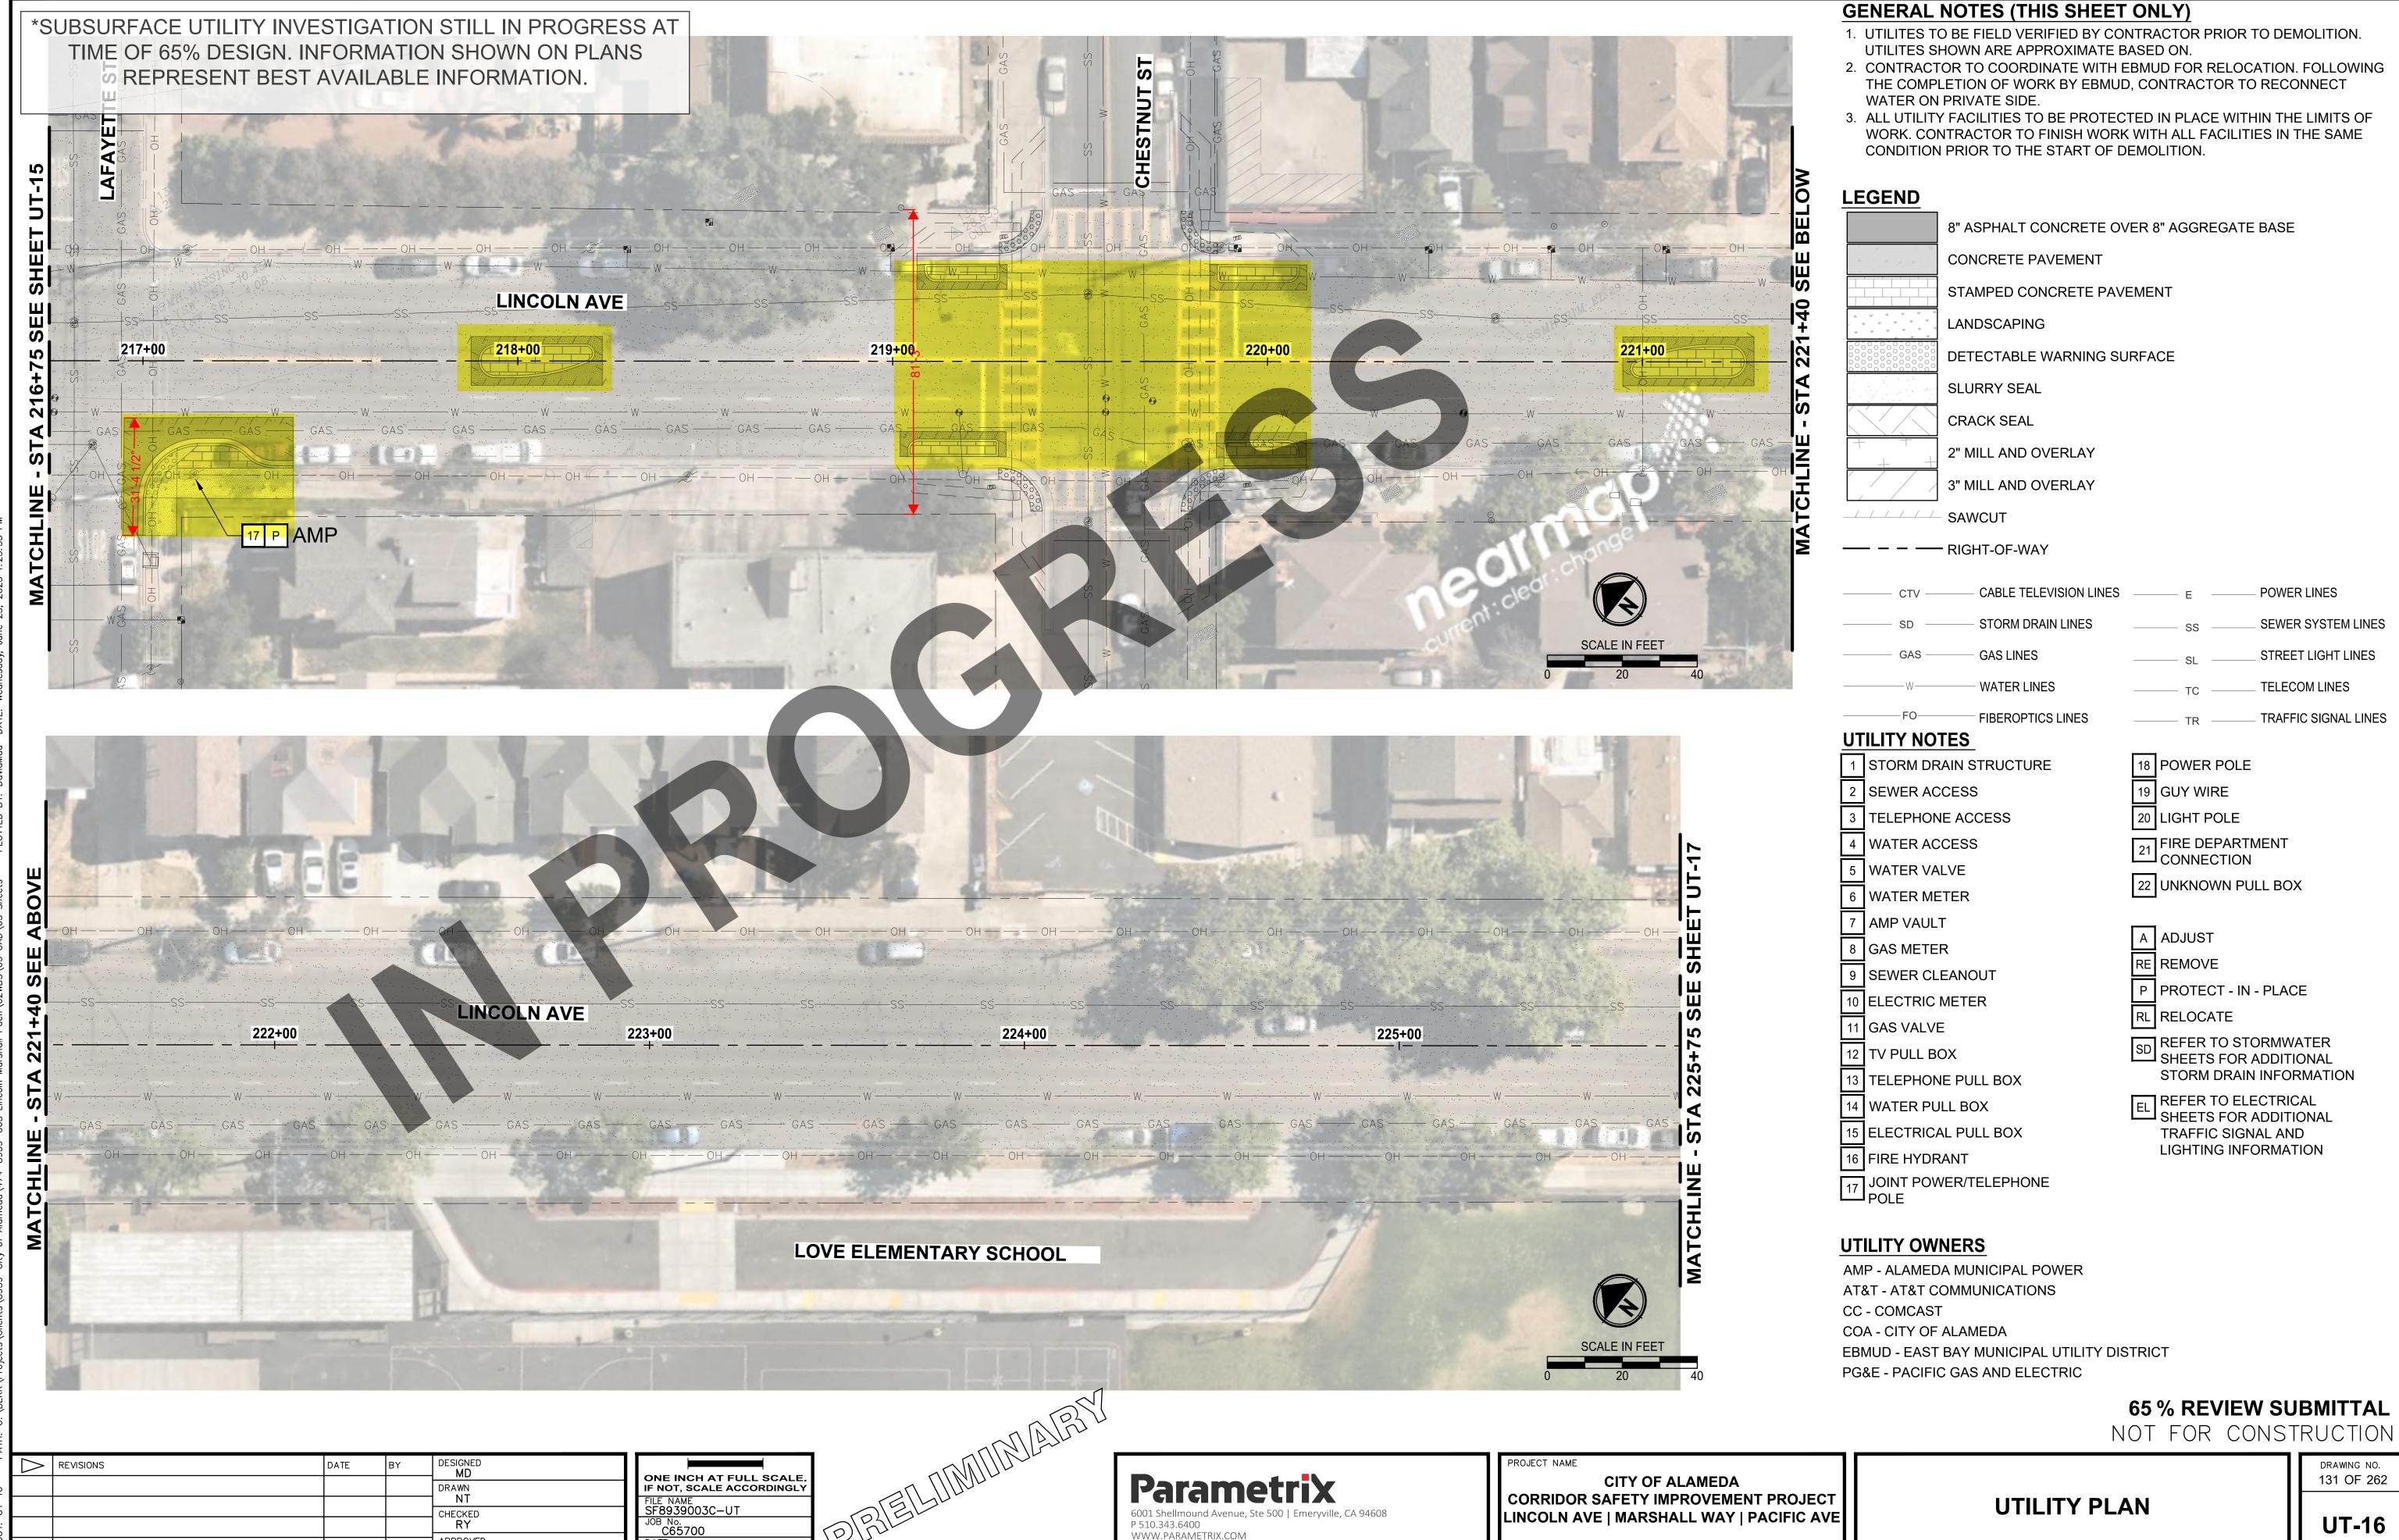DATE 06/2025

**UTILITY PLAN** 

LINCOLN AVE | MARSHALL WAY | PACIFIC AVE

131 OF 262



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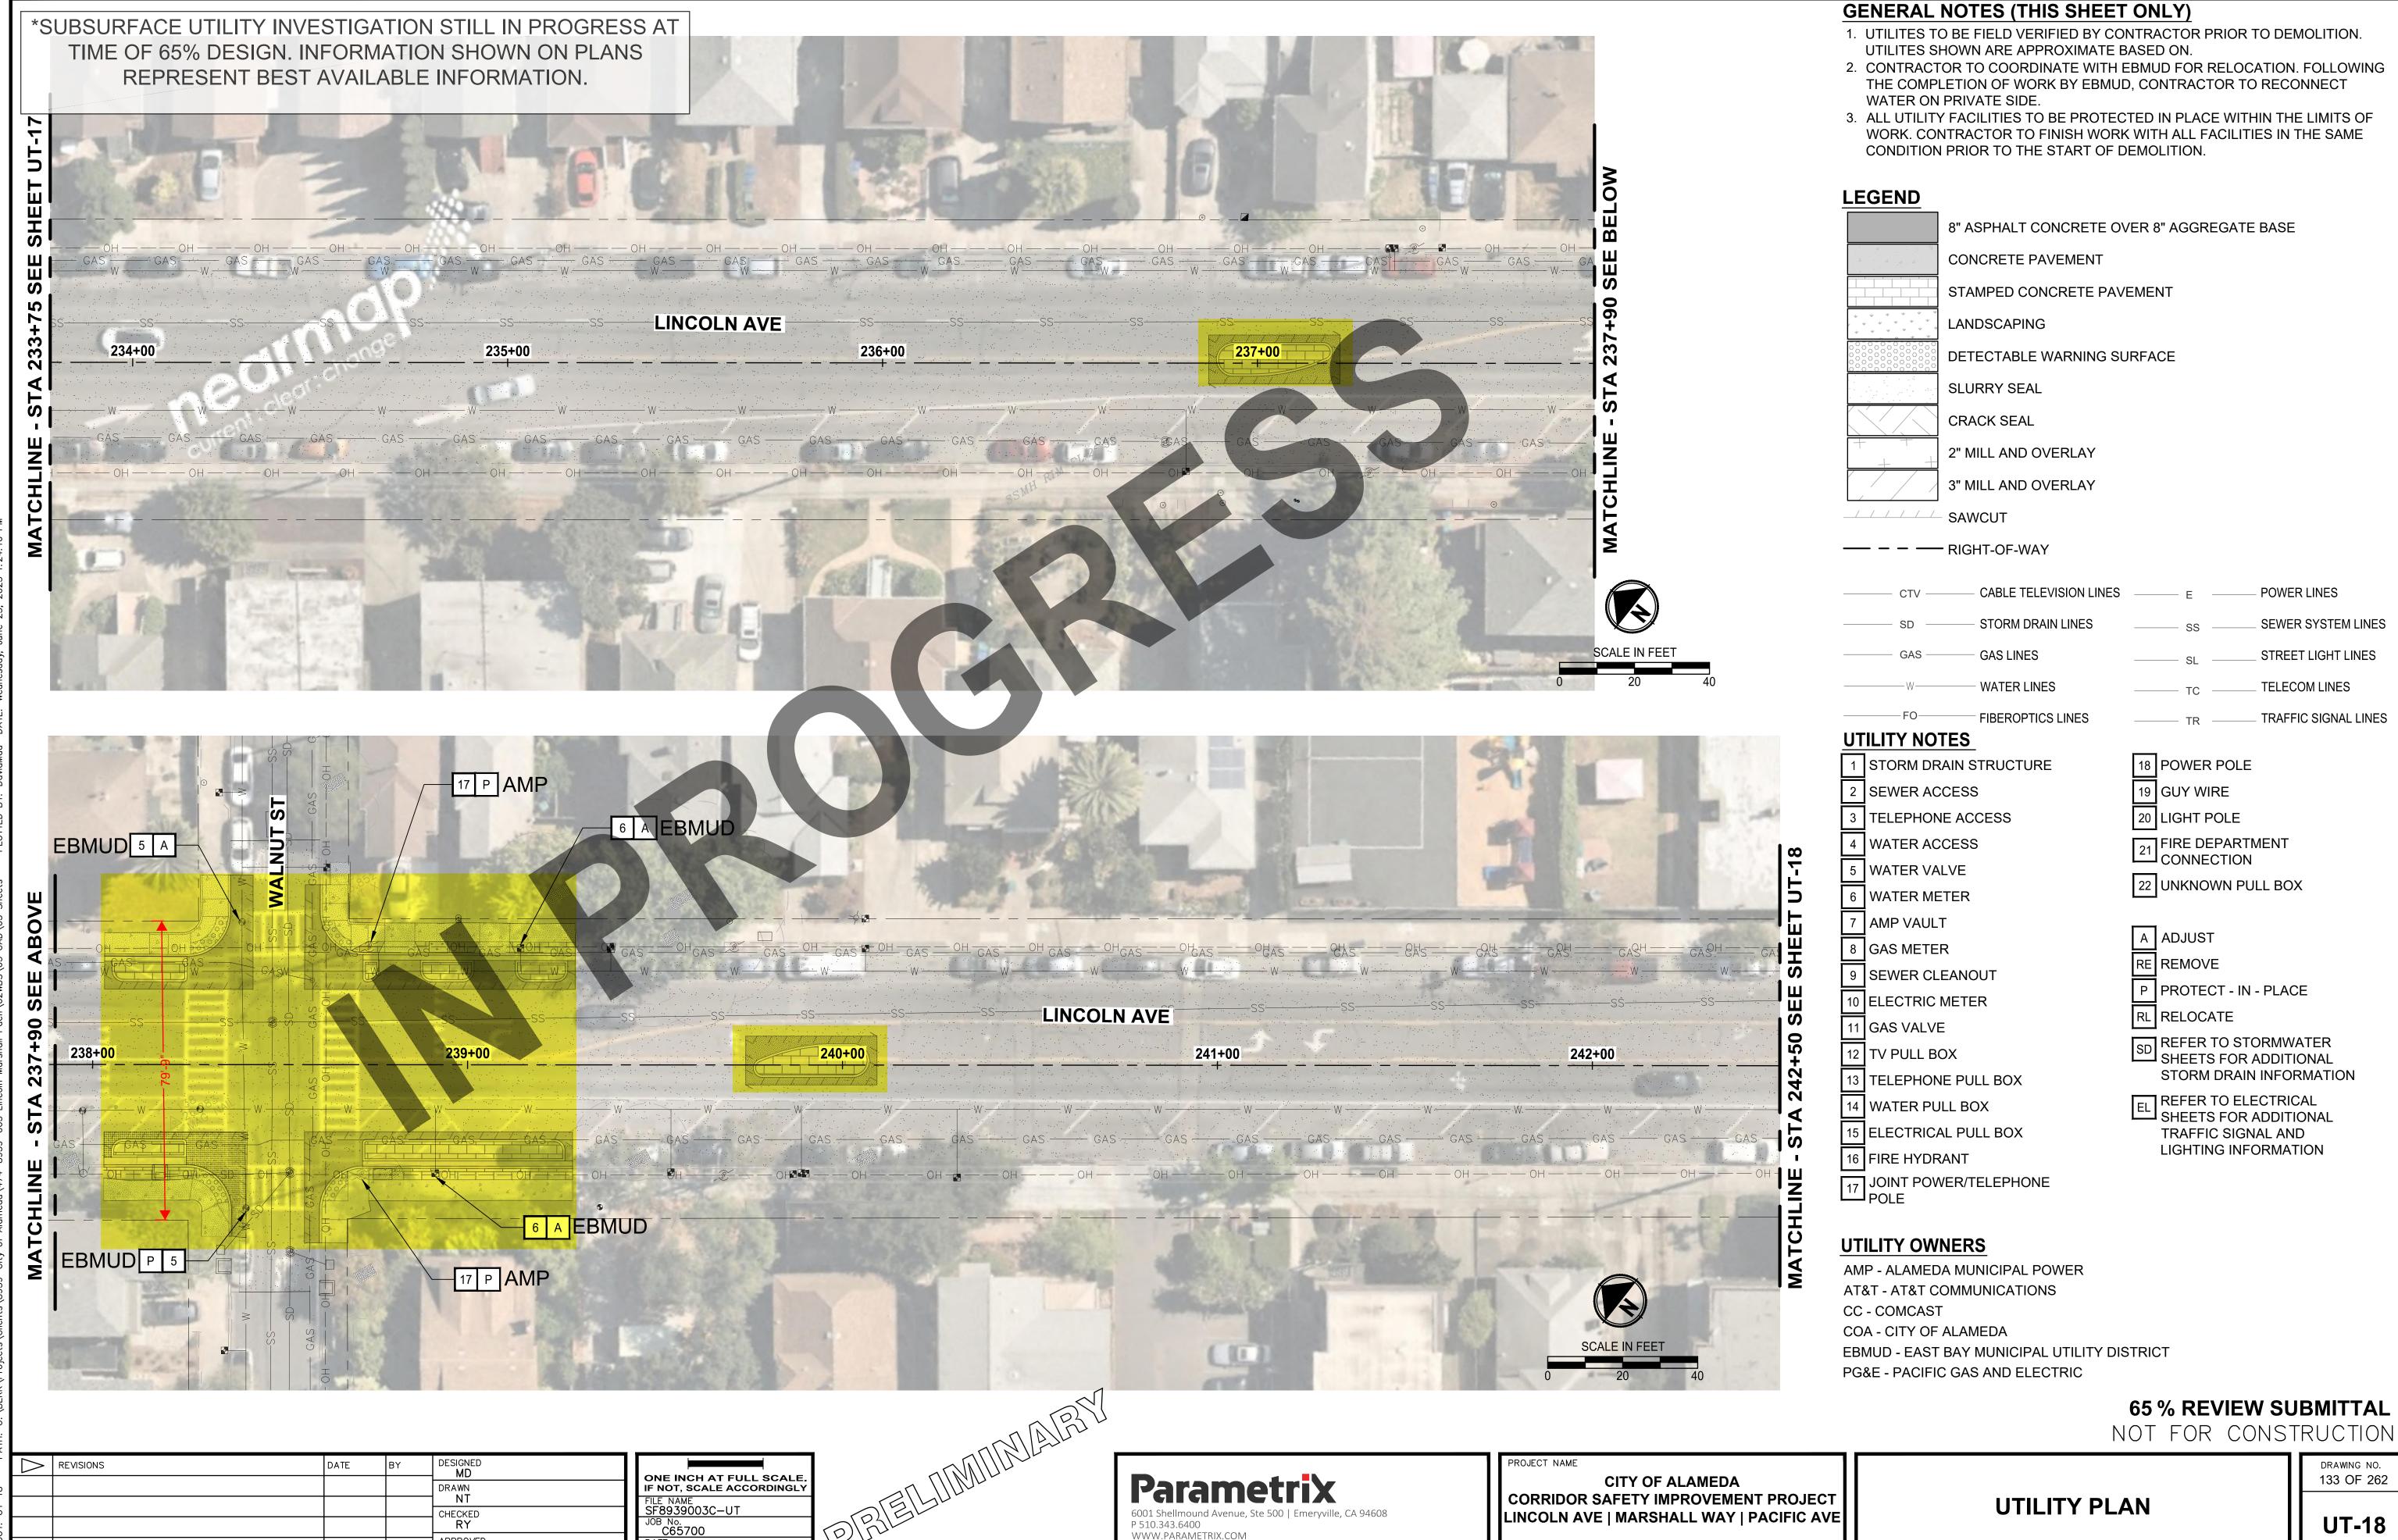
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APPROVED **DP** 

DATE 06/2025

**UTILITY PLAN** 

LINCOLN AVE | MARSHALL WAY | PACIFIC AVE



APPROVED DP


DATE 06/2025

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**UTILITY PLAN** 

DRAWING NO. 133 OF 262

LINCOLN AVE | MARSHALL WAY | PACIFIC AVE

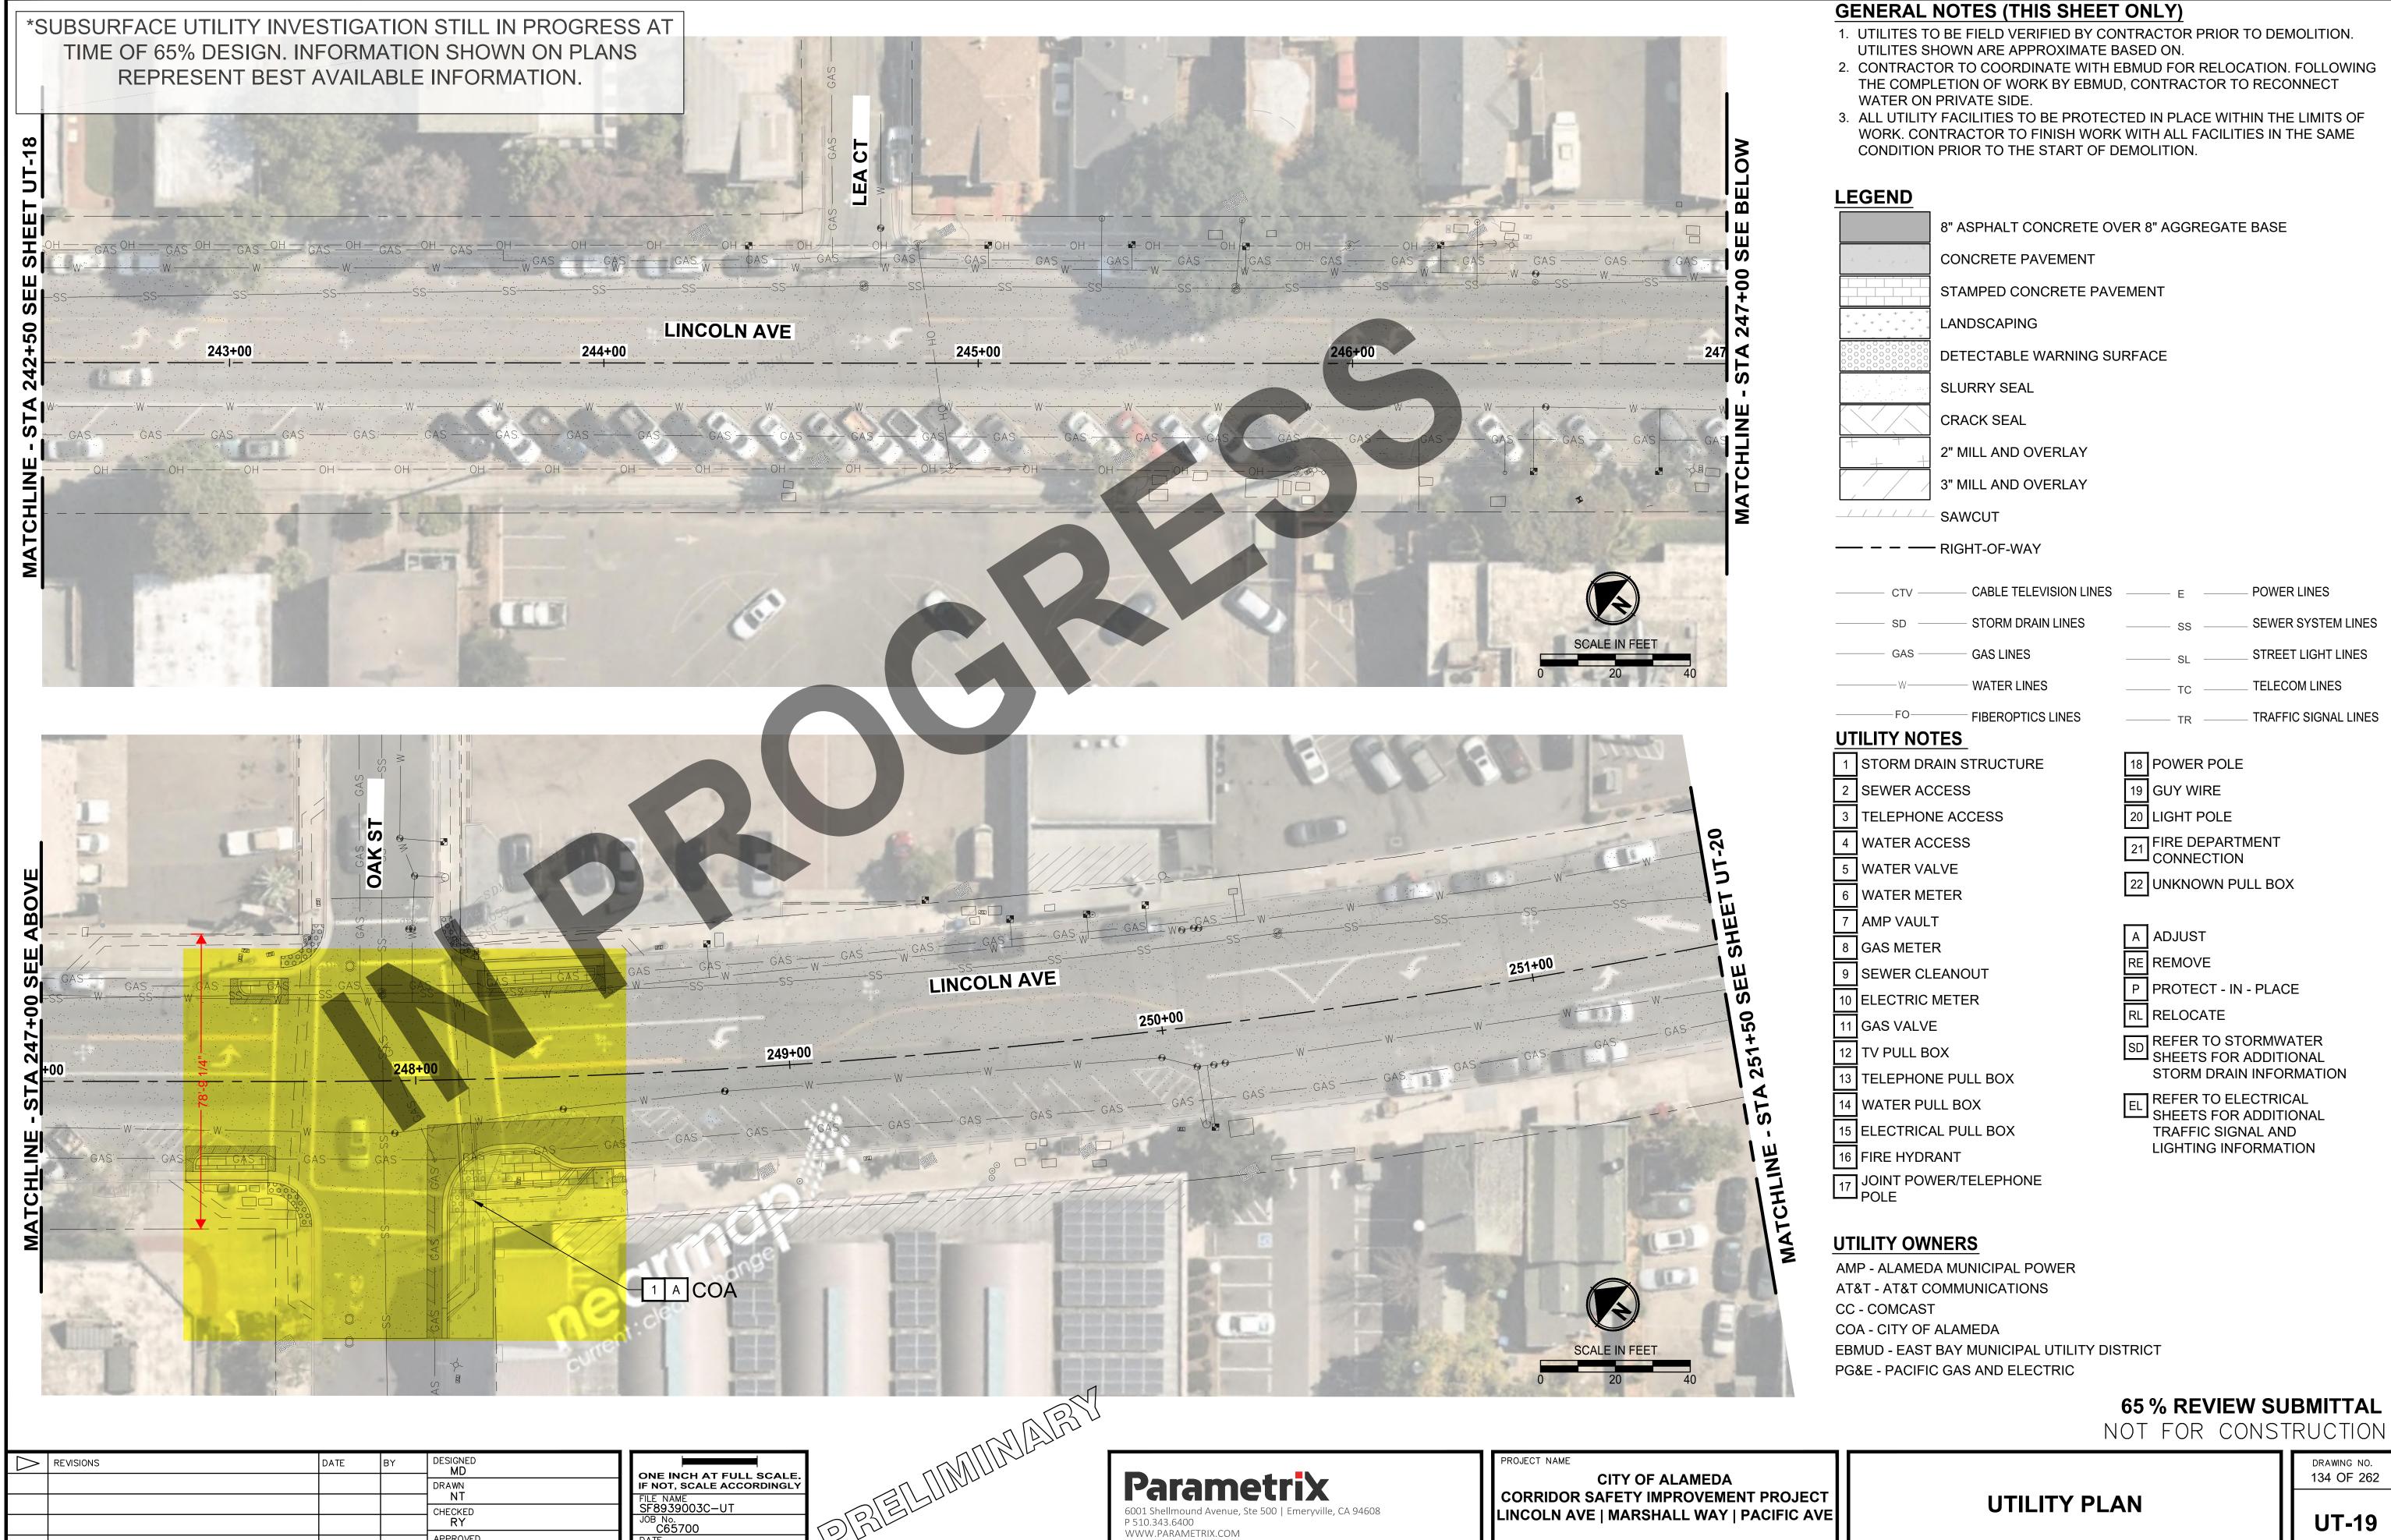

APPROVED **DP** 

DATE 06/2025

DRAWING NO. 134 OF 262

\*SUBSURFACE UTILITY INVESTIGATION STILL IN PROGRESS AT TIME OF 65% DESIGN. INFORMATION SHOWN ON PLANS REPRESENT BEST AVAILABLE INFORMATION.

DESIGNED MD


CHECKED RY

APPROVED **DP** 

DRAWN

DATE

REVISIONS

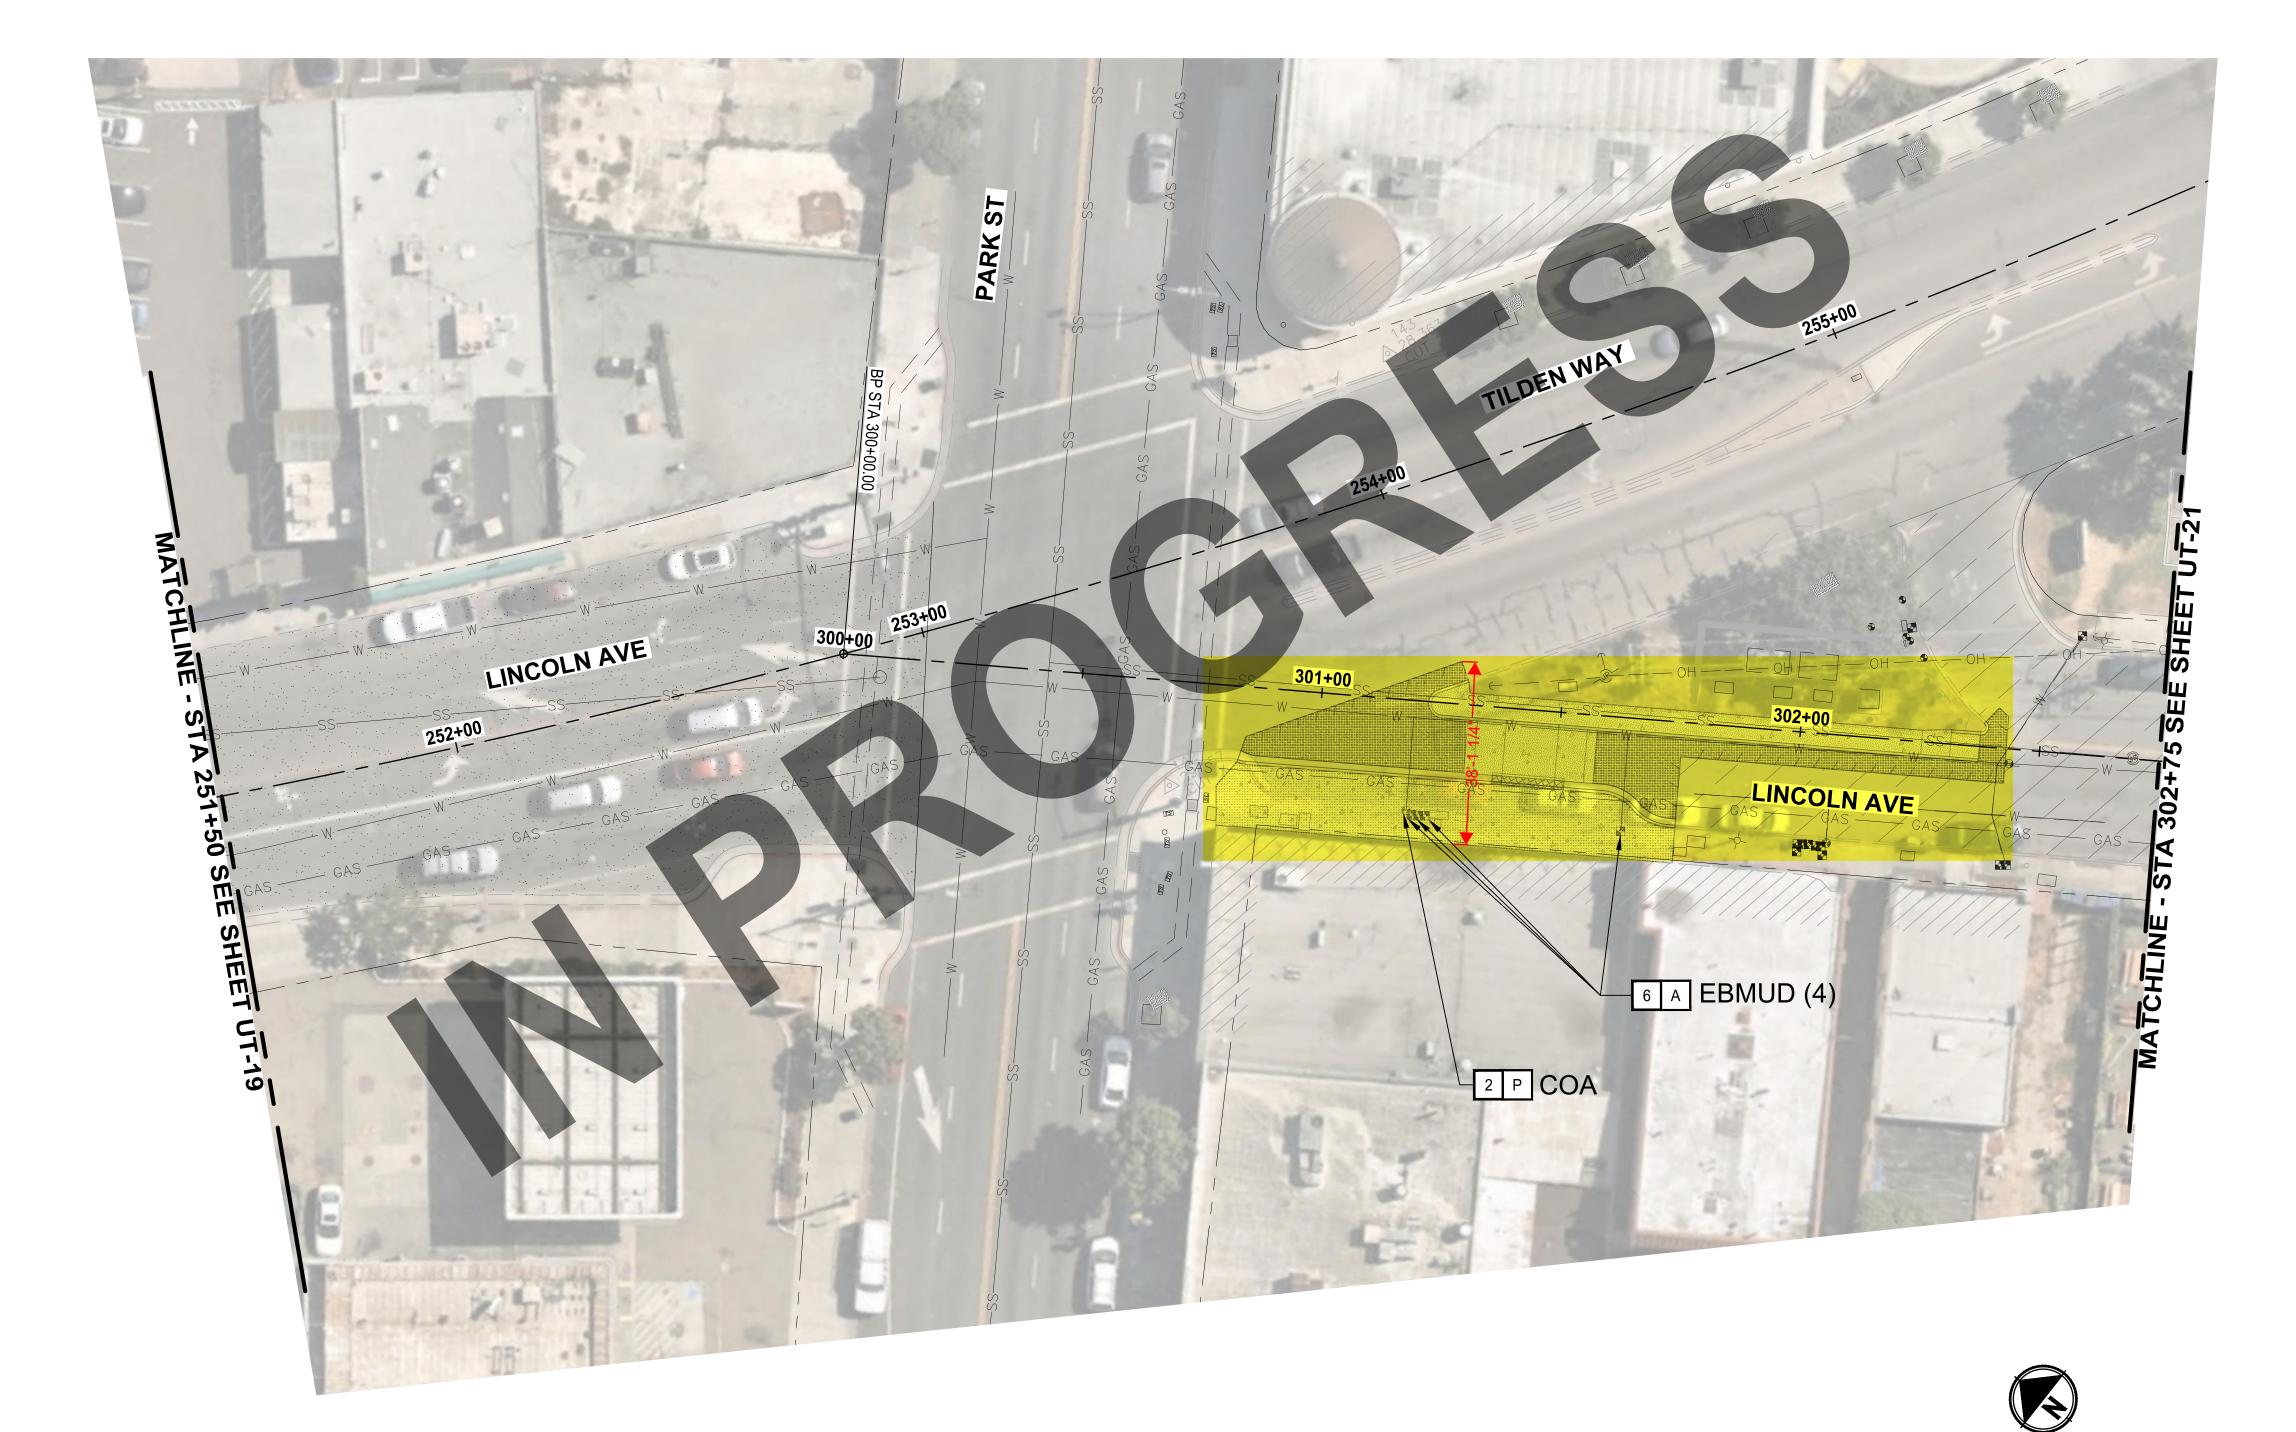

## **GENERAL NOTES (THIS SHEET ONLY)**

- 1. UTILITES TO BE FIELD VERIFIED BY CONTRACTOR PRIOR TO DEMOLITION. UTILITES SHOWN ARE APPROXIMATE BASED ON.
- 2. CONTRACTOR TO COORDINATE WITH EBMUD FOR RELOCATION. FOLLOWING THE COMPLETION OF WORK BY EBMUD, CONTRACTOR TO RECONNECT WATER ON PRIVATE SIDE.
- 3. ALL UTILITY FACILITIES TO BE PROTECTED IN PLACE WITHIN THE LIMITS OF WORK. CONTRACTOR TO FINISH WORK WITH ALL FACILITIES IN THE SAME CONDITION PRIOR TO THE START OF DEMOLITION.

## **LEGEND**

8" ASPHALT CONCRETE OVER 8" AGGREGATE BASE

CONCRETE PAVEMENT

3" MILL AND OVERLAY

STAMPED CONCRETE PAVEMENT

LANDSCAPING

DETECTABLE WARNING SURFACE

SLURRY SEAL

CRACK SEAL

2" MILL AND OVERLAY

SAWCUT

- - RIGHT-OF-WAY

CABLE TELEVISION LINES - POWER LINES

STORM DRAIN LINES SEWER SYSTEM LINES

GAS LINES STREET LIGHT LINES WATER LINES TELECOM LINES

- FIBEROPTICS LINES

#### **UTILITY NOTES**

1 STORM DRAIN STRUCTURE

2 SEWER ACCESS

3 TELEPHONE ACCESS

4 WATER ACCESS

5 WATER VALVE

6 WATER METER

7 AMP VAULT 8 GAS METER

9 SEWER CLEANOUT

10 ELECTRIC METER

11 GAS VALVE 12 TV PULL BOX

13 TELEPHONE PULL BOX

14 WATER PULL BOX

15 ELECTRICAL PULL BOX

16 FIRE HYDRANT

JOINT POWER/TELEPHONE POLE

22 UNKNOWN PULL BOX

FIRE DEPARTMENT CONNECTION

18 POWER POLE

19 GUY WIRE

20 LIGHT POLE

A ADJUST

RE REMOVE

P PROTECT - IN - PLACE

RL RELOCATE

SD REFER TO STORMWATER SHEETS FOR ADDITIONAL STORM DRAIN INFORMATION

TRAFFIC SIGNAL LINES

REFER TO ELECTRICAL SHEETS FOR ADDITIONAL

TRAFFIC SIGNAL AND LIGHTING INFORMATION

## **UTILITY OWNERS**

AMP - ALAMEDA MUNICIPAL POWER AT&T - AT&T COMMUNICATIONS

CC - COMCAST

COA - CITY OF ALAMEDA

EBMUD - EAST BAY MUNICIPAL UTILITY DISTRICT

PG&E - PACIFIC GAS AND ELECTRIC

**65 % REVIEW SUBMITTAL** 

NOT FOR CONSTRUCTION

DRAWING NO. 135 OF 262

**UT-20** 

ONE INCH AT FULL SCALE. IF NOT, SCALE ACCORDINGLY

FILE NAME SF8939003C-UT JOB No. C65700


DATE 06/2025

**Parametrix** P 510.343.6400 WWW.PARAMETRIX.COM

PROJECT NAME

**CITY OF ALAMEDA** CORRIDOR SAFETY IMPROVEMENT PROJECT LINCOLN AVE | MARSHALL WAY | PACIFIC AVE

**UTILITY PLAN** 

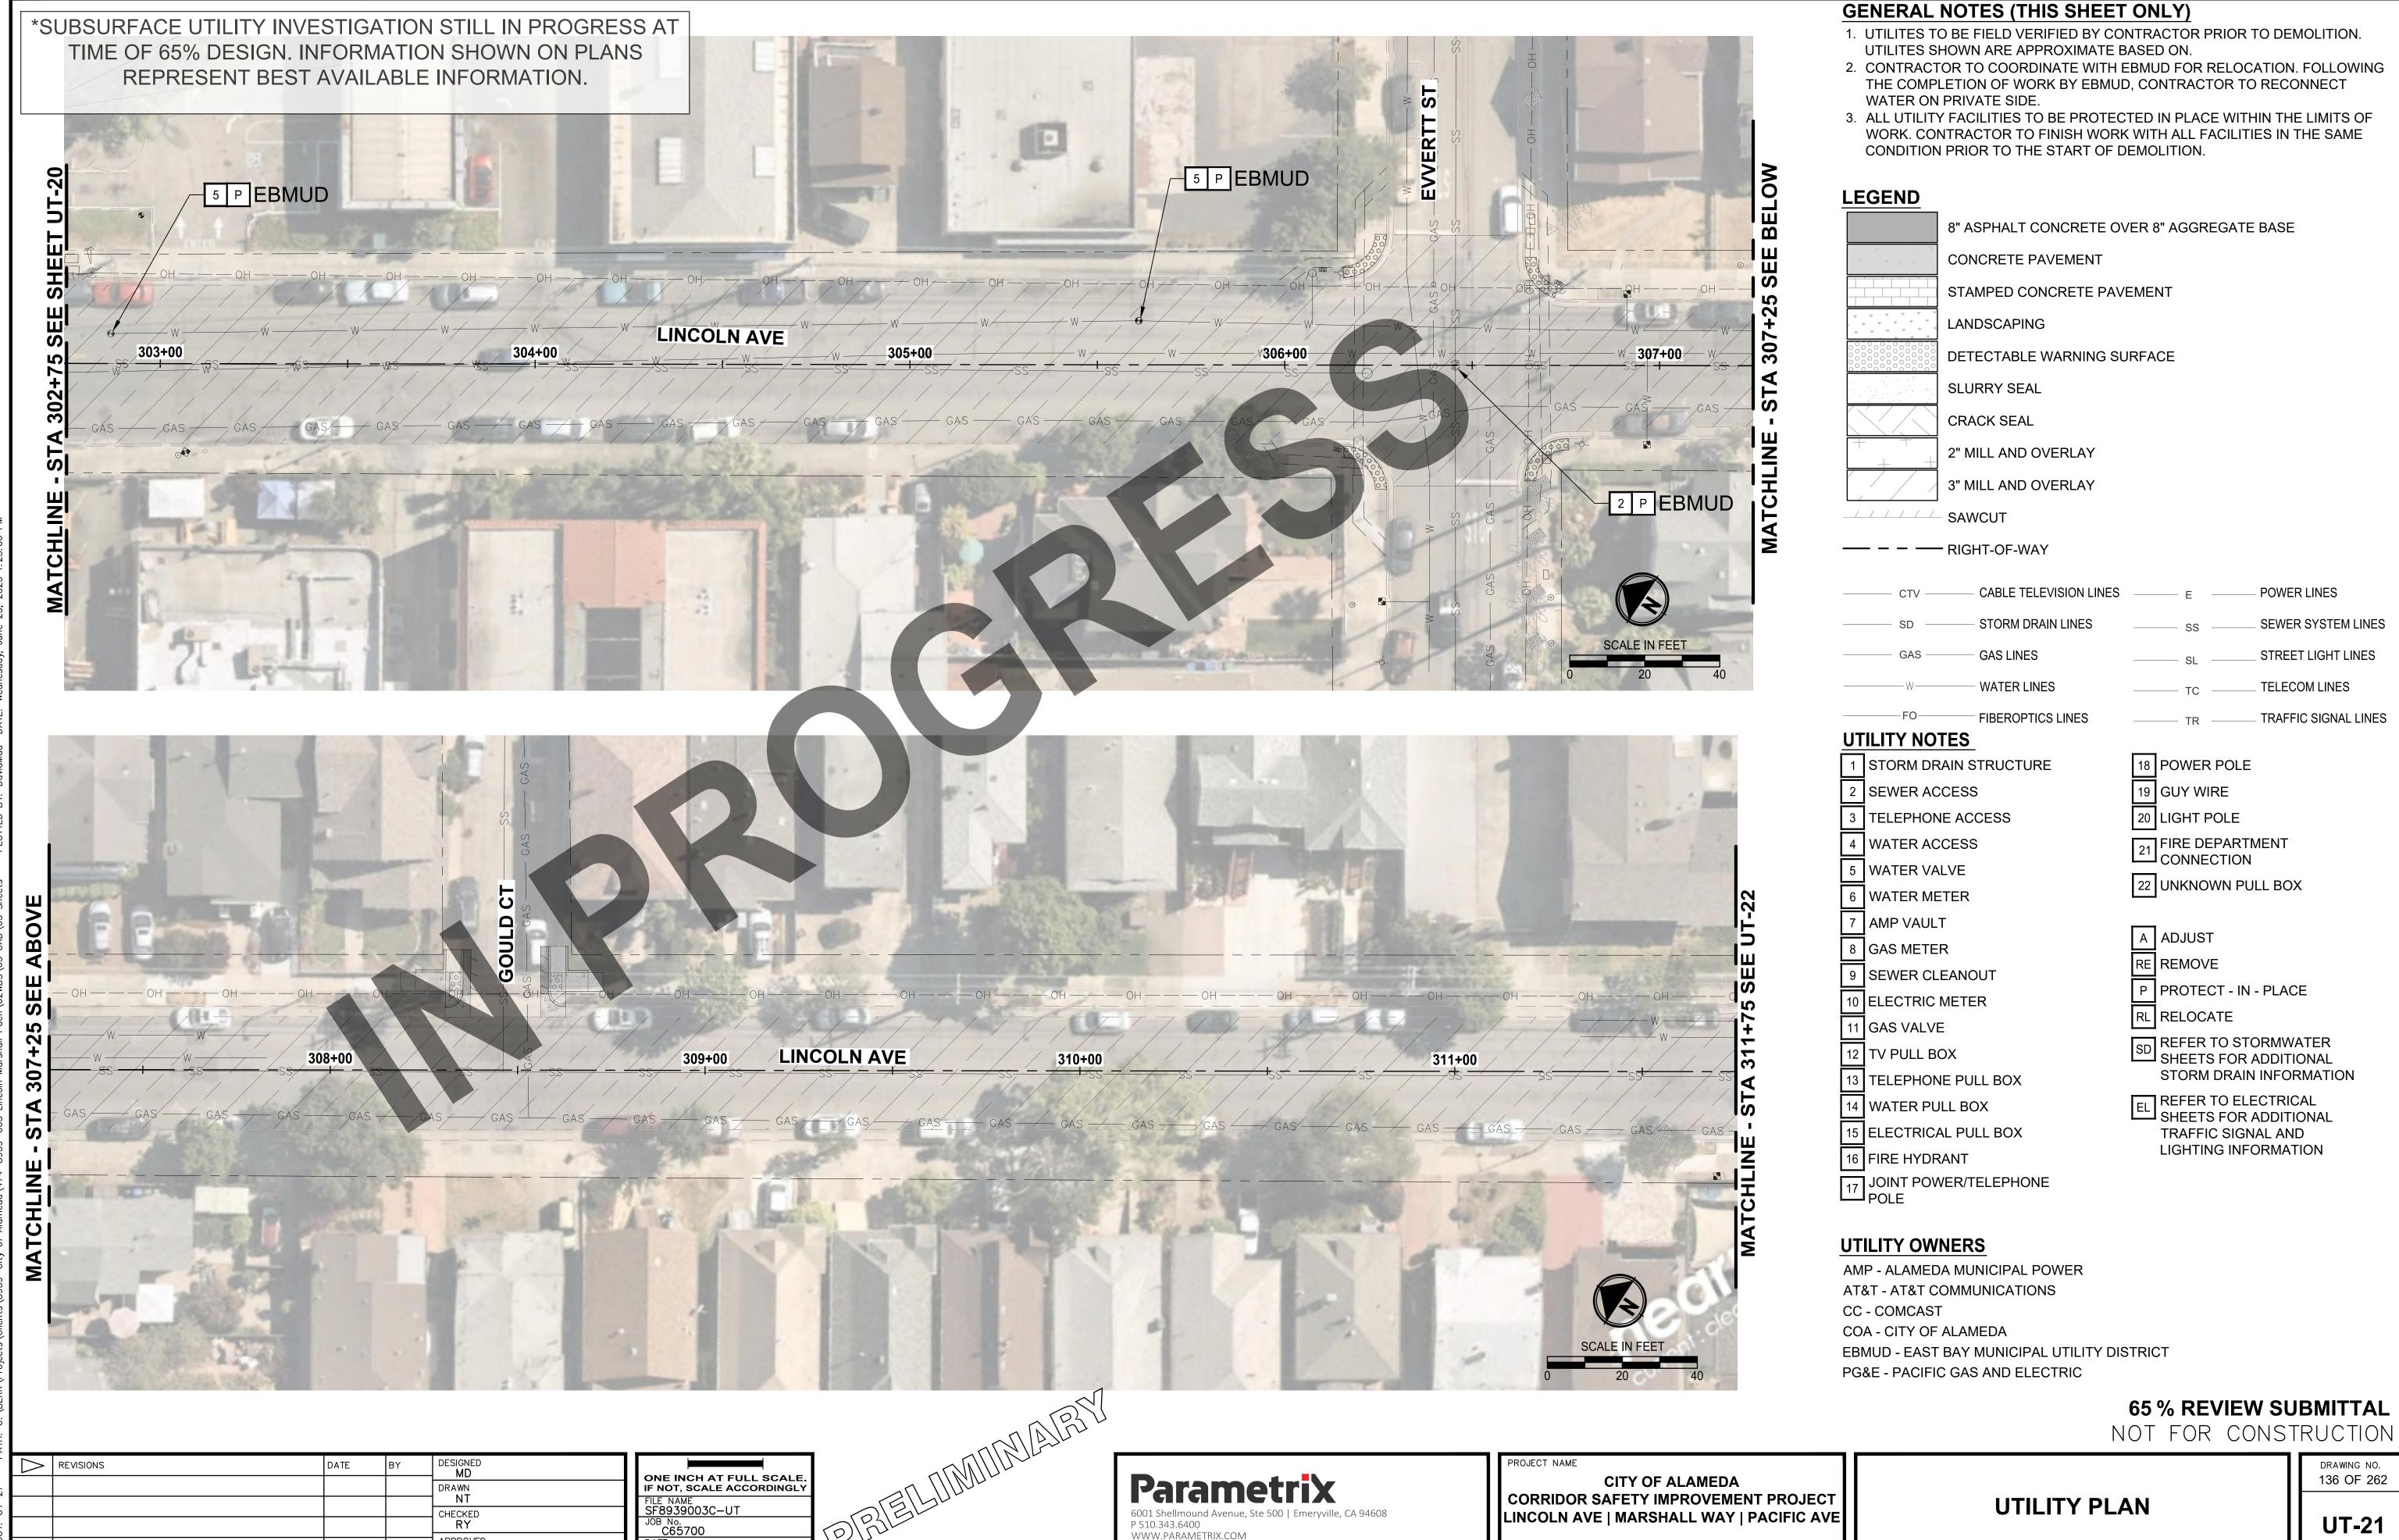


APPROVED **DP** 

DATE 06/2025

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DRAWING NO. 136 OF 262

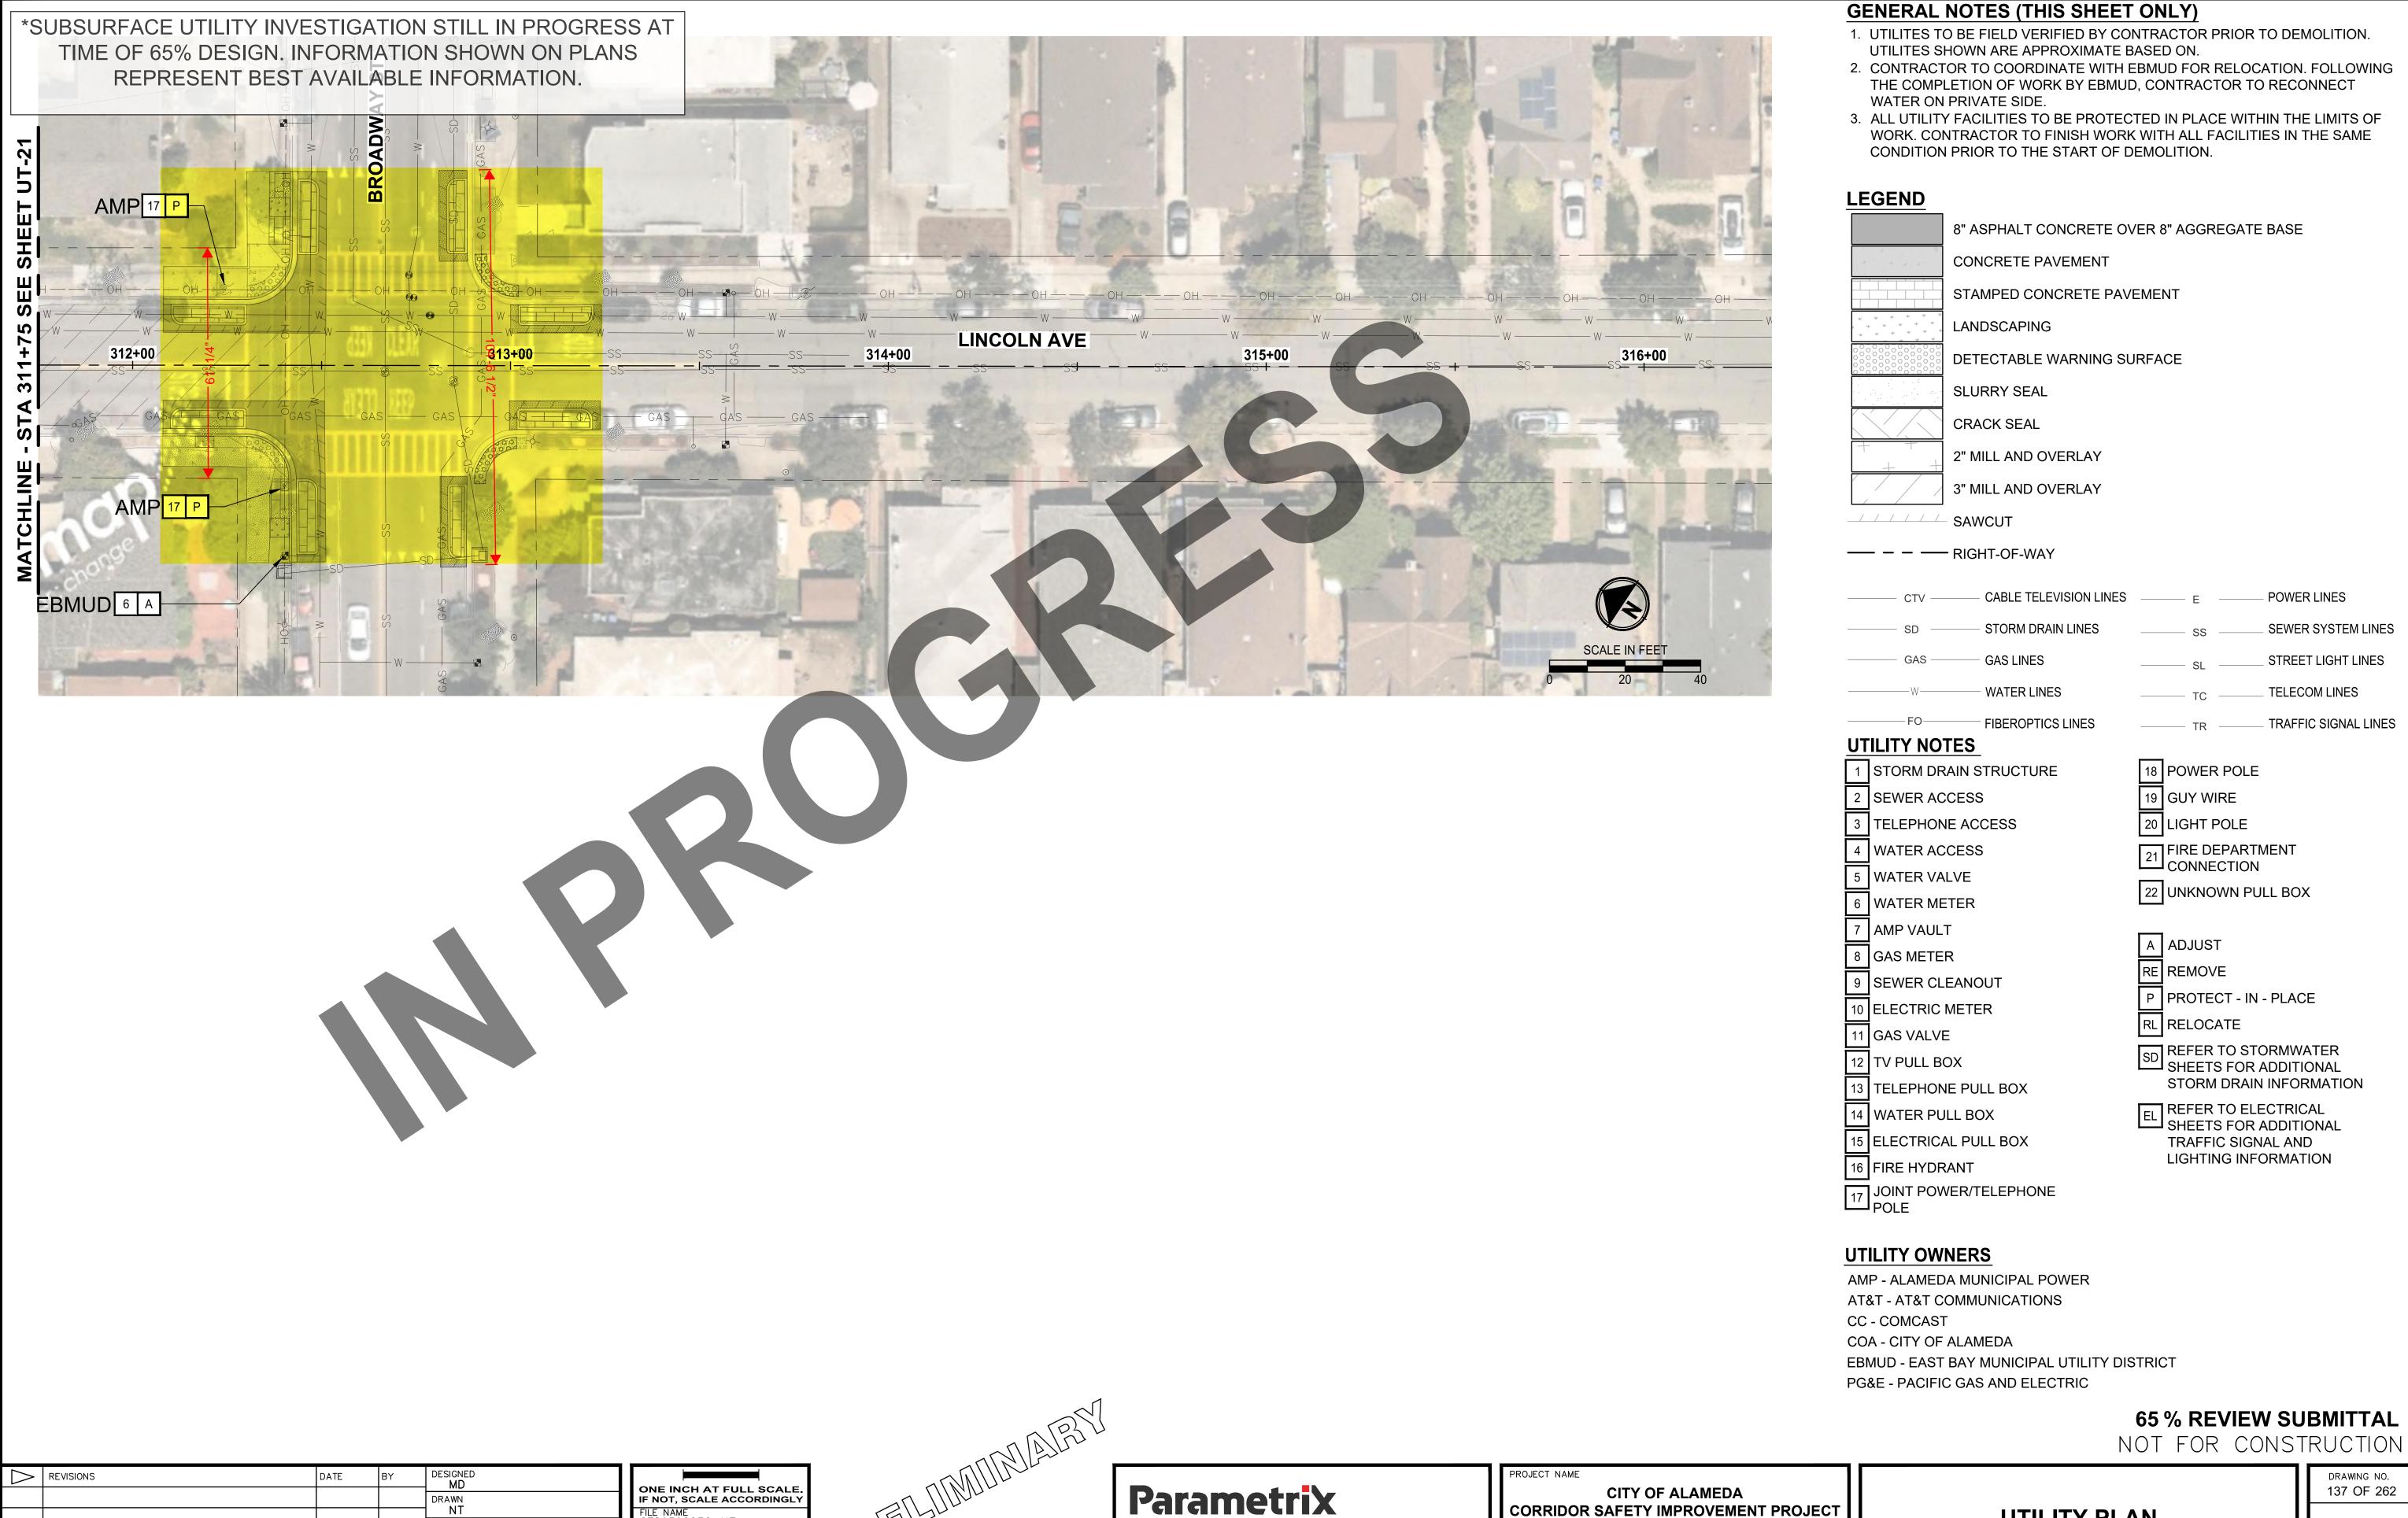

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APPROVED **DP** 

FILE NAME SF8939003C-UT JOB No. C65700


DATE 06/2025

**UTILITY PLAN** 

137 OF 262 **UT-22** 

CORRIDOR SAFETY IMPROVEMENT PROJECT

LINCOLN AVE | MARSHALL WAY | PACIFIC AVE

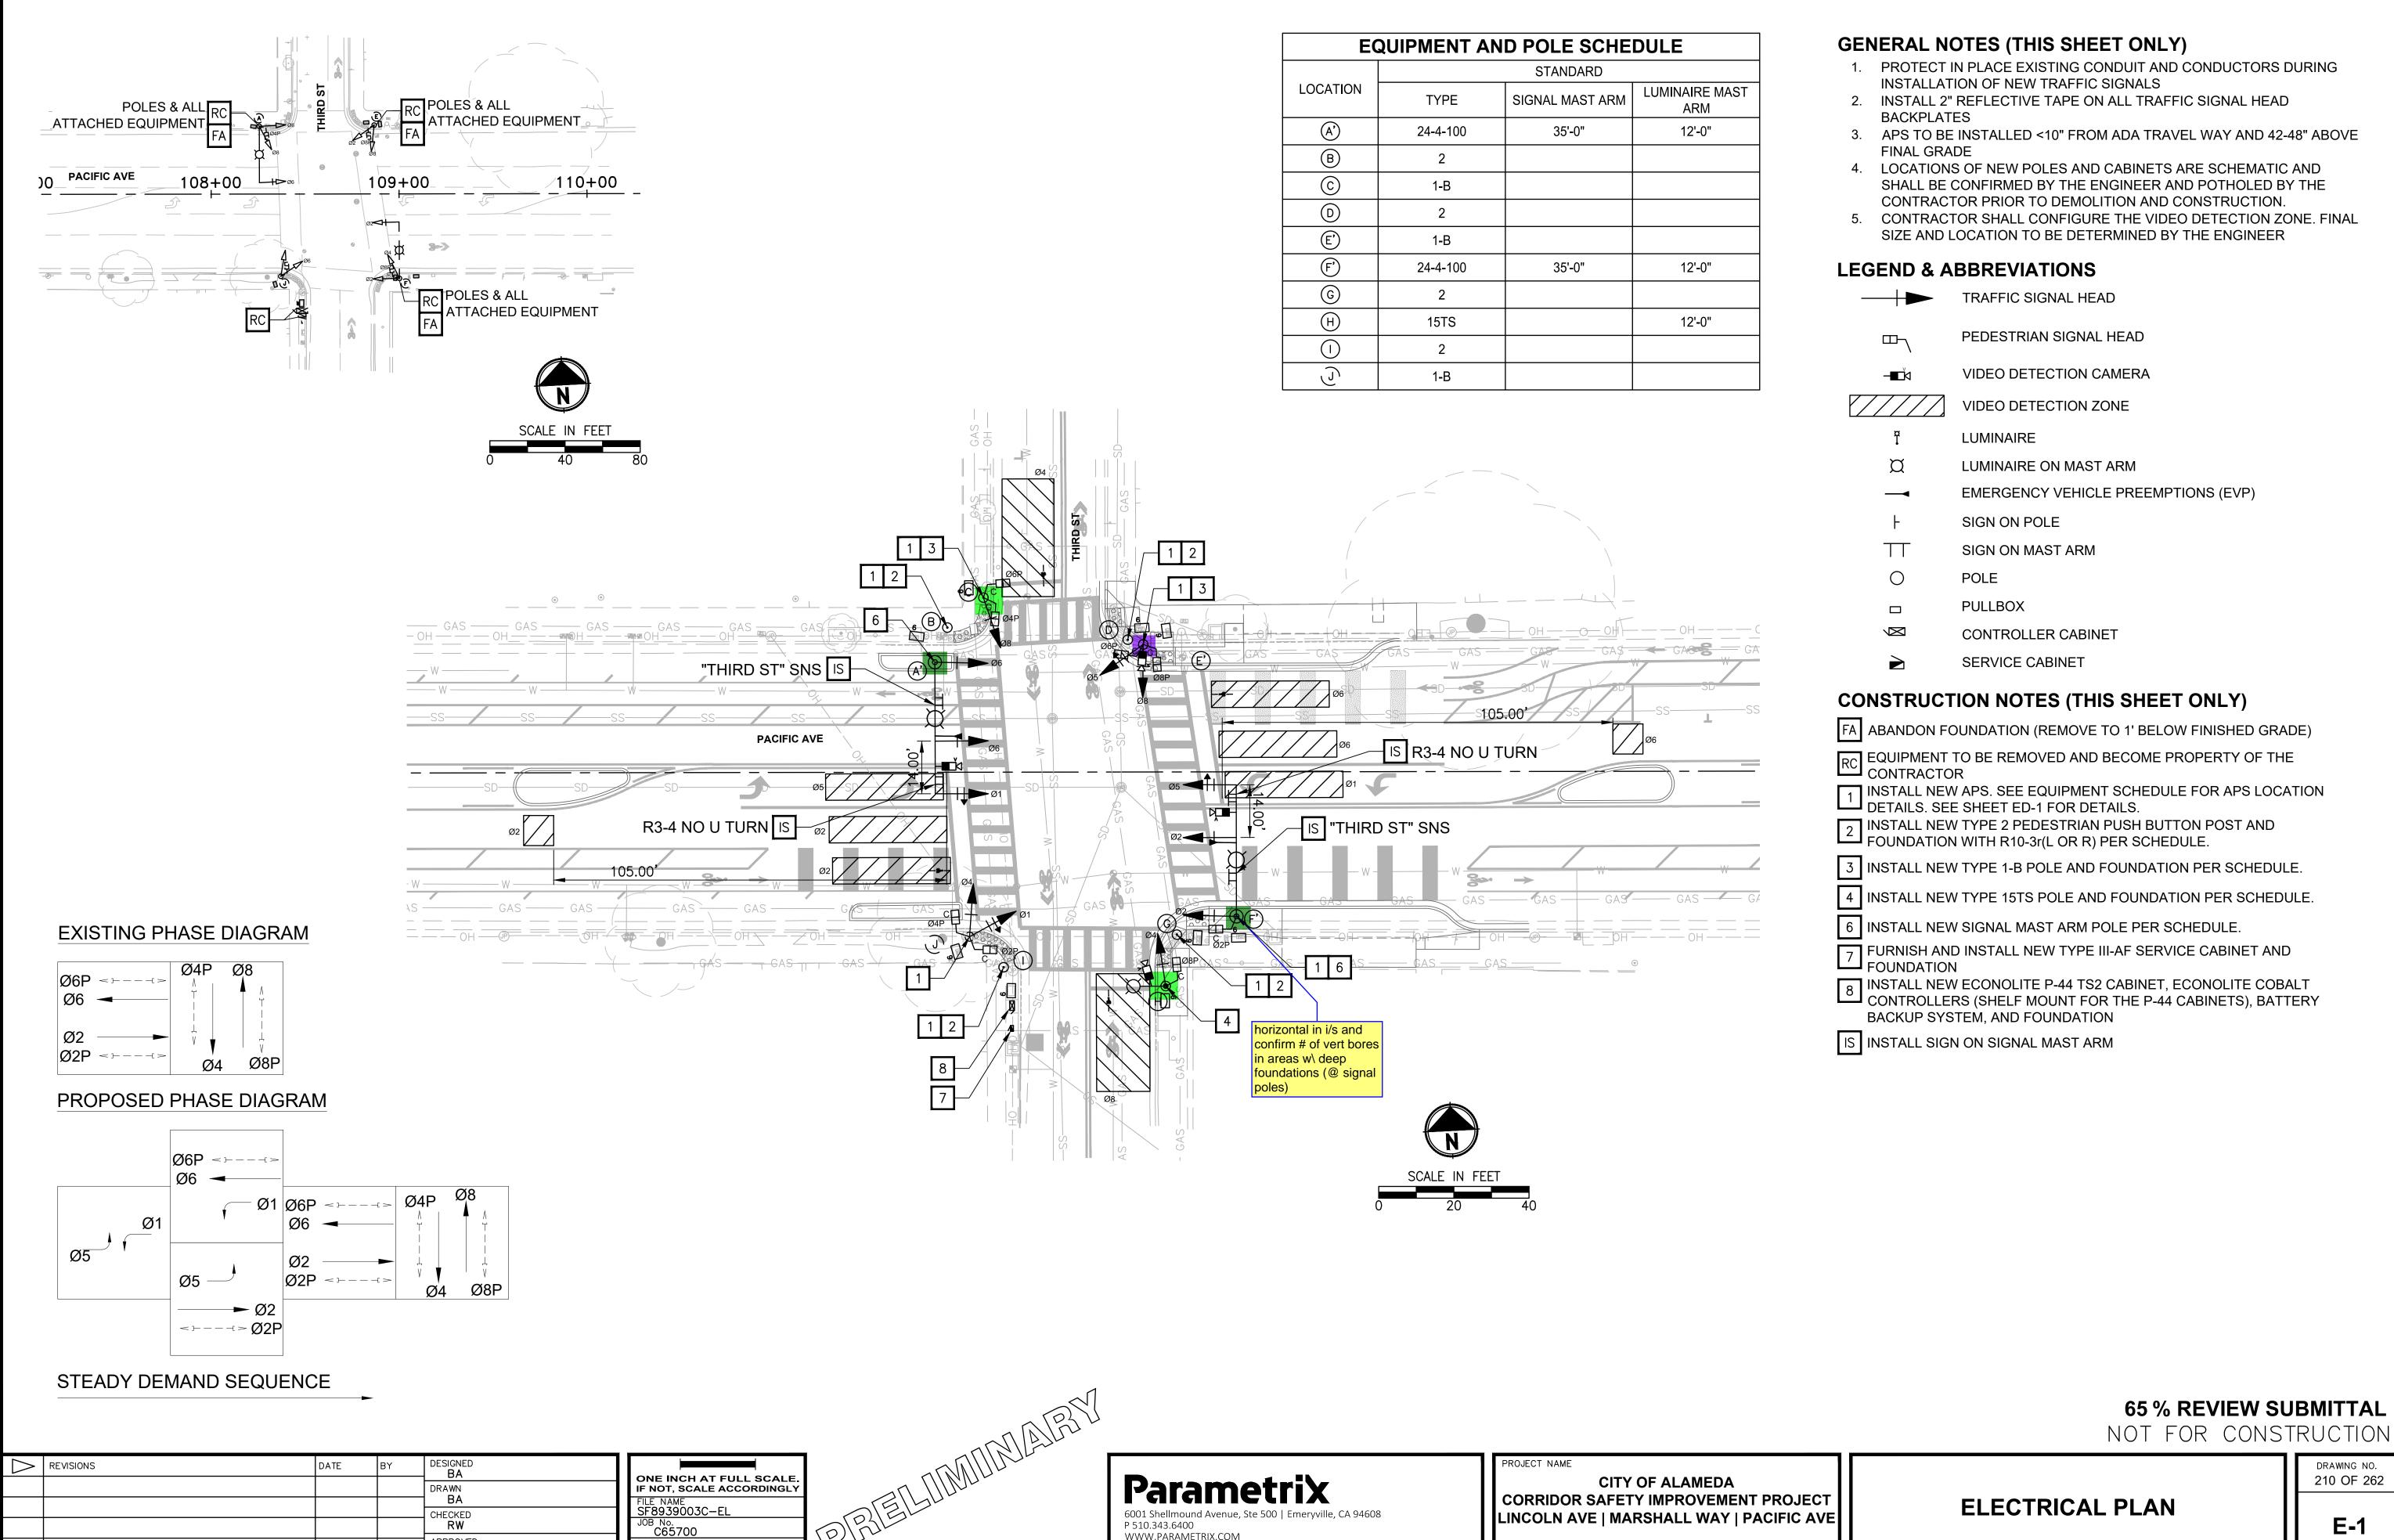

APPROVED DP

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				CON	DUCTO	OR SCI	HEDUL	.E					
AWG OR CABLE	COND. DESIGN.	NUMBER OF CONDUCTORS											
J. 12							RUN N	UMBER					
		NEW	NEW	NEW	NEW	NEW	NEW	NEW	NEW	NEW	NEW	NEW	NEW
		$\triangle$	2	3	4	5	6	$\triangle$	8	9	$\overline{\mathbb{A}}$		12
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	ф8Р												
	ф2APS												
	ф4PS												
	ф6APS		— CONDUCTOR SCUERULE TO RE										
	ф8APS	CONDUCTOR SCHEDULE TO BE COMPLETED AT 90% SUBMITTAL											
	SPARES		CO	MPLI	ETED	AT 9	90% \$	SUBN	/IITT/	<b>AL</b>			
	TOTAL #14												
#10	SICNAL COMMON												
#10	SIGNAL COMMON LUMINAIRES												
	LUMINAIRES												
	TOTAL #10												
	TOTAL #10												
VIDEO	CABLE												
DETECTION	O/ (BLL												
	EVA												
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<b>_</b>	EVC												
EVP	EVD												
	TOTAL EVP												
	LIDIUIT CITE												
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PEF	RCENT FILL												
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				EQUIPMENT AND POLE SCHEDULE													
LOCATION		STANDARD		LED LUMINAIRE	VEHICLE MOUN		PEDESTRIAN SIGNAL	PEDESTRI	SSIBLE AN SIGNAL PS)	SPECIAL REQUIREMENTS							
	TYPE	SIGNAL MAST ARM	LUMINAIRE MAST ARM	WATTAGE	MAST ARM	POLE	MOUNTING	PHASE	ARROW								
(A)	24-4-100	35'-0"	12'-0"	TBD	MAS MAS	SV-1-T				INSTALL VIDEO DETECTION CAMERA AND EVP ON SIGNAL MAST ARM. INSTALL "THIRD ST" NAME SIGN. INSTALL NO U TURN SIGN.							
B	2							TBD	TBD								
©	1-B					TV-1-T	SP-2-T	TBD	TBD								
0	2							TBD	TBD								
E'	1-B					TV-2-T	SP-2-T	TBD	TBD	INSTALL VIDEO DETECTION CAMERA ON POLE							
F)	24-4-100	35'-0"	12'-0"	TBD	MAS MAS	SV-1-T	SP-1-T	TBD	TBD	INSTALL VIDEO DETECTION CAMERA AND EVP ON SIGNAL MAST ARM. INSTALL "THIRD ST" NAME SIGN. INSTALL NO U TURN SIGN.							
G	2							TBD	TBD								
H	15TS		12'-0"	TBD		SV-1-T	SP-1-T			INSTALL VIDEO DETECTION CAMERA ON POLE							
	2							TBD	TBD								
J	1-B					TV-2-T	SP-2-T	TBD	TBD								

- MAP EXISTING MAST ARM POLE
- SLP STREET LIGHT POLE
- ALL DIMENSIONS ARE APPROXIMATE
- ALL APS ARE NEW

PATH	Δ	REVISIONS	DATE	BY	DESIGNED BA
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I: E2					CHECKED RW
4 YOUT:					APPROVED DP

ONE INCH AT FULL SCALE, IF NOT, SCALE ACCORDINGLY

FILE NAME
SF8939003C-EL

JOB No.
C65700

DATE
06/2025

E. PRELIMINATION .


Parametrix
6001 Shellmound Avenue, Ste 500 | Emeryville, CA 94608
P 510.343.6400
WWW.PARAMETRIX.COM

PROJECT NAME

CITY OF ALAMEDA CORRIDOR SAFETY IMPROVEMENT PROJECT LINCOLN AVE | MARSHALL WAY | PACIFIC AVE 65 % REVIEW SUBMITTAL NOT FOR CONSTRUCTION

**ELECTRICAL PLAN** 

DRAWING NO. 211 OF 262

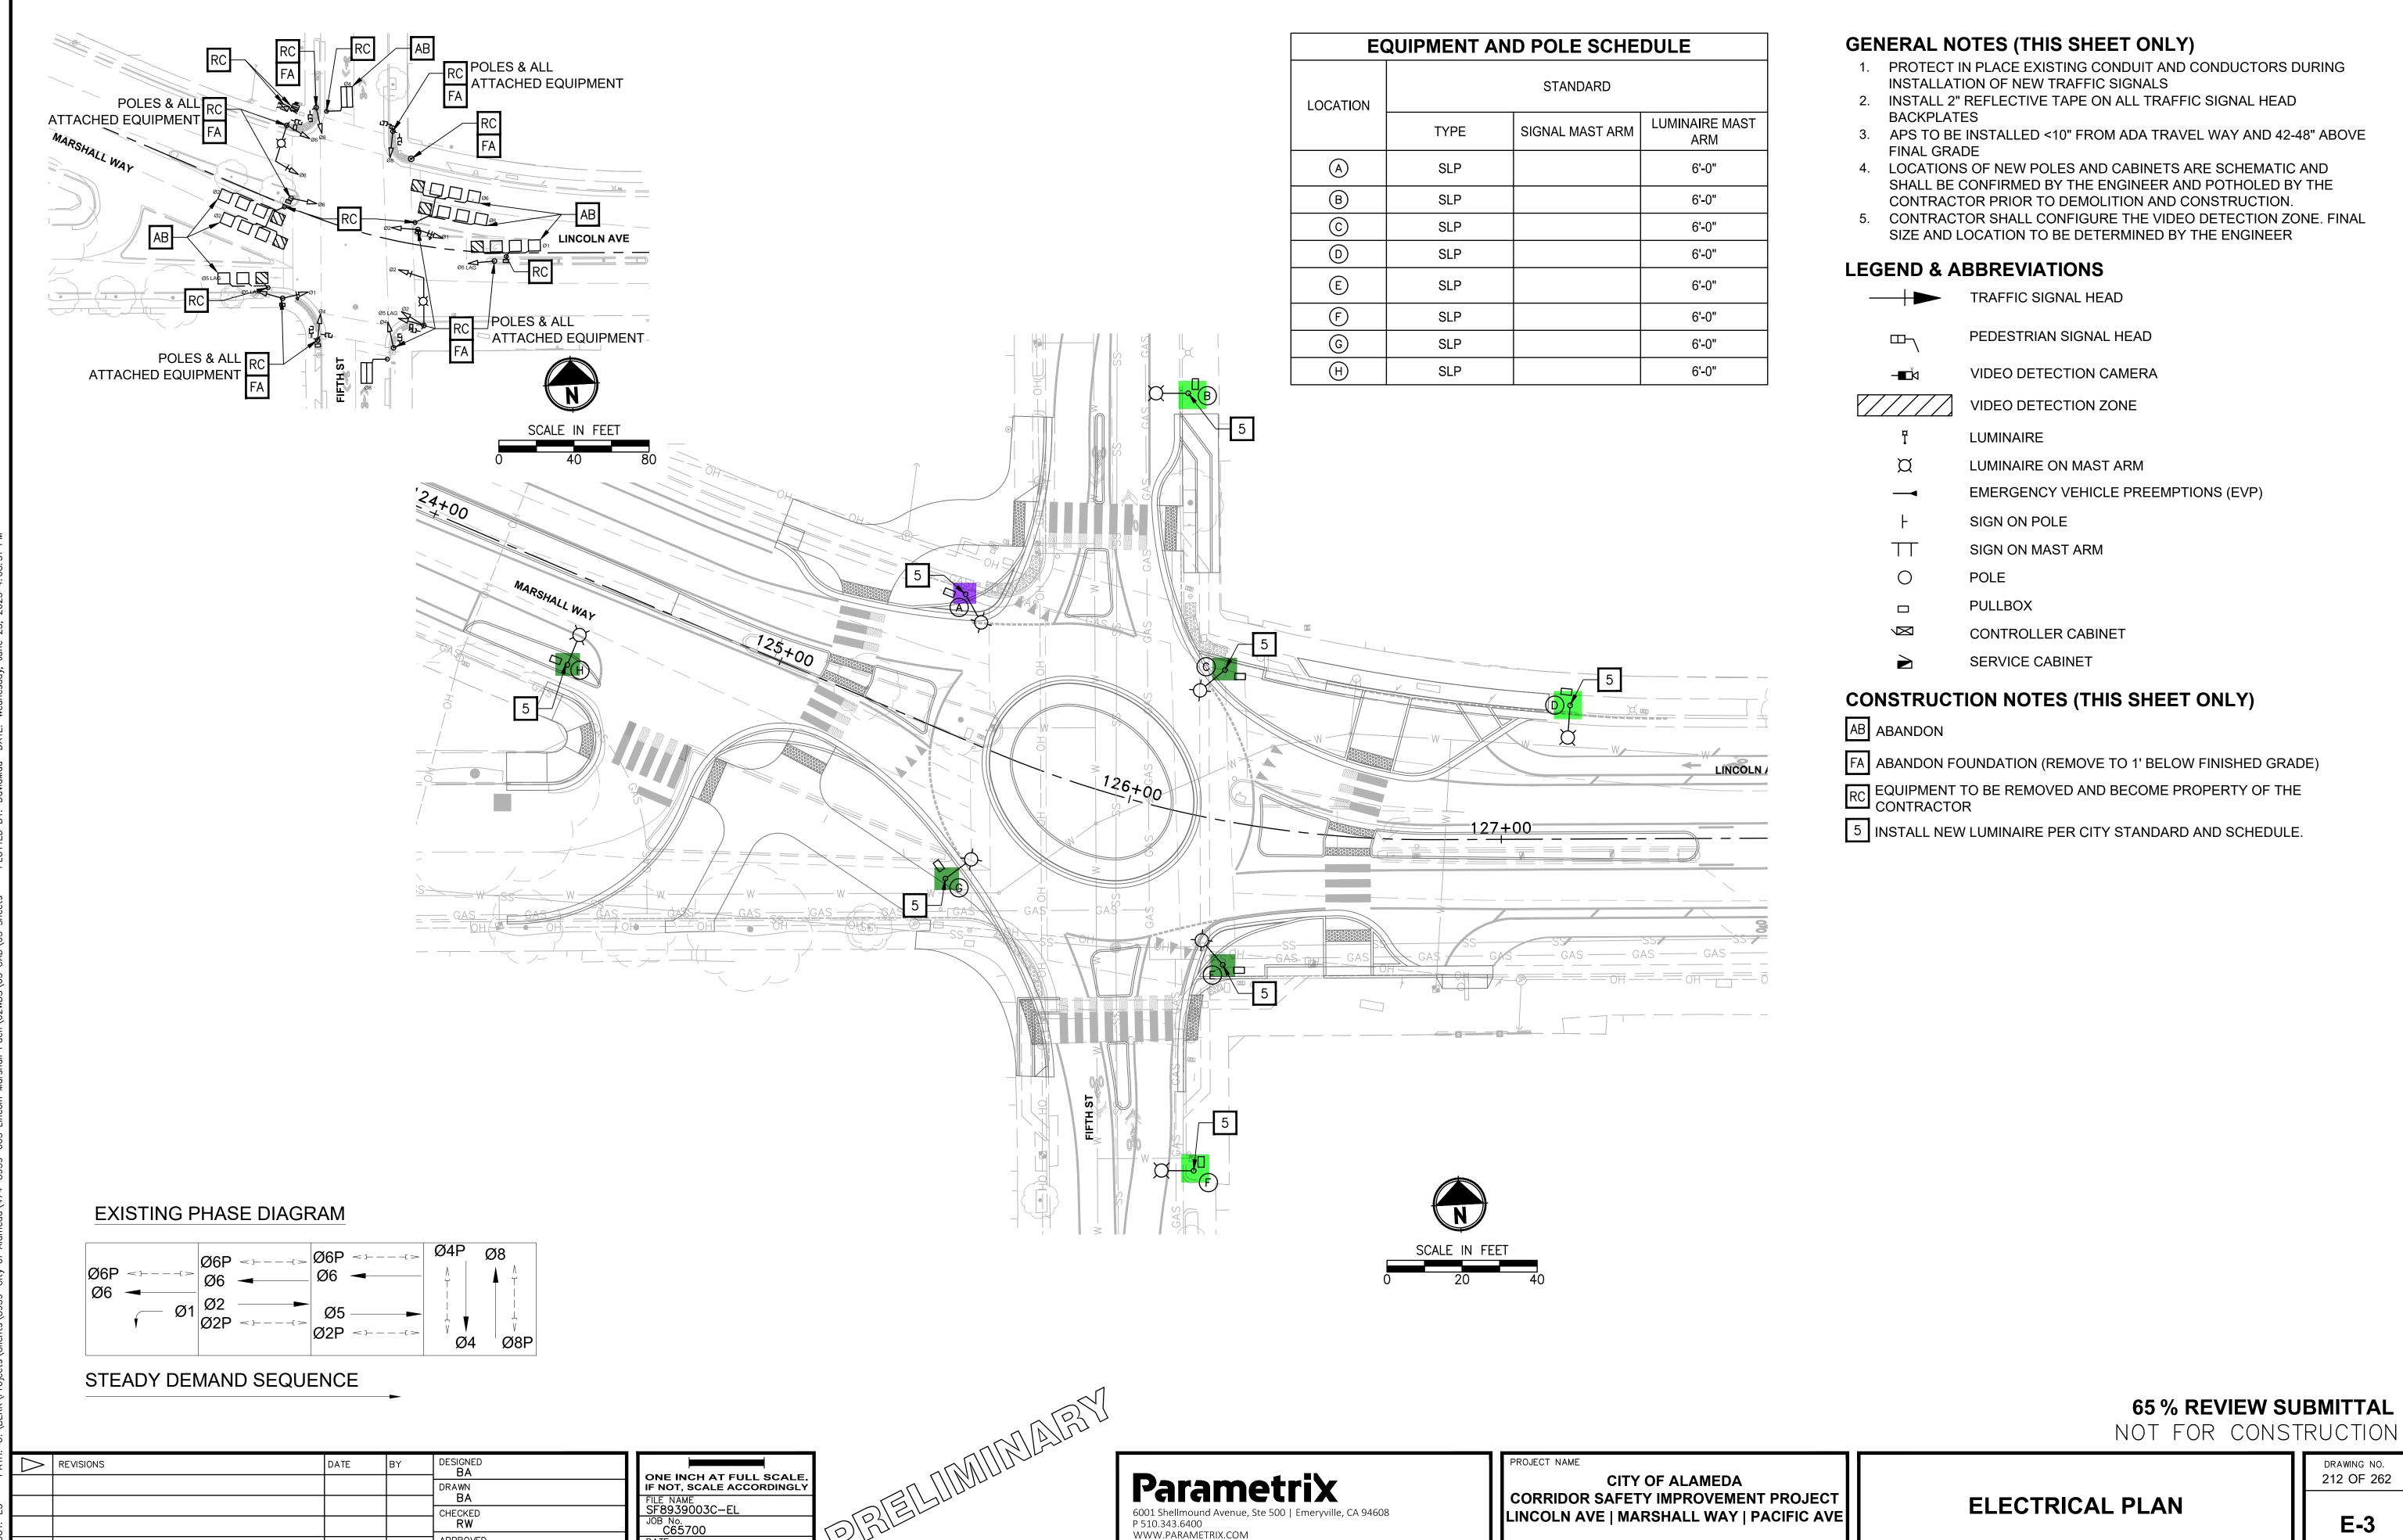

212 OF 262

				CON	DUCTO	OR SCI	HEDUL	.E					
AWG OR CABLE	COND. DESIGN.	NUMBER OF CONDUCTORS											
J. 12							RUN N	UMBER					
		NEW	NEW	NEW	NEW	NEW	NEW	NEW	NEW	NEW	NEW	NEW	NEW
		$\triangle$	2	3	4	5	6	$\triangle$	8	9	$\overline{\mathbb{A}}$		12
	ф1												
	φ2												
	ф4												
	φ5												
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	ф8												
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#14	ф6Р												
	ф8Р												
	ф2APS												
	ф4PS												
	ф6APS		— CONDUCTOR SCUERULE TO RE										
	ф8APS	CONDUCTOR SCHEDULE TO BE COMPLETED AT 90% SUBMITTAL											
	SPARES		CO	MPLI	ETED	AT 9	90% \$	SUBN	/IITT/	<b>AL</b>			
	TOTAL #14												
#10	SICNAL COMMON												
#10	SIGNAL COMMON LUMINAIRES												
	LUMINAIRES												
	TOTAL #10												
	TOTAL #10												
VIDEO	CABLE												
DETECTION	O/ (BLL												
	EVA												
	EVB												
<b>_</b>	EVC												
EVP	EVD												
	TOTAL EVP												
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PEF	RCENT FILL												
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				EQUIPN	IENT AND	POLE S	CHEDULE			
LOCATION		STANDARD			1	VEHICLE SIGNAL MOUNTING		ACCESSIBLE PEDES	STRIAN SIGNAL (APS)	SPECIAL REQUIREMENTS
	TYPE	SIGNAL MAST ARM	LUMINAIRE MAST ARM	LUMINAIRE WATTAGE	MAST ARM	POLE	SIGNAL MOUNTING	PHASE	ARROW	
A	SLP		6'-0"	TBD						
В	SLP		6'-0"	TBD						
©	SLP		6'-0"	TBD						
D	SLP		6'-0"	TBD						
E	SLP		6'-0"	TBD						
F	SLP		6'-0"	TBD						
G	SLP		6'-0"	TBD						
H	SLP		6'-0"	TBD						

- MAP EXISTING MAST ARM POLE
- SLP STREET LIGHT POLE
- ALL DIMENSIONS ARE APPROXIMATE
- ALL APS ARE NEW

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					DRAWN
E 4					BA CHECKED
					RW
 					APPROVED

ONE INCH AT FULL SCALE.
IF NOT, SCALE ACCORDINGLY

FILE NAME
SF8939003C-EL

JOB No.
C65700

DATE
06/2025

Parametrix
6001 Shellmound Avenue, Ste 500 | Emeryville, CA 94608
P 510.343.6400
WWW.PARAMETRIX.COM

PROJECT NAME


CITY OF ALAMEDA CORRIDOR SAFETY IMPROVEMENT PROJECT LINCOLN AVE | MARSHALL WAY | PACIFIC AVE

65 % REVIEW SUBMITTAL NOT FOR CONSTRUCTION

DRAWING NO. 213 OF 262

E-4

**ELECTRICAL PLAN** 

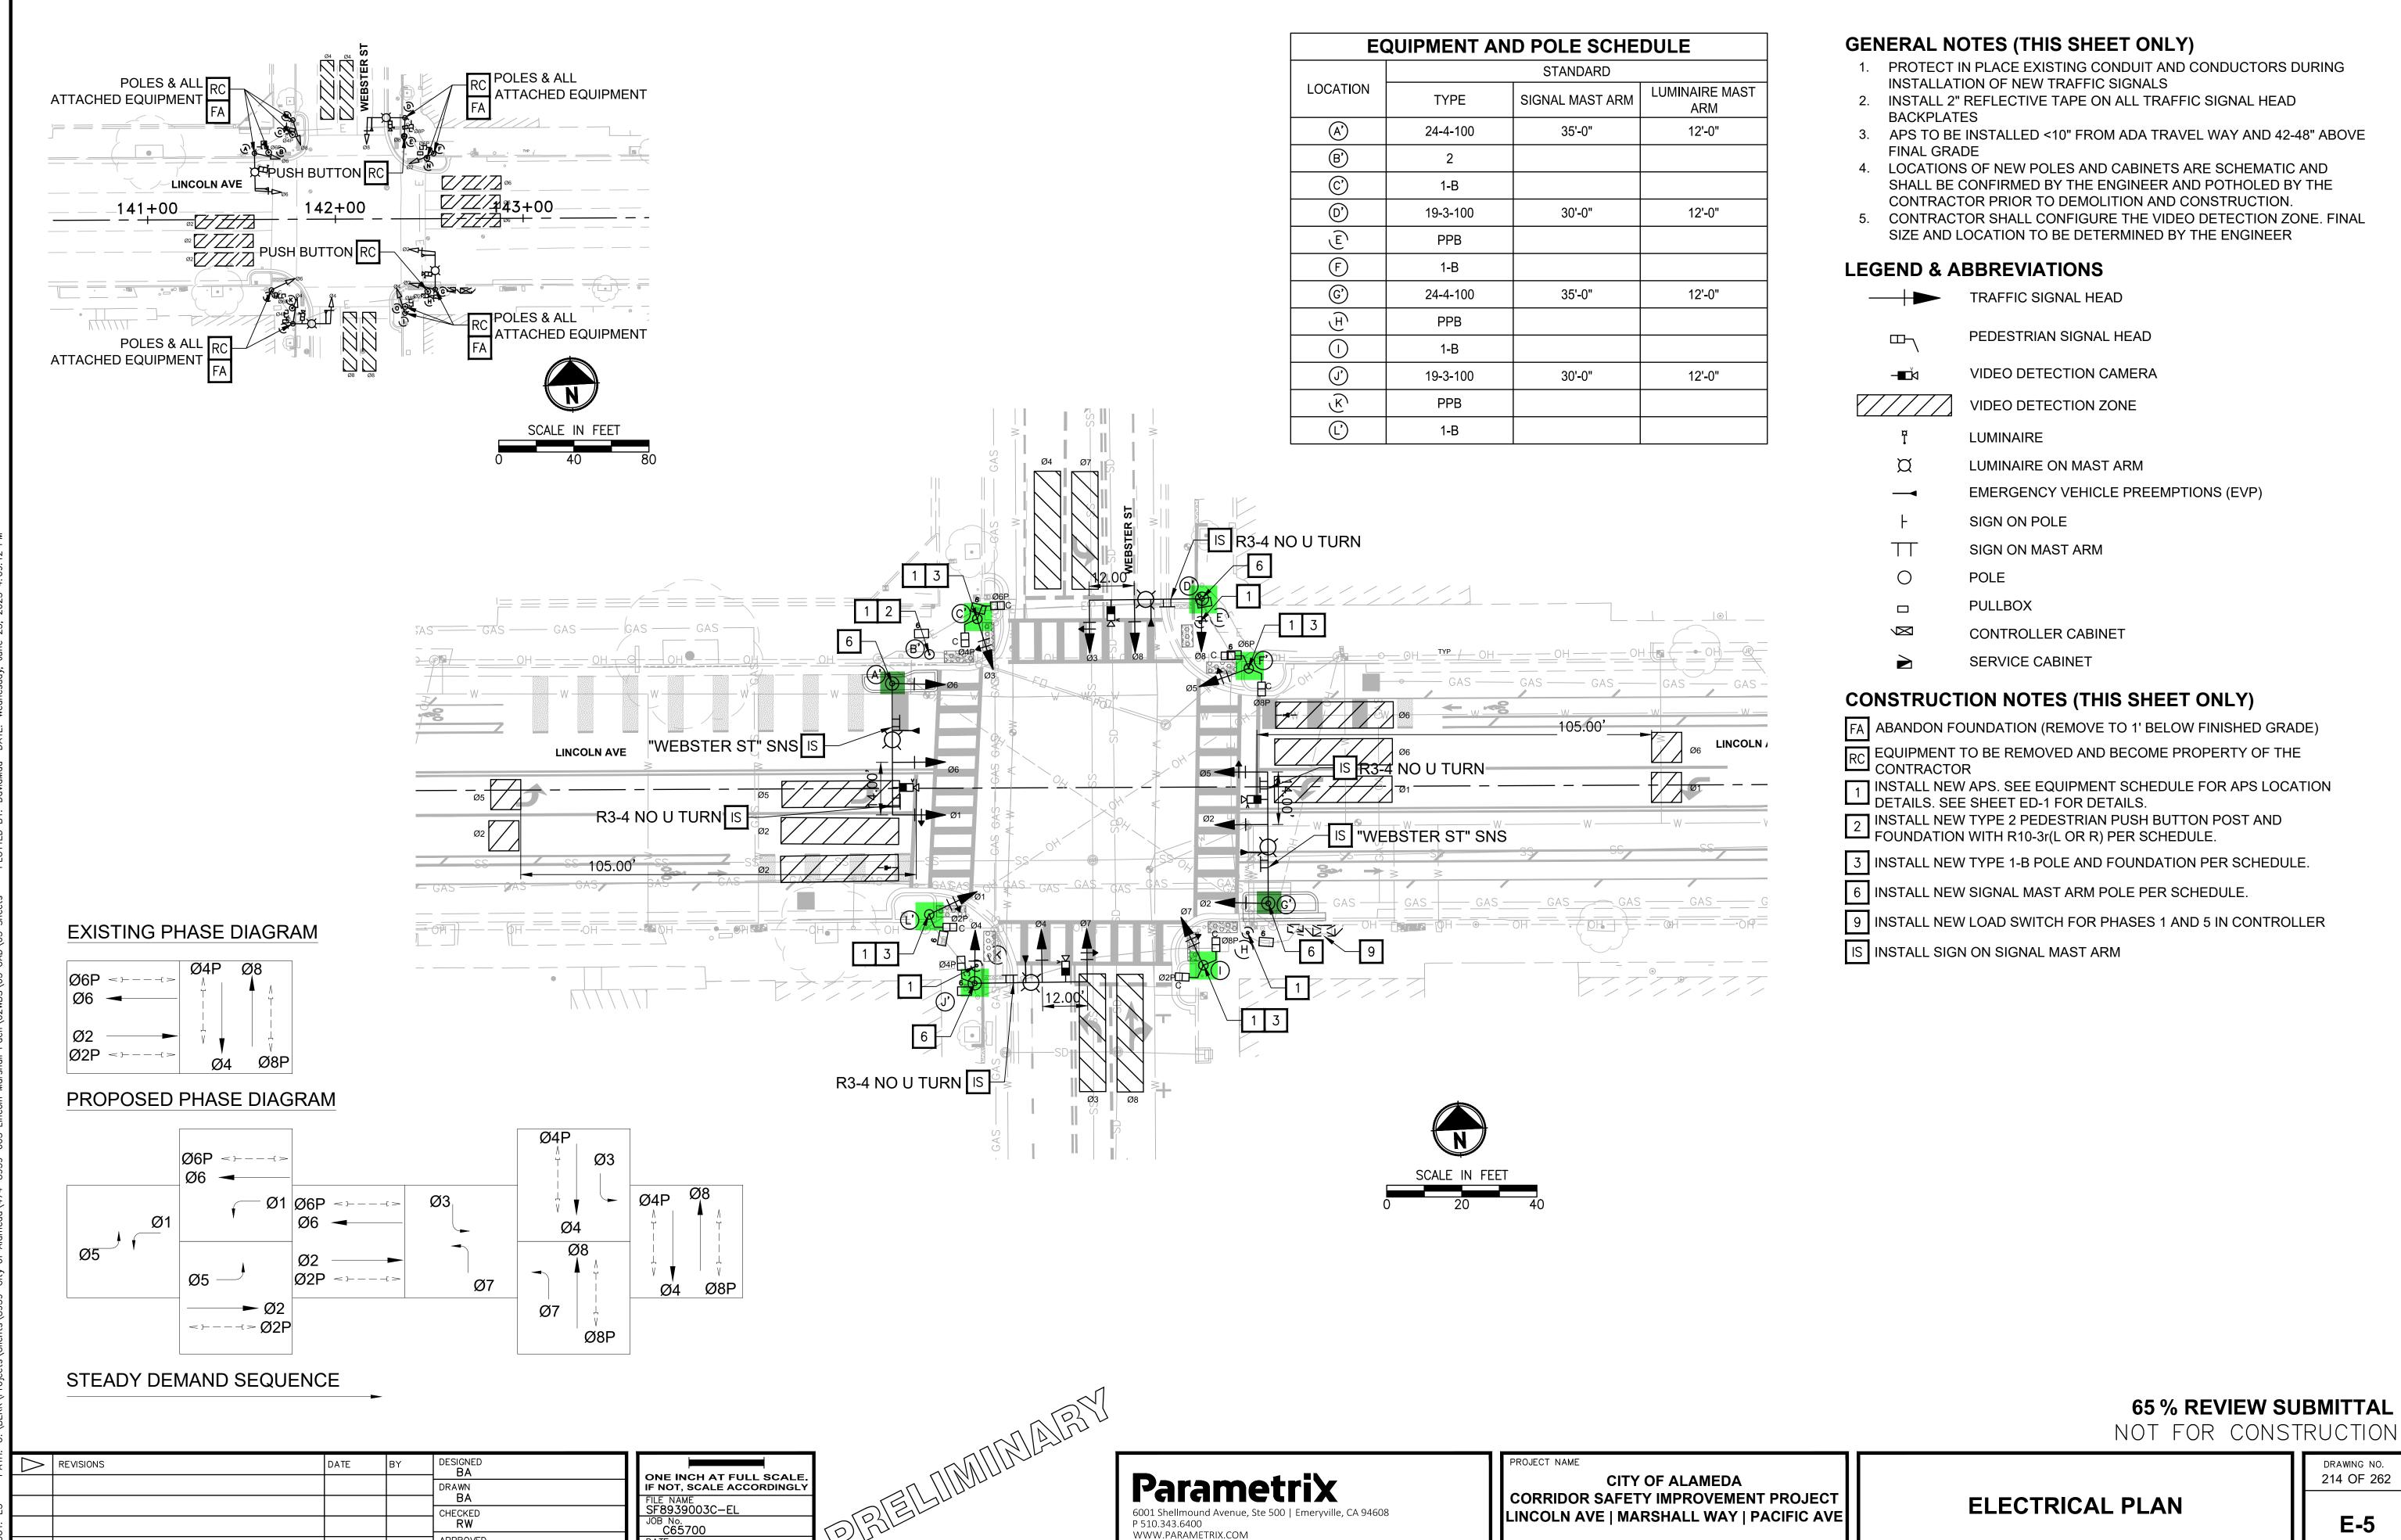

APPROVED **DP** 

DRAWING NO. 214 OF 262

				CON	IDUCT	OR SCI	HEDUL	.E							
AWG OR CABLE	COND. DESIGN.	NUMBER OF CONDUCTORS													
							RUN N	UMBER							
		NEW	NEW	NEW	NEW	NEW	NEW	NEW	NEW	NEW	NEW	NEW	NEW		
		1	2	3	4	5	6	$\triangle$	8	9	$\overline{\mathcal{M}}$		12		
	φ1														
	φ2														
	ф4														
	φ5														
	ф6														
	ф8														
	φ2P														
	ф4Р														
#14	ф6Р														
	ф8Р														
	φ2APS														
	ф4PS														
	φ6APS		— CONDUCTOR SCHEDINE TO RE												
	φ8APS		CONDUCTOR SCHEDULE TO BE												
	SPARES		CO	<b>MPL</b> I	ETED	AT $9$	90% \$	SUBN	/IITT/	<b>A</b> L					
									1	\ <u> </u>					
	TOTAL #14														
#10	SIGNAL COMMON														
	LUMINAIRES														
	TOTAL #10														
VIDEO															
DETECTION	CABLE														
	EVA														
	EVB														
EVP	EVC														
	EVD														
	TOTAL EVP														
CON	NDUIT SIZE														
	CENT FILL														

				EQUIPM	ENT AND F	POLE SC	HEDULE			
LOCATION		STANDARD		LED LUMINAIRE	VEHICLE MOUN		PEDESTRIAN SIGNAL		E PEDESTRIAN AL (APS)	SPECIAL REQUIREMENTS
LOCATION	TYPE	SIGNAL MAST ARM	LUMINAIRE MAST ARM	WATTAGE	MAST ARM	POLE	MOUNTING	PHASE	ARROW	SI EGIAL REQUIREIVIO
(A')	24-4-100	35'-0"	12'-0"	TBD	MAS MAS	SV-1-T				INSTALL VIDEO DETECTION CAMERA AND EVC ON SIGNAL MAST ARM. INSTALL "WEBSTER ST" NAME SIGN. INSTALL NO U TURN SIGN.
B')	2							TBD	TBD	
©`	1-B					TV-1-T	SP-2-T	TBD	TBD	
(D)	19-3-100	30'-0"	12'-0"	TBD	MAS MAS	SV-1-T				INSTALL VIDEO DETECTION CAMERA ON LUMINAIRE MAST ARM. INSTALL "LINCOLN AVE" STREET NAME SIGN AND EVP ON SIGNAL MAST ARM.
(ப)	PPB							TBD	TBD	
F	1-B					TV-1-T	SP-2-T	TBD	TBD	
(G')	24-4-100	35'-0"	12'-0"	TBD	MAS MAS	SV-1-T				INSTALL VIDEO DETECTION CAMERA AND EVP ON SIGNAL MAST ARM. INSTALL "WEBSTER ST" NAME SIGN. INSTALL NO U TURN SIGN.
(H)	PPB							TBD	TBD	
	1-B					TV-1-T	SP-2-T	TBD	TBD	
(J')	19-3-100	30'-0"	12'-0"	TBD	MAS MAS		SP-1-T	TV-1-T		INSTALL VIDEO DETECTION CAMERA ON LUMINAIRE MAST ARM. INSTALL " LINCOLN AVE" STREET NAME SIGN AND EVP ON SIGNAL MAST ARM.
K	PPB							TBD	TBD	
(Ľ)	1-B					TV-1-T	SP-1-T	TBD	TBD	

- MAP EXISTING MAST ARM POLE
- SLP STREET LIGHT POLE
- ALL DIMENSIONS ARE APPROXIMATE
- ALL APS ARE NEW

РАТН:	$\triangle$	REVISIONS	DATE	BY	DESIGNED BA
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ONE INCH AT FULL SCALE.
IF NOT, SCALE ACCORDINGLY

FILE NAME
SF8939003C-EL

JOB No.
C65700

DATE
06/2025

Parametrix
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P 510.343.6400
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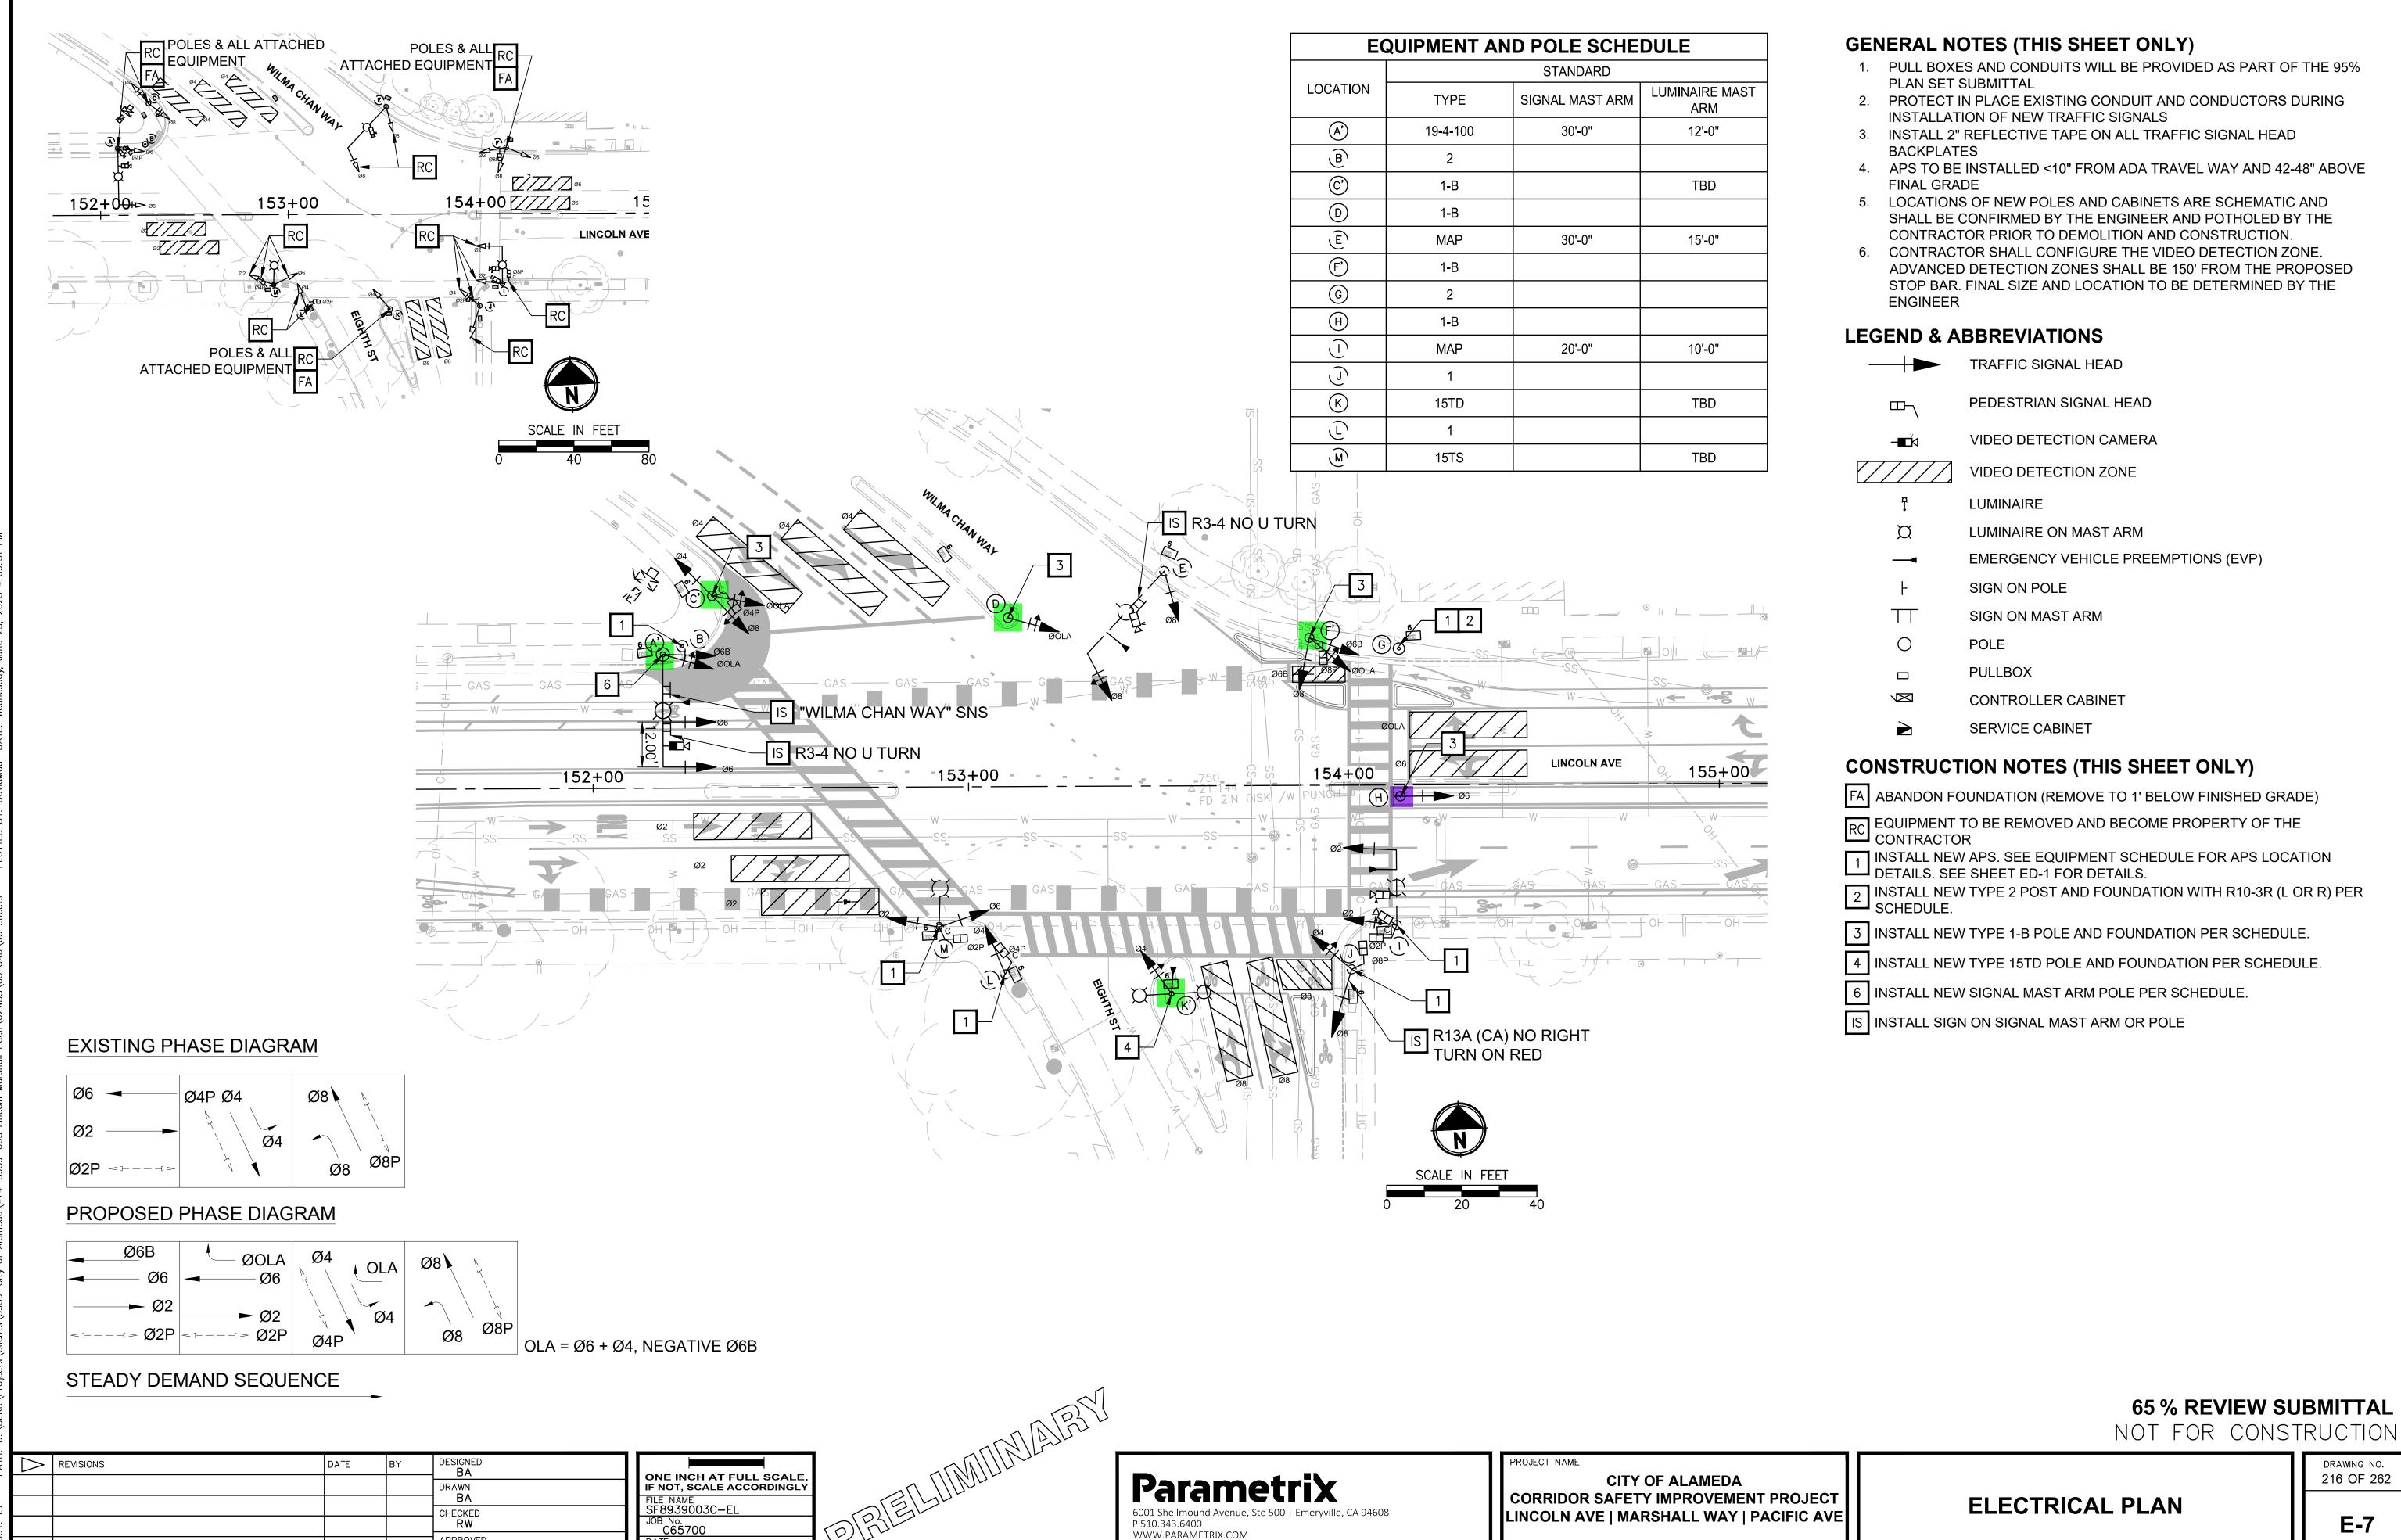
PROJECT NAME

CITY OF ALAMEDA CORRIDOR SAFETY IMPROVEMENT PROJECT LINCOLN AVE | MARSHALL WAY | PACIFIC AVE

65 % REVIEW SUBMITTAL NOT FOR CONSTRUCTION

**ELECTRICAL PLAN** 

DRAWING NO. 215 OF 262




216 OF 262

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				EQUIPN	IENT AND	POLE S	CHEDULE			
LOCATION		STANDARD		LED LUMINAIRE	VEHICLE MOUN		PEDESTRIAN SIGNAL		PEDESTRIAN L (APS)	SPECIAL REQUIREMENTS
Looming	TYPE	SIGNAL MAST ARM	LUMINAIRE MAST ARM	WATTAGE	MAST ARM	POLE	MOUNTING	PHASE	ARROW	OF EON AL TALGOTIALIMENTO
(A)	19-4-100	30'-0"	12'-0"	TBD	MAS MAS	SV-2-TC				SV-2-TC TO PROVIDE MIN 8" OFFSET BETWEEN TWO 12" SIGNAL HEADS BOTH FACING EAST
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©')	1-B		TBD	TBD		SV-3-T	SP-1-T			
D	1-B					TV-1-T				
Ē	MAP	30'-0"	15'-0"	TBD	MAS	SV-1-T				
F	1-B					TV-3-TA	SP-1-T			TV-3-TA TO PROVIDE MIN 8" OFFSET BETWEEN TWO 12" SIGNAL HEADS BOTH FACING EAST
G	2							TBD	TBD	
Н	1-B					TV-1-T				
1	MAP	20'-0"	10'-0"	TBD	MAS	SV-1-T	SP-1-T	TBD	TBD	
(j	1					TV-2-T	SP-1-T	TBD	TBD	
K	15TD		TBD	TBD		SV-1-T				
(j)	1					TV-1-T	SP-1-T	TBD	TBD	
M	15TS		TBD	TBD		SV-2-T	SP-1-T	TBD	TBD	

- MAP EXISTING MAST ARM POLE
- SLP STREET LIGHT POLE
- ALL DIMENSIONS ARE APPROXIMATE
- ALL APS ARE NEW

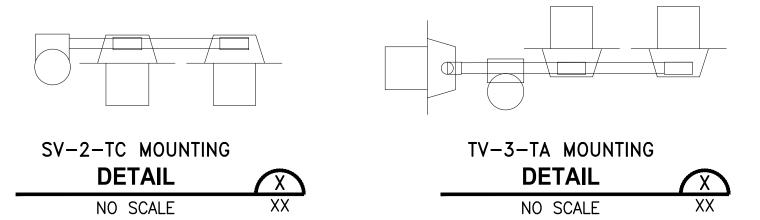

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ONE INCH AT FULL SCALE.
IF NOT, SCALE ACCORDINGLY

FILE NAME
SF8939003C-EL

JOB No.
C65700

DATE
06/2025


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P 510.343.6400
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PROJECT NAME

CITY OF ALAMEDA CORRIDOR SAFETY IMPROVEMENT PROJECT LINCOLN AVE | MARSHALL WAY | PACIFIC AVE

65 % REVIEW SUBMITTAL NOT FOR CONSTRUCTION

DRAWING NO. 217 OF 262 **ELECTRICAL PLAN** 

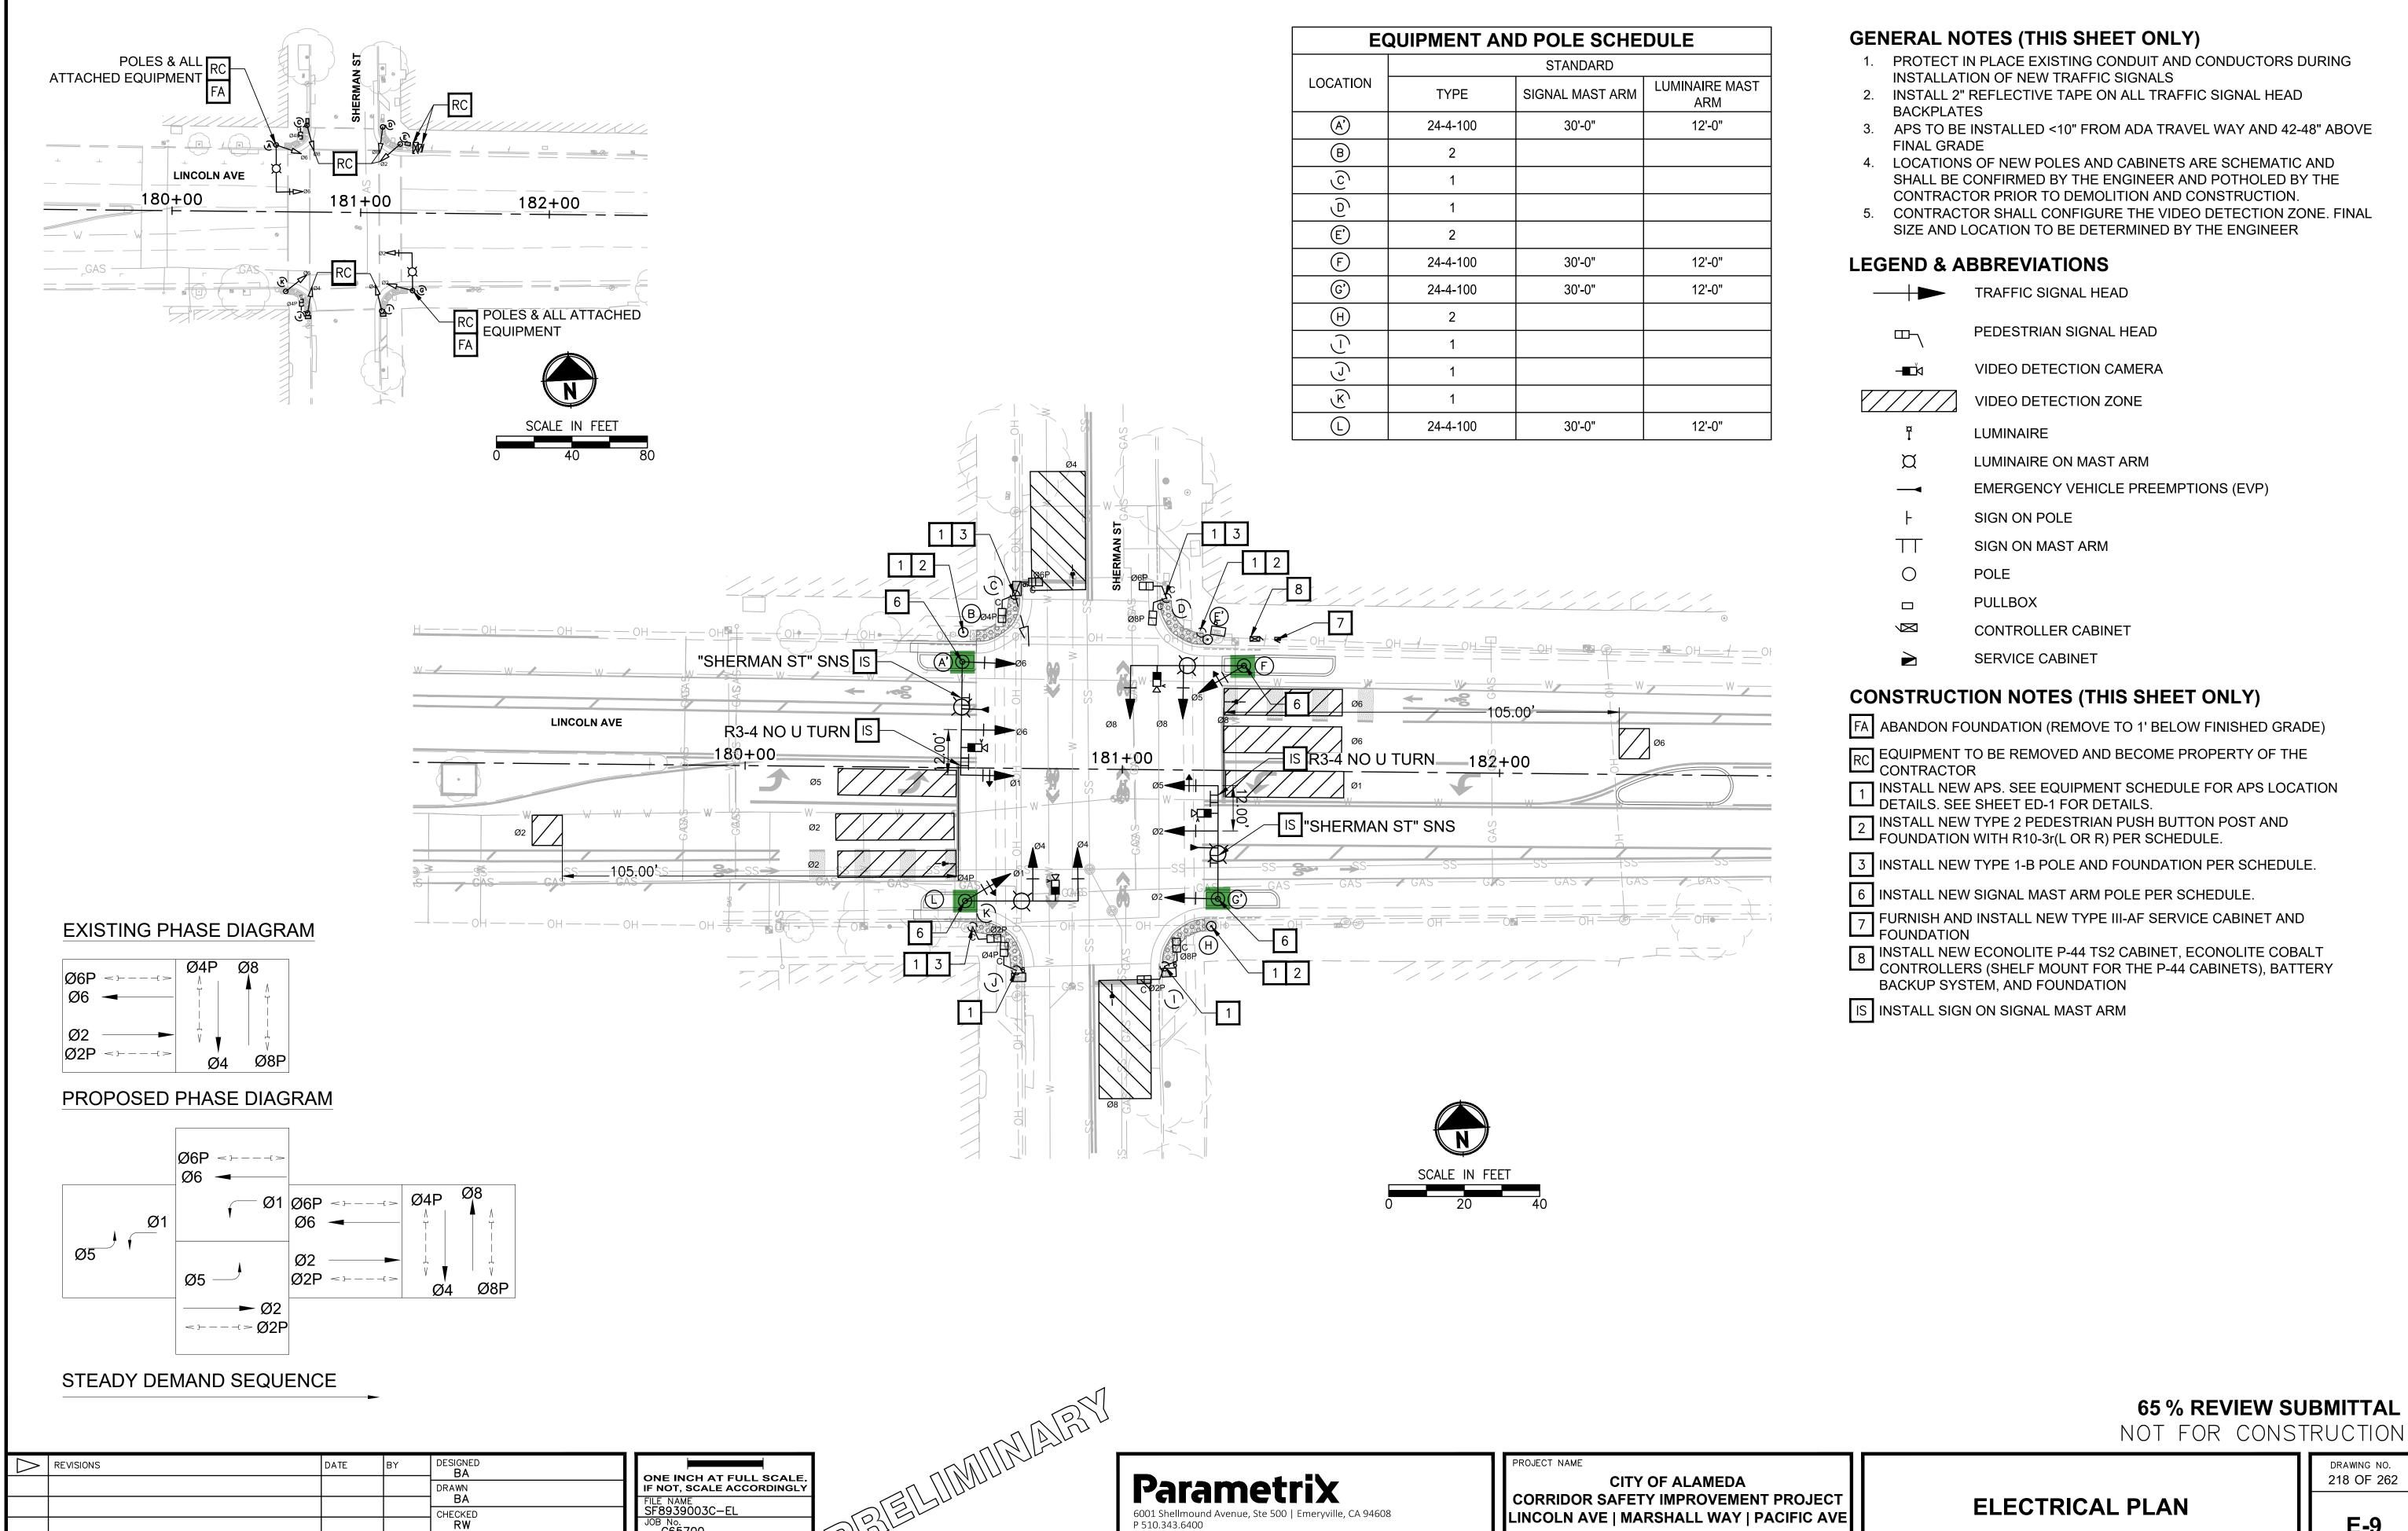

APPROVED **DP** 

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218 OF 262

**ELECTRICAL PLAN** 

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AWG OR CABLE	COND. DESIGN.	NUMBER OF CONDUCTORS  IGN.											
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LOCATION		STANDARD		LED LUMINAIRE	VEHICLE MOUN		PEDESTRIAN SIGNAL		PEDESTRIAN AL (APS)	SPECIAL REQUIREMENTS
LOCATION	TYPE	SIGNAL MAST ARM	LUMINAIRE MAST ARM	WATTAGE	MAST ARM	POLE	MOUNTING	PHASE	ARROW	OF EOIAL REGUIREMENTS
A <sup>*</sup>	24-4-100	30'-0"	12'-0"	TBD	MAS MAS	SV-1-T				INSTALL VIDEO DETECTION CAMERA AND EVP ON SIGNAL MAST ARM. INSTALL "SHERMAN ST" STREET NAME SIGN. INSTALL NO U TURN SIGN.
В	2							TBD	TBD	
0	1						SP-2-T	TBD	TBD	
0	1						SP-2-T	TBD	TBD	
E')	2							TBD	TBD	
F	24-4-100	30'-0"	12'-0"	TBD	MAS MAS	SV-1-T				INSTALL VIDEO DETECTION CAMERA ON LUMINAIRE MAST ARM
<u>©</u>	24-4-100	30'-0"	12'-0"	TBD	MAS MAS	SV-1-T				INSTALL VIDEO DETECTION CAMERA AND EVP ON SIGNAL MAST ARM. INSTALL "SHERMAN ST" STREET NAME SIGN. INSTALL NO U TURN SIGN.
H	2							TBD	TBD	
<u></u>	1						SP-2-T	TBD	TBD	
<u>J</u>	1						SP-1-T	TBD	TBD	
K	1						SP-1-T	TBD	TBD	
(L)	24-4-100	30'-0"	12'-0"	TBD	MAS MAS	SV-1-T				INSTALL VIDEO DETECTION CAMERA ON LUMINAIRE MAST ARM

- MAP EXISTING MAST ARM POLE
- SLP STREET LIGHT POLE
- ALL DIMENSIONS ARE APPROXIMATE
- ALL APS ARE NEW

(	$\triangle$	REVISIONS	DATE	BY	DESIGNED BA	
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ONE INCH AT FULL SCALE.
IF NOT, SCALE ACCORDINGLY

FILE NAME
SF8939003C-EL

JOB No.
C65700

DATE
06/2025

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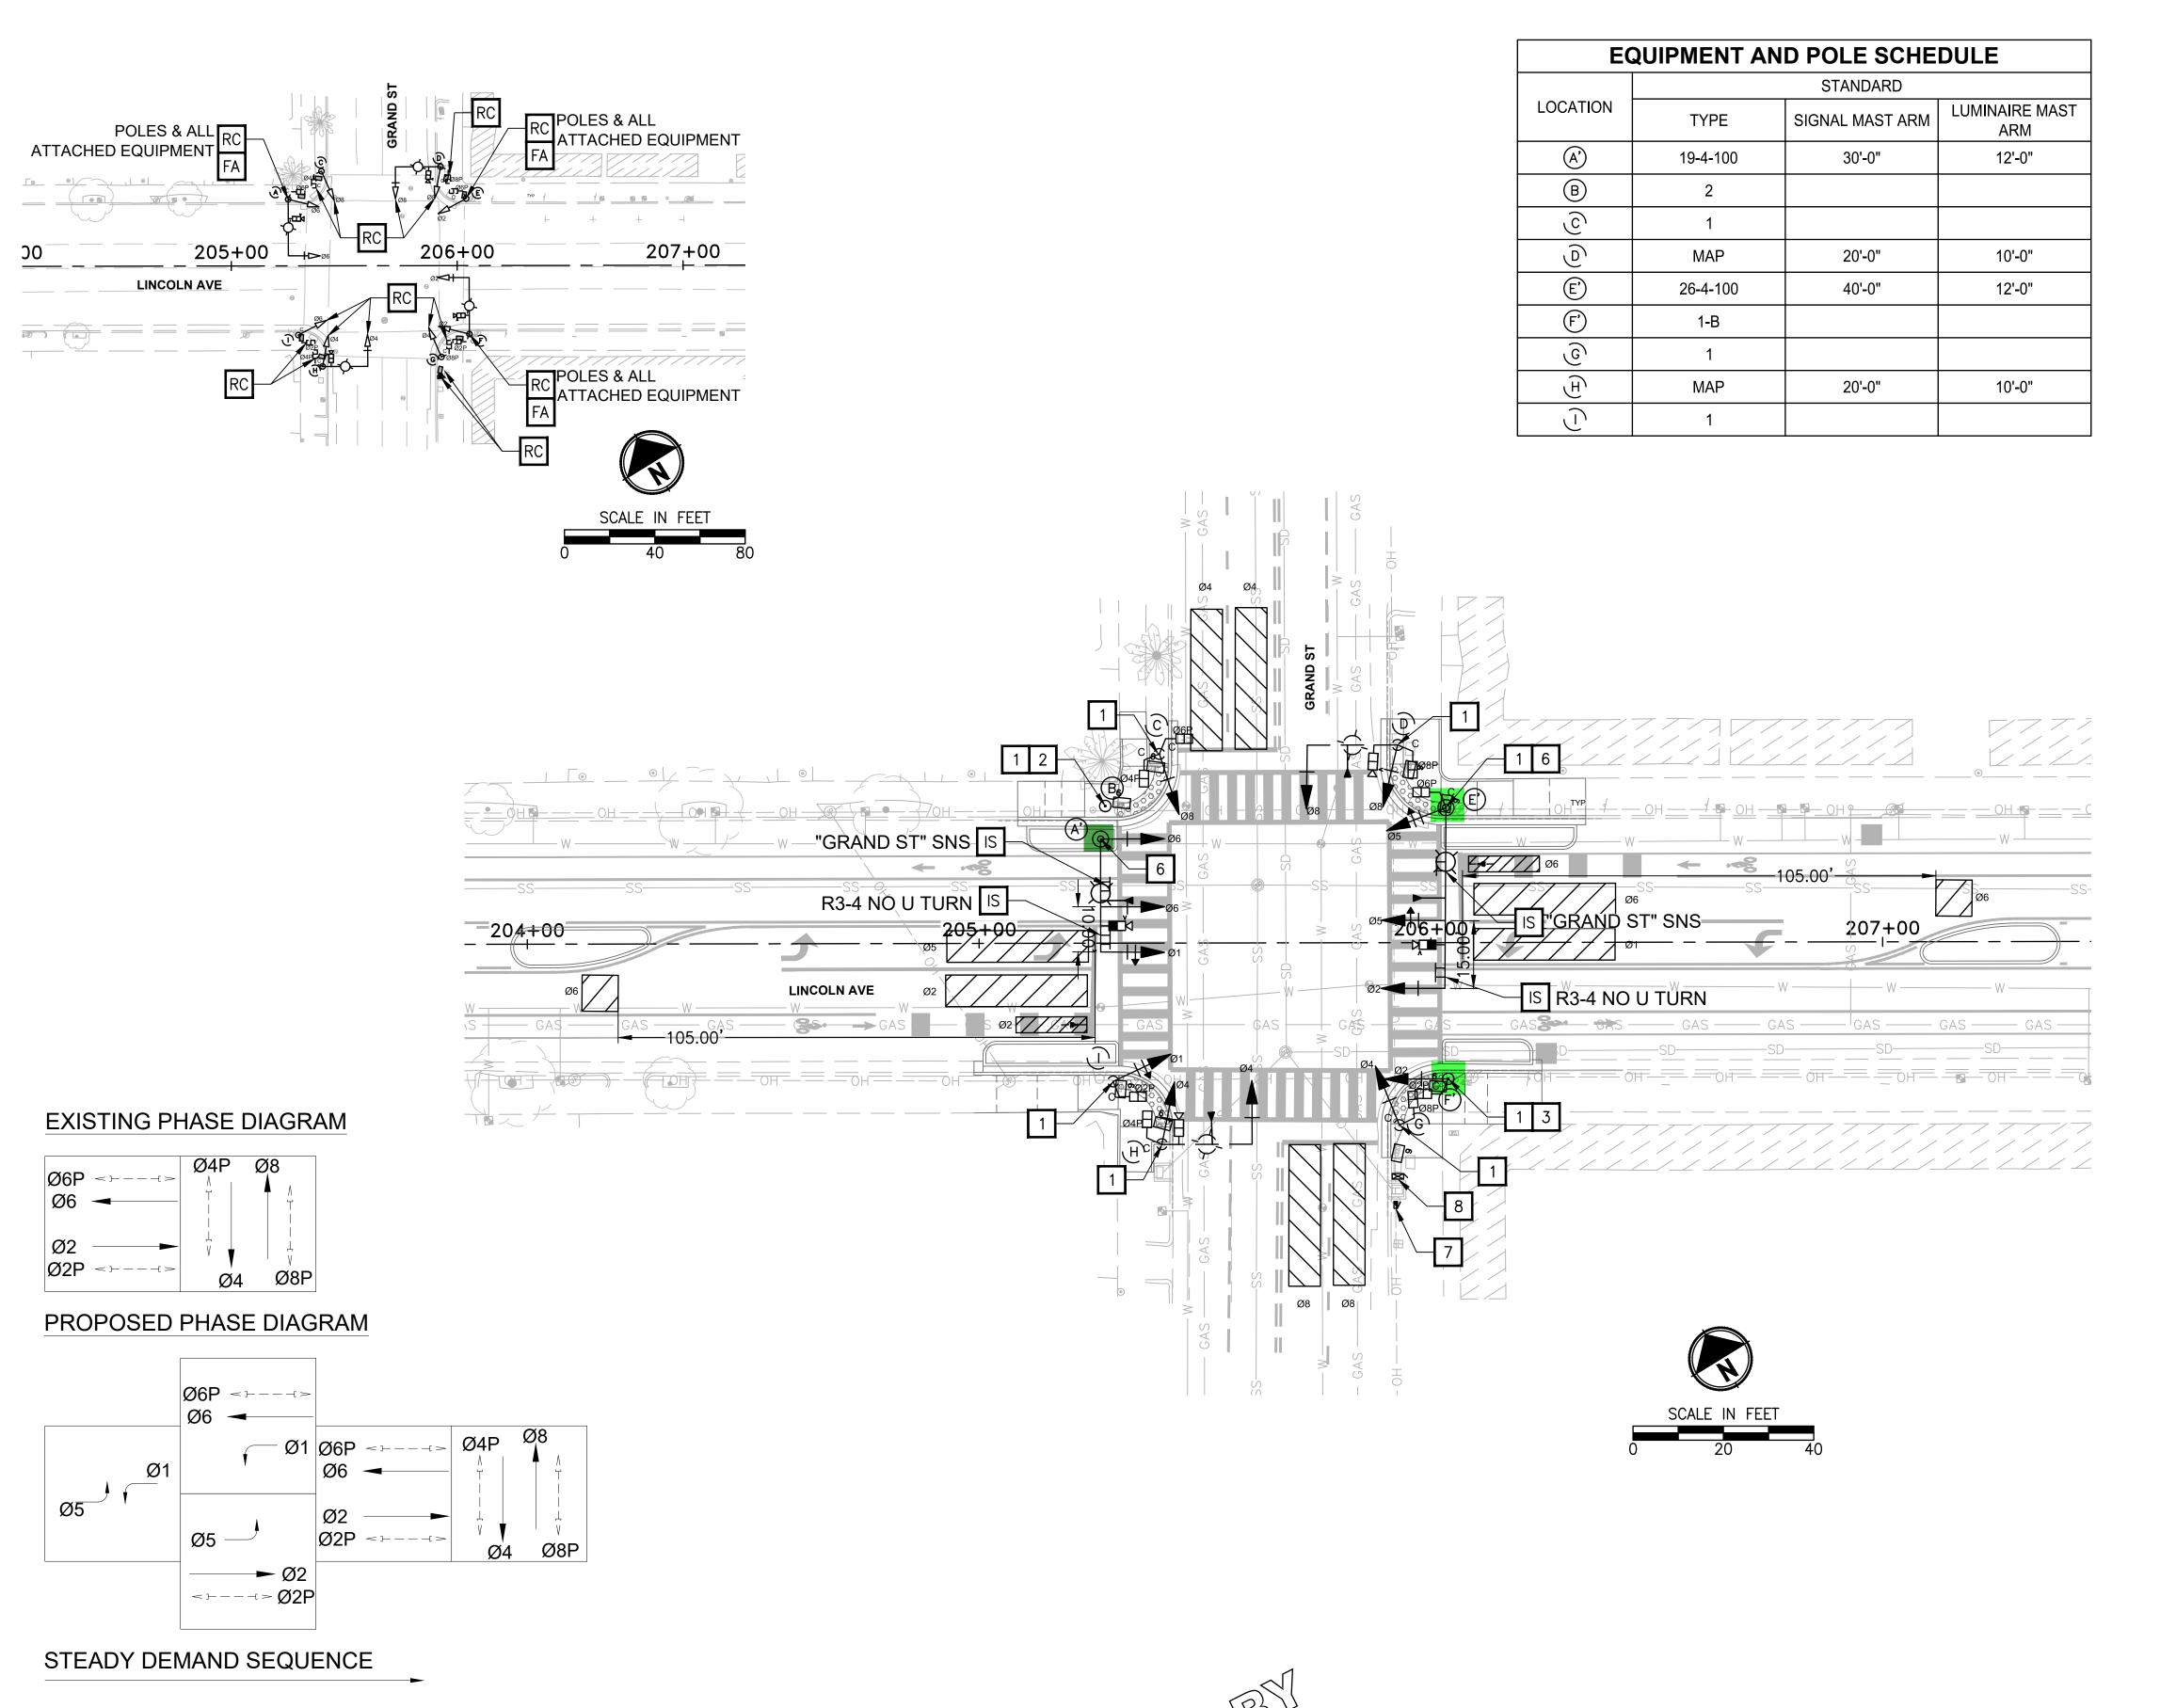
PROJECT NAME

CITY OF ALAMEDA CORRIDOR SAFETY IMPROVEMENT PROJECT LINCOLN AVE | MARSHALL WAY | PACIFIC AVE

65 % REVIEW SUBMITTAL NOT FOR CONSTRUCTION

**ELECTRICAL PLAN** 

DRAWING NO. 219 OF 262



## **GENERAL NOTES (THIS SHEET ONLY)**

- 1. PROTECT IN PLACE EXISTING CONDUIT AND CONDUCTORS DURING INSTALLATION OF NEW TRAFFIC SIGNALS
- 2. INSTALL 2" REFLECTIVE TAPE ON ALL TRAFFIC SIGNAL HEAD **BACKPLATES**
- 3. APS TO BE INSTALLED <10" FROM ADA TRAVEL WAY AND 42-48" ABOVE FINAL GRADE
- LOCATIONS OF NEW POLES AND CABINETS ARE SCHEMATIC AND SHALL BE CONFIRMED BY THE ENGINEER AND POTHOLED BY THE CONTRACTOR PRIOR TO DEMOLITION AND CONSTRUCTION
- 5. CONTRACTOR SHALL CONFIGURE THE VIDEO DETECTION ZONE. FINAL SIZE AND LOCATION TO BE DETERMINED BY THE ENGINEER

## **LEGEND & ABBREVIATIONS**

TRAFFIC SIGNAL HEAD PEDESTRIAN SIGNAL HEAD

VIDEO DETECTION CAMERA

VIDEO DETECTION ZONE

LUMINAIRE

LUMINAIRE ON MAST ARM

EMERGENCY VEHICLE PREEMPTIONS (EVP)

SIGN ON POLE

SIGN ON MAST ARM

POLE

**PULLBOX** 

CONTROLLER CABINET

SERVICE CABINET

## **CONSTRUCTION NOTES (THIS SHEET ONLY)**

- FA ABANDON FOUNDATION (REMOVE TO 1' BELOW FINISHED GRADE)
- EQUIPMENT TO BE REMOVED AND BECOME PROPERTY OF THE
- CONTRACTOR INSTALL NEW APS. SEE EQUIPMENT SCHEDULE FOR APS LOCATION
- DETAILS. SEE SHEET ED-1 FOR DETAILS.
- 2 INSTALL NEW TYPE 2 PEDESTRIAN PUSH BUTTON POST AND FOUNDATION WITH R10-3r(L OR R) PER SCHEDULE.
- 3 INSTALL NEW TYPE 1-B POLE AND FOUNDATION PER SCHEDULE.
- 6 INSTALL NEW SIGNAL MAST ARM POLE PER SCHEDULE
- 7 FURNISH AND INSTALL NEW TYPE III-AF SERVICE CABINET AND FOUNDATION
- INSTALL NEW ECONOLITE P-44 TS2 CABINET, ECONOLITE COBALT CONTROLLERS (SHELF MOUNT FOR THE P-44 CABINETS), BATTERY BACKUP SYSTEM, AND FOUNDATION
- IS INSTALL SIGN ON SIGNAL MAST ARM

**65 % REVIEW SUBMITTAL** 

NOT FOR CONSTRUCTION

220 OF 262

**ELECTRICAL PLAN** 

DESIGNED BA DATE DRAWN

REVISIONS

ONE INCH AT FULL SCALE. IF NOT, SCALE ACCORDINGLY

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**CITY OF ALAMEDA** CORRIDOR SAFETY IMPROVEMENT PROJECT LINCOLN AVE | MARSHALL WAY | PACIFIC AVE

PROJECT NAME

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DRAWING NO.

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LOCATION		STANDARD		LED LUMINAIRE	VEHICLE MOUN		PEDESTRIAN SIGNAL		PEDESTRIAN AL (APS)	SPECIAL REQUIREMENTS
LOCATION	TYPE	SIGNAL MAST ARM	LUMINAIRE MAST ARM	WATTAGE	MAST ARM	POLE	MOUNTING	PHASE	ARROW	OF EGIAL REQUIREMENTS
(A')	19-4-100	30'-0"	12'-0"		MAS MAS	SV-1-T				INSTALL VIDEO DETECTION CAMERA AND EVC ON SIGNAL MAST ARM. INSTALL "GRAND ST" STREET NAME SIGN. INSTALL NO U TURN SIGN.
В	2							TBD	TBD	
©	1					TV-1-T	SP-2-T	TBD	TBD	
9	MAP	20'-0"	10'-0"		MAS	SV-1-T	SP-1-T	TBD	TBD	INSTALL VIDEO DETECTION CAMERA ON LUMINAIRE MAST ARM
E'	26-4-100	40'-0"	12'-0"		MAS MAS	SV-1-T	SP-1-T	TBD	TBD	INSTALL VIDEO DETECTION CAMERA AND EVC ON SIGNAL MAST ARM. INSTALL "GRAND ST" STREET NAME SIGN. INSTALL NO U TURN SIGN.
F'	1-B					TV-1-T	SP-1-T	TBD	TBD	
<u></u>	1					TV-1-T	SP-1-T	TBD	TBD	
H	MAP	20'-0"	10'-0"		MAS	SV-1-T	SP-1-T	TBD	TBD	INSTALL VIDEO DETECTION CAMERA ON LUMINAIRE MAST ARM
	1					TV-1-T	SP-1-T	TBD	TBD	

- MAP EXISTING MAST ARM POLE
- SLP STREET LIGHT POLE
- ALL DIMENSIONS ARE APPROXIMATE
- ALL APS ARE NEW

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7 4	Δ	REVISIONS	DATE	BY	DESIGNED BA
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ONE INCH AT FULL SCALE.
IF NOT, SCALE ACCORDINGLY

FILE NAME
SF8939003C-EL

JOB No.
C65700

DATE
06/2025

E. PRELIMINATION .


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PROJECT NAME

CITY OF ALAMEDA CORRIDOR SAFETY IMPROVEMENT PROJECT LINCOLN AVE | MARSHALL WAY | PACIFIC AVE 65 % REVIEW SUBMITTAL NOT FOR CONSTRUCTION

ELECTRICAL PLAN

DRAWING NO. 221 OF 262

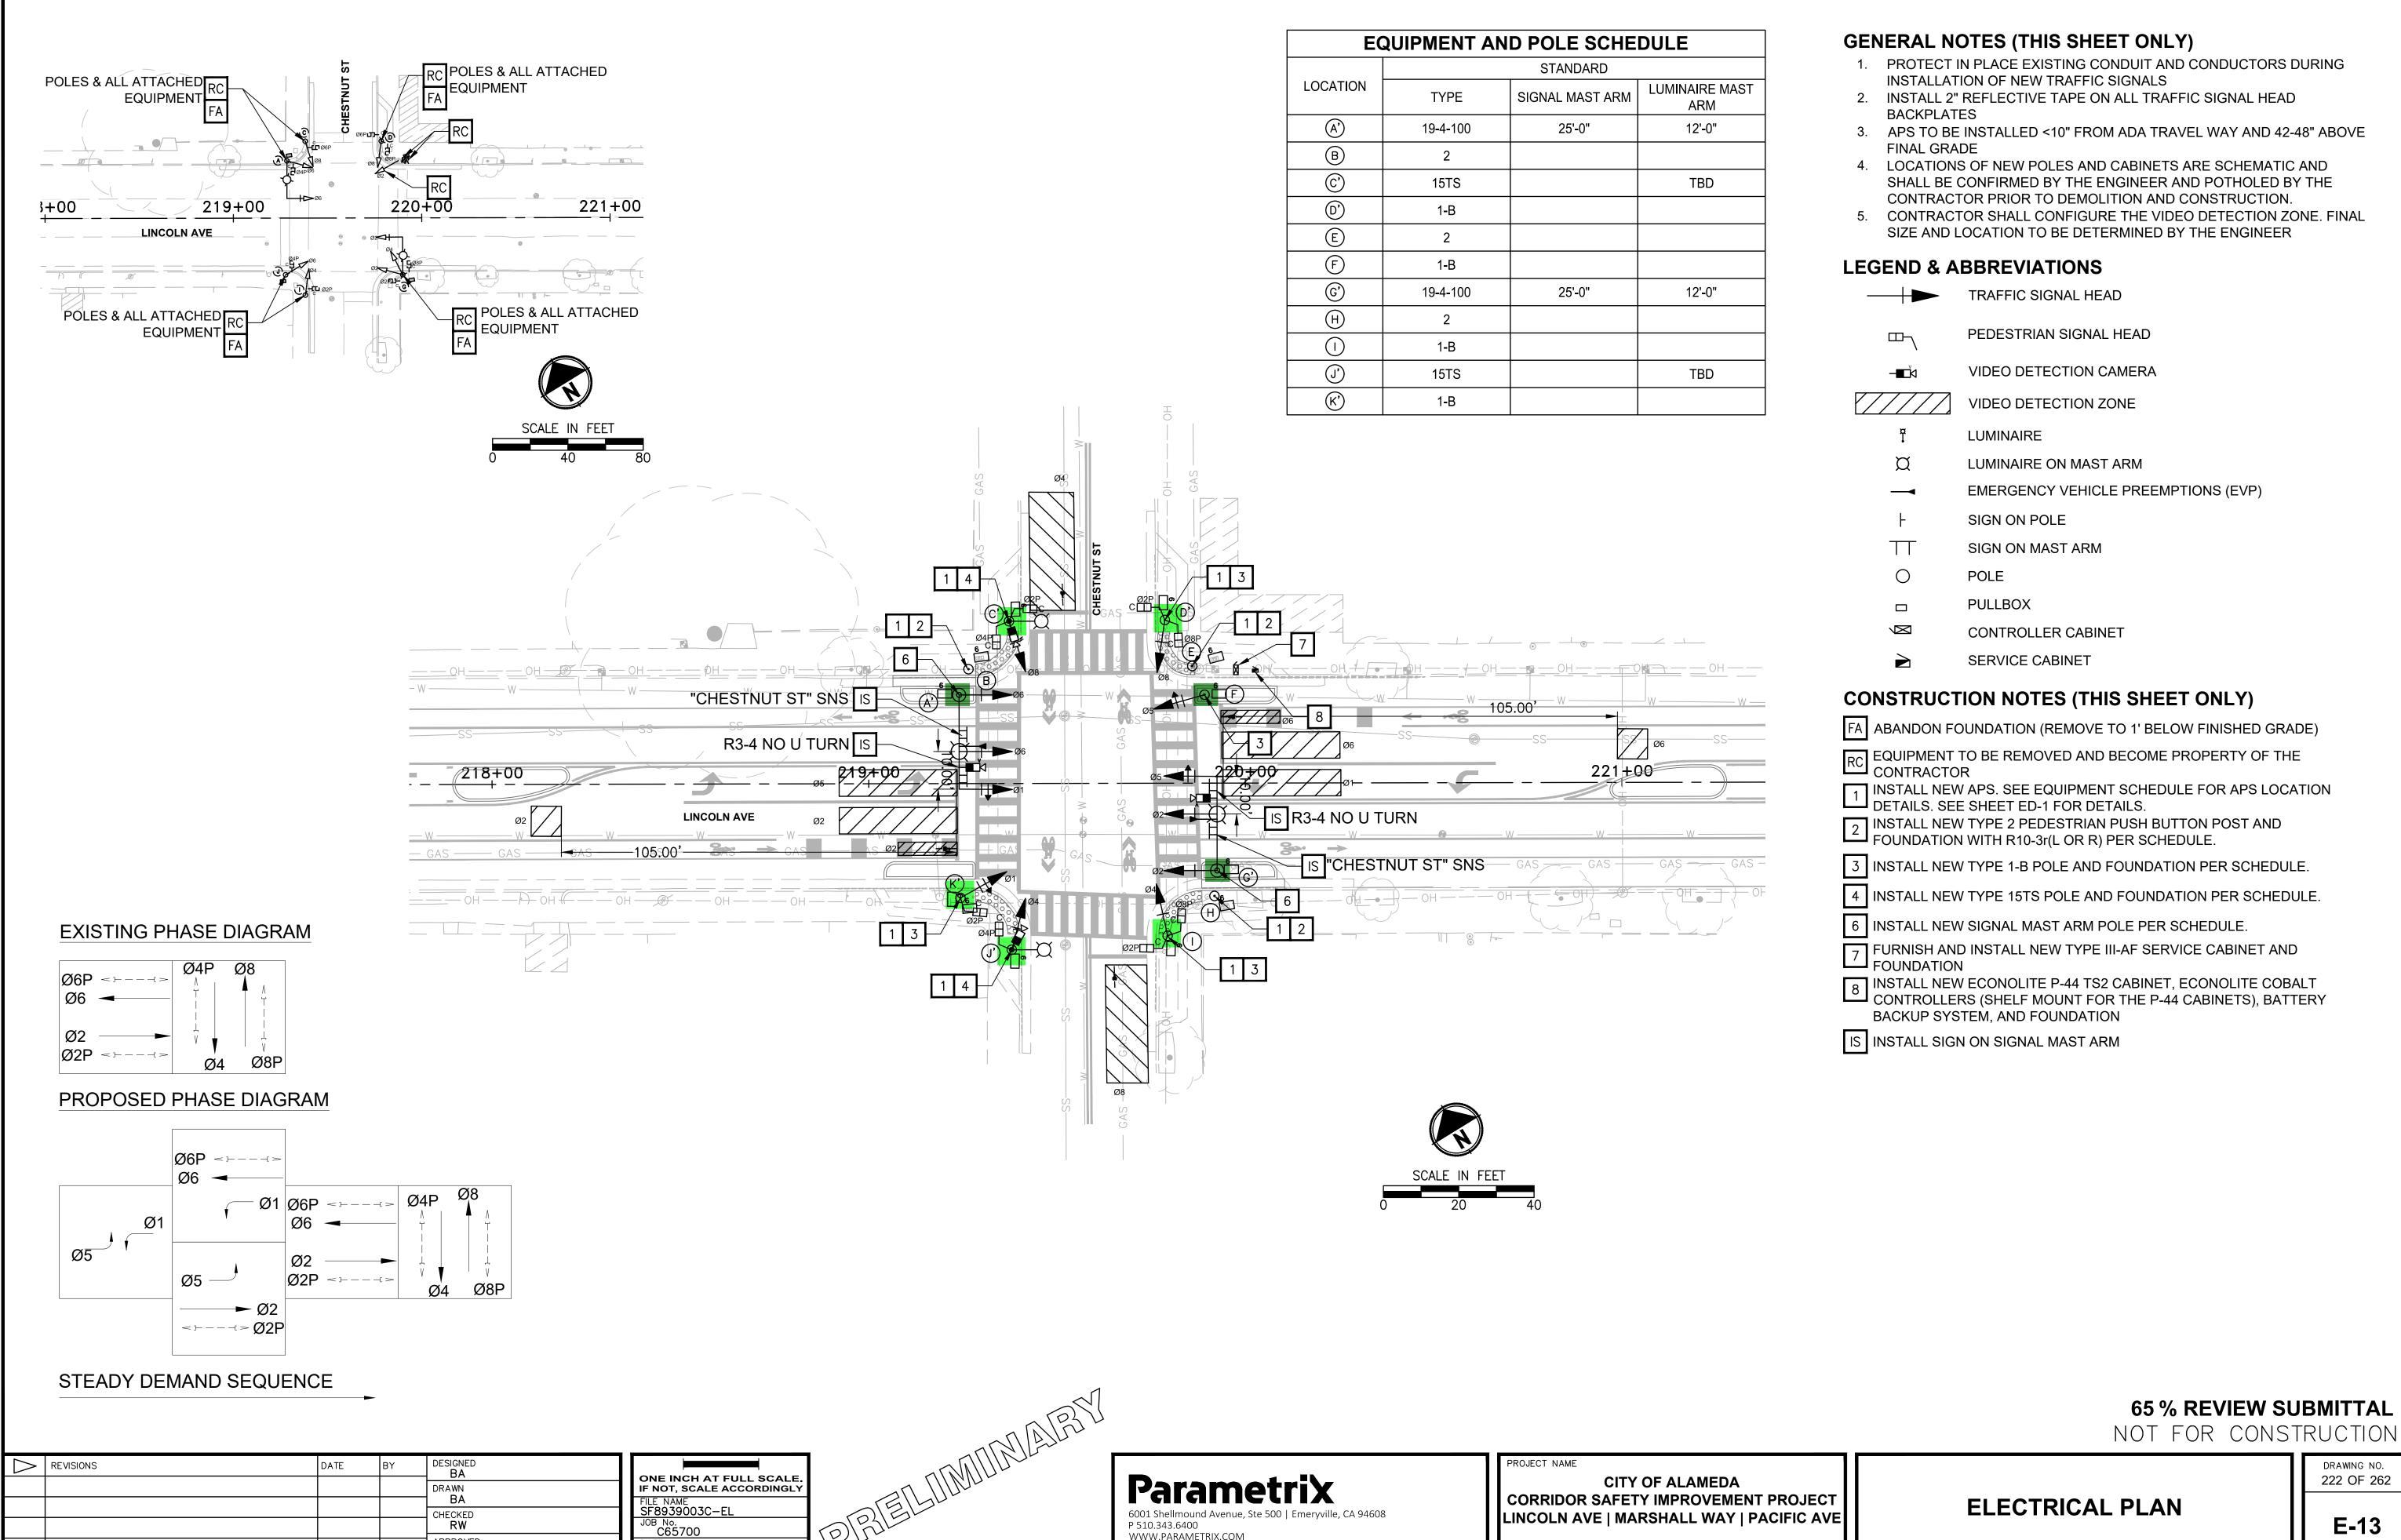

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CHECKED **RW** 

LINCOLN AVE | MARSHALL WAY | PACIFIC AVE

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LOCATION		STANDARD		LED LUMINAIRE	VEHICLE MOUN		PEDESTRIAN SIGNAL		PEDESTRIAN L (APS)	SPECIAL REQUIREMENTS
	TYPE	SIGNAL MAST ARM	LUMINAIRE MAST ARM	WATTAGE	MAST ARM	POLE	MOUNTING	PHASE	ARROW	
(A')	19-4-100	25'-0"	12'-0"	TBD	MAS MAS	SV-1-T				INSTALL VIDEO DETECTION CAMERA AND EVP ON SIGNAL MAST ARM. INSTALL "CHESTNUT ST" STREET NAME SIGN. IN STALL NO U TURN SIGN.
B	2							TBD	TBD	
©	15TS		TBD	TBD		SV-1-T	SP-2-T	TBD	TBD	INSTALL VIDEO DETECTION CAMERA ON POLE
(b)	1-B					TV-1-T	SP-2-T	TBD	TBD	
E	2							TBD	TBD	
F	1-B					TV-1-T				
<u>©'</u>	19-4-100	25'-0"	12'-0"	TBD	MAS MAS	SV-1-T				INSTALL VIDEO DETECTION CAMERA AND EVP ON SIGNAL MAST ARM. INSTALL "CHESTNUT ST" STREET NAME SIGN. IN STALL NO U TURN SIGN.
H	2							TBD	TBD	
	1-B					TV-1-T	SP-2-T	TBD	TBD	
(j)	15TS		TBD	TBD		SV-1-T	SP-1-T	TBD	TBD	INSTALL VIDEO DETECTION CAMERA ON POLE
(K)	1-B					TV-1-T	SP-1-T	TBD	TBD	

- MAP EXISTING MAST ARM POLE
- SLP STREET LIGHT POLE
- ALL DIMENSIONS ARE APPROXIMATE
- ALL APS ARE NEW

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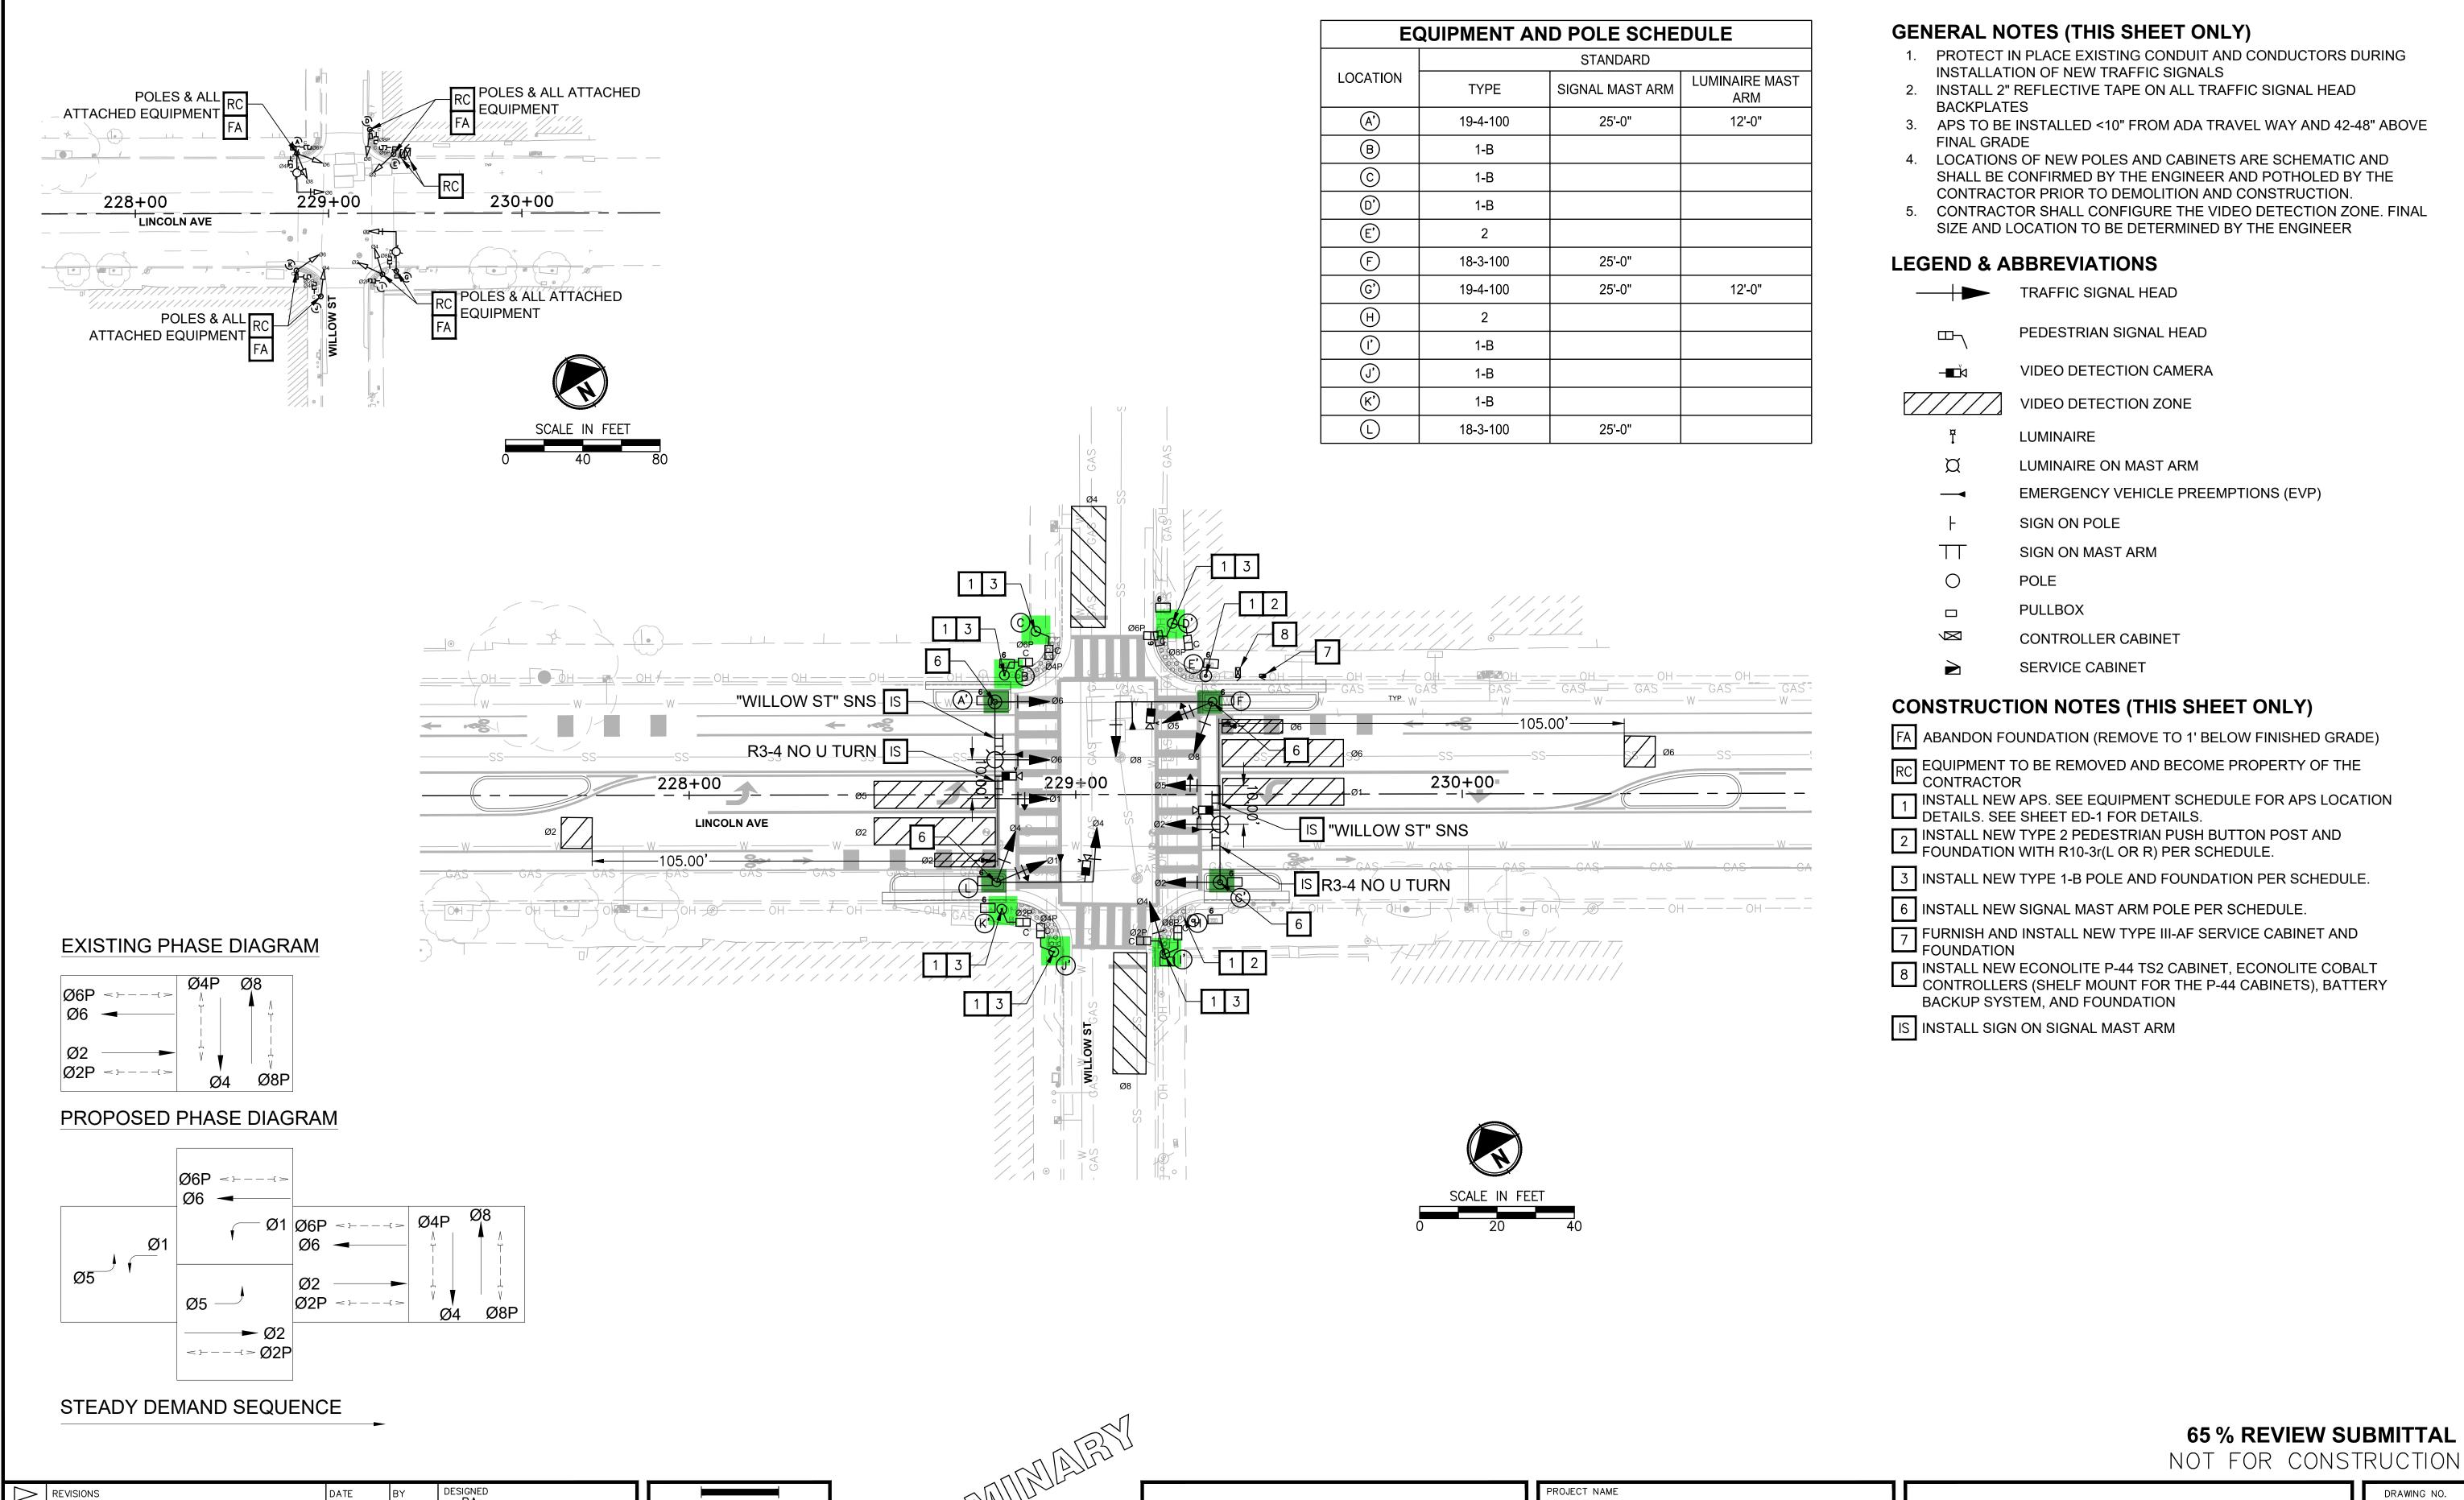
PROJECT NAME

CITY OF ALAMEDA CORRIDOR SAFETY IMPROVEMENT PROJECT LINCOLN AVE | MARSHALL WAY | PACIFIC AVE

65 % REVIEW SUBMITTAL NOT FOR CONSTRUCTION

**ELECTRICAL PLAN** 

DRAWING NO. 223 OF 262



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FILE NAME SF8939003C-EL JOB No. C65700

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**ELECTRICAL PLAN** 

**CITY OF ALAMEDA** 

CORRIDOR SAFETY IMPROVEMENT PROJECT

LINCOLN AVE | MARSHALL WAY | PACIFIC AVE

DRAWING NO.
224 OF 262

AWG OR CABLE	COND. DESIGN.					NUN	MBER OF (	CONDUCTO	ORS				
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				EQUIPN	IENT AND	POLE S	CHEDULE			
LOCATION		STANDARD		LED LUMINAIRE	VEHICLE SIGNAL MOUNTING		PEDESTRIAN SIGNAL		E PEDESTRIAN AL (APS)	SPECIAL REQUIREMENTS
	TYPE	SIGNAL MAST ARM	LUMINAIRE MAST ARM	WATTAGE	MAST ARM	POLE	MOUNTING	PHASE	ARROW	
(A')	19-4-100	25'-0"	12'-0"	TBD	MAS MAS	SV-1-T				INSTALL VIDEO DETECTION CAMERA AND EVP ON SIGNAL MAST ARM. INSTALL "WILLOW ST" STREET NAME SIGN. INSTALL NO U TURN SIGN.
В	1-B						SP-1-T	TBD	TBD	
©	1-B						SP-1-T	TBD	TBD	
(D)	1-B						SP-1-T	TBD	TBD	
E')	2							TBD	TBD	
F	18-3-100	25'-0"			MAS	SV-2-T				INSTALL VIDEO DETECTION CAMERA ON CAMERA POLE
<u>(G')</u>	19-4-100	25'-0"	12'-0"	TBD	MAS MAS	SV-1-T				INSTALL VIDEO DETECTION CAMERA AND EVP ON SIGNAL MAST ARM. INSTALL "WILLOW ST" STREET NAME SIGN. INSTALL NO U TURN SIGN.
H	2							TBD	TBD	
(1)	1-B					TV-1-T		TBD	TBD	
J')	1-B						SP-1-T	TBD	TBD	
(K)	1-B						SP-1-T	TBD	TBD	
L	18-3-100	25'-0"			MAS	SV-2-T				INSTALL VIDEO DETECTION CAMERA ON CAMERA POLE

- MAP EXISTING MAST ARM POLE
- SLP STREET LIGHT POLE
- ALL DIMENSIONS ARE APPROXIMATE
- ALL APS ARE NEW

T A	$\triangle$	REVISIONS	DATE	BY	DESIGNED <b>BA</b>
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-A TU					APPROVED <b>DP</b>

ONE INCH AT FULL SCALE.
IF NOT, SCALE ACCORDINGLY

FILE NAME
SF8939003C-EL

JOB No.
C65700

DATE
06/2025

E. PRELIMINATION


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P 510.343.6400
WWW.PARAMETRIX.COM

PROJECT NAME

CITY OF ALAMEDA CORRIDOR SAFETY IMPROVEMENT PROJECT LINCOLN AVE | MARSHALL WAY | PACIFIC AVE 65 % REVIEW SUBMITTAL NOT FOR CONSTRUCTION

**ELECTRICAL PLAN** 

DRAWING NO. 225 OF 262

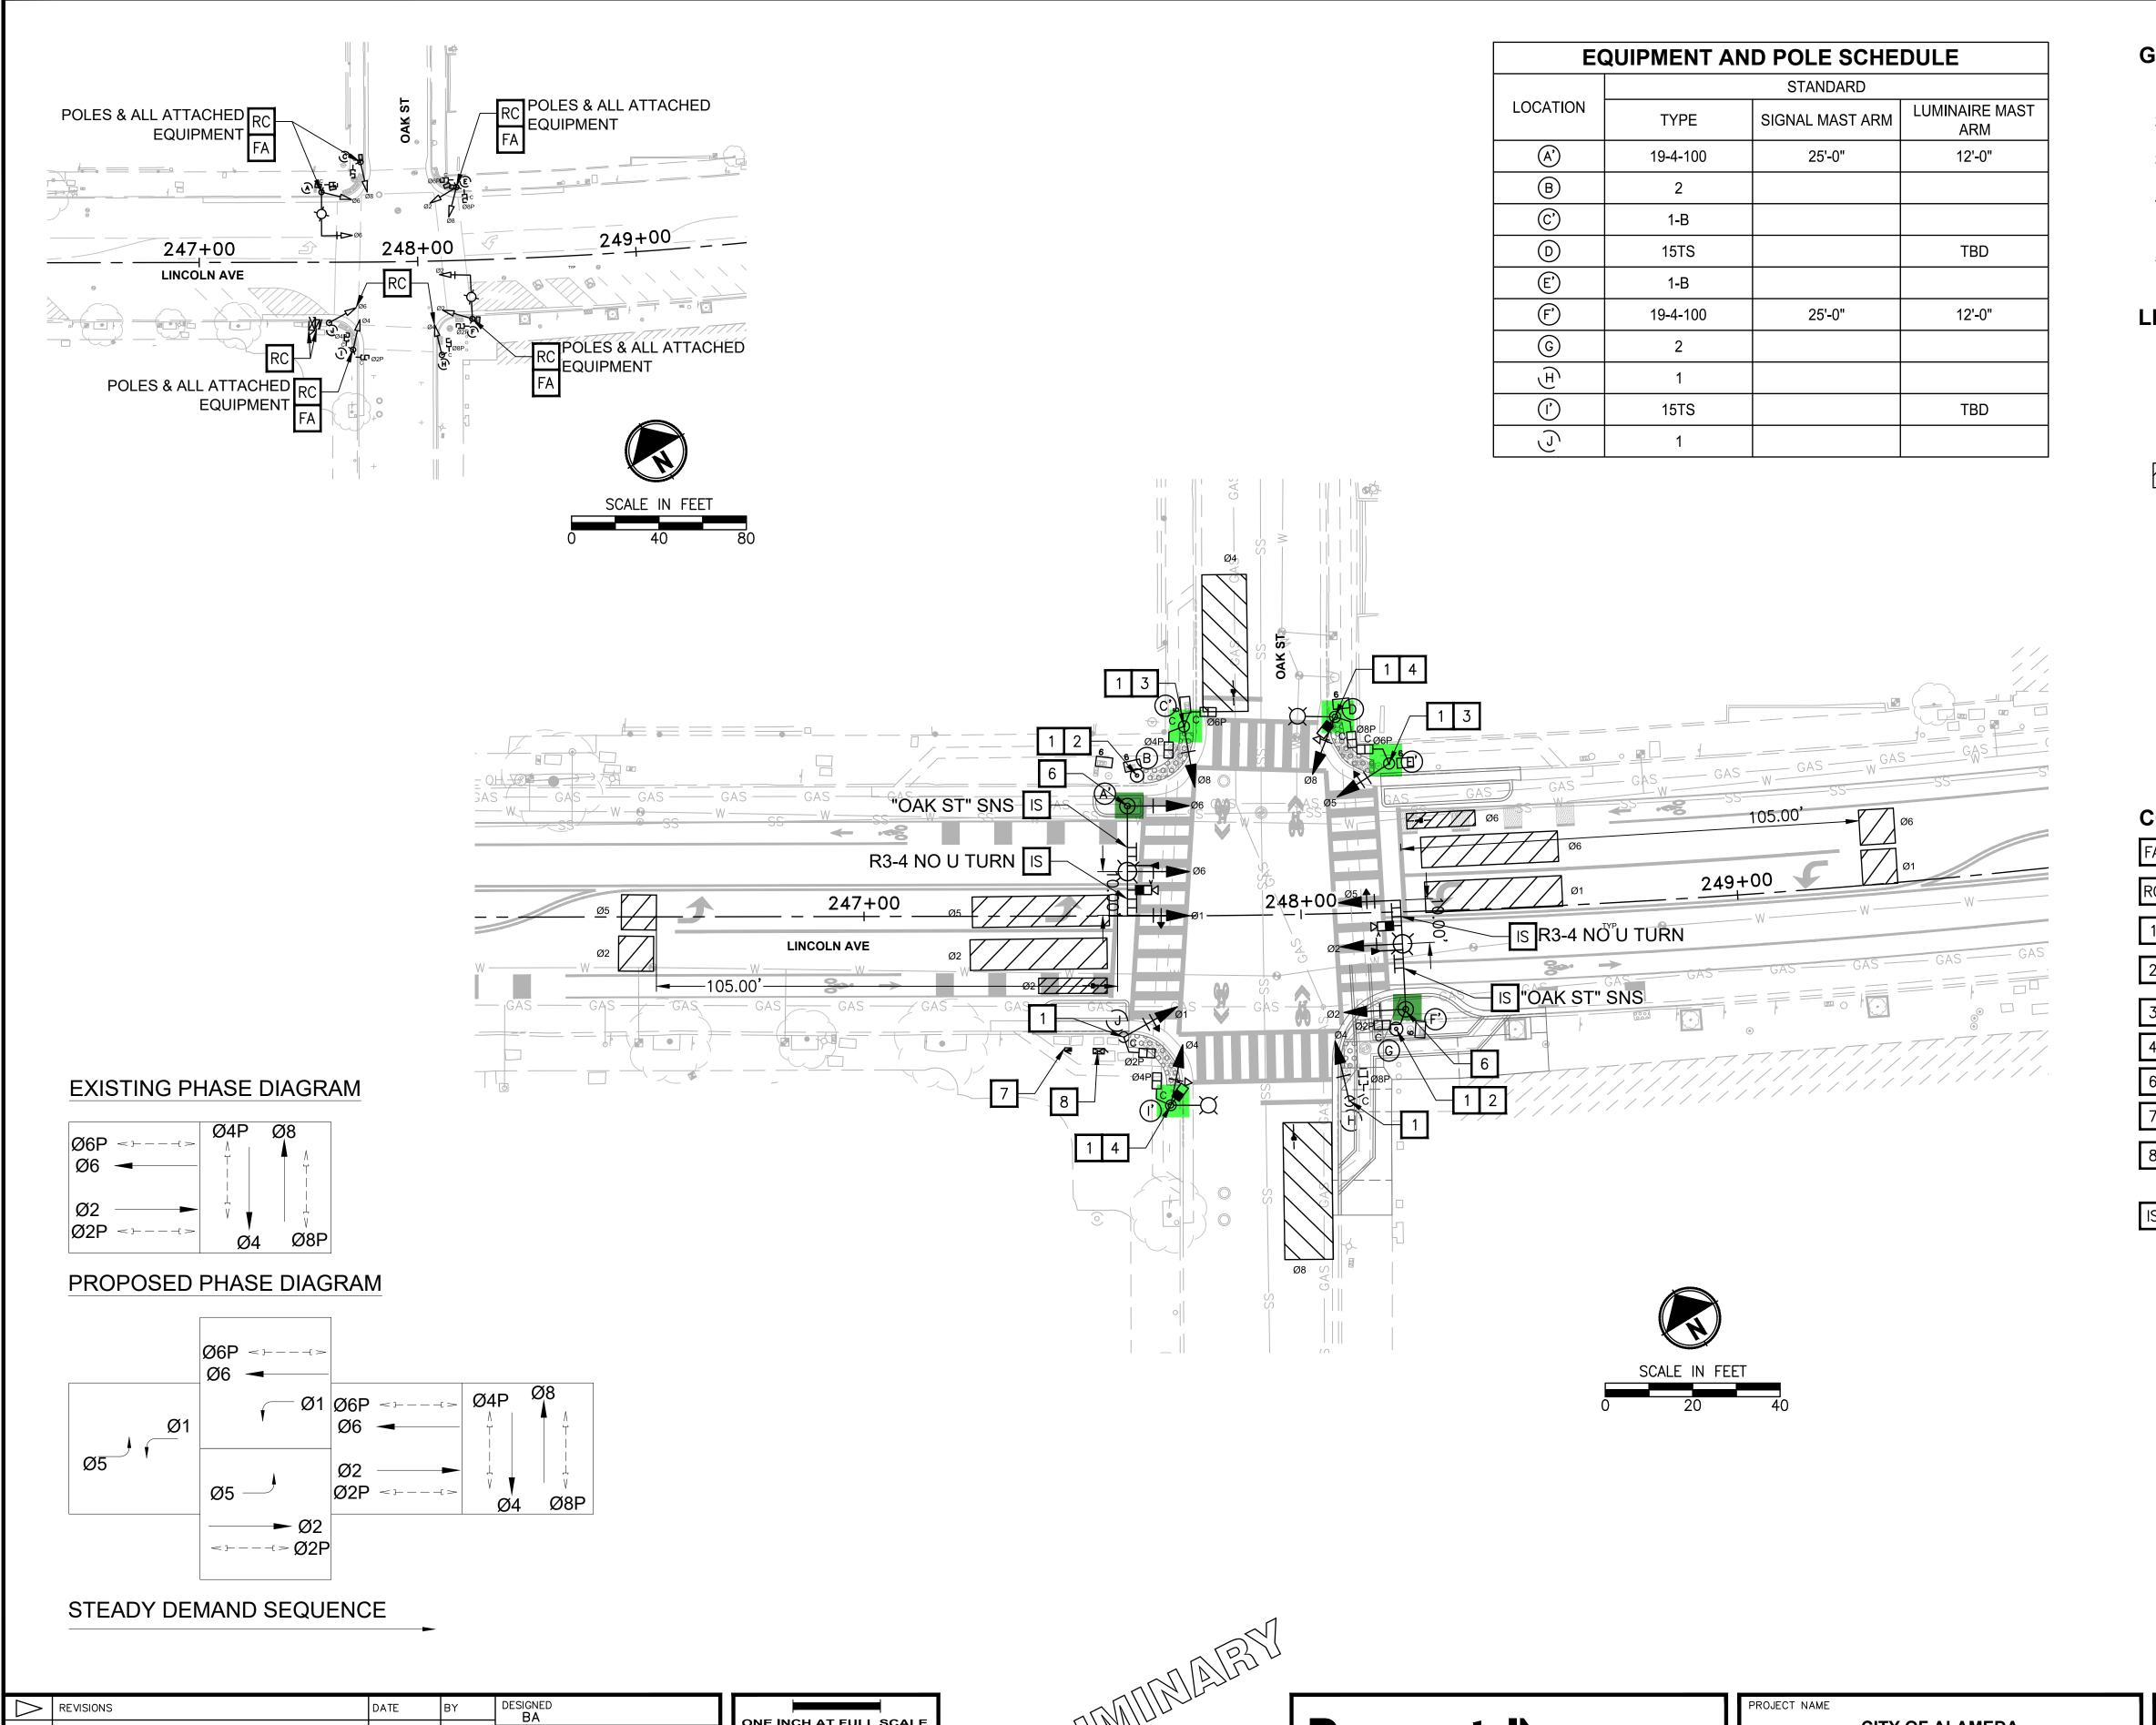

- 1. PROTECT IN PLACE EXISTING CONDUIT AND CONDUCTORS DURING INSTALLATION OF NEW TRAFFIC SIGNALS
- 2. INSTALL 2" REFLECTIVE TAPE ON ALL TRAFFIC SIGNAL HEAD BACKPLATES
- 3. APS TO BE INSTALLED <10" FROM ADA TRAVEL WAY AND 42-48" ABOVE FINAL GRADE
- LOCATIONS OF NEW POLES AND CABINETS ARE SCHEMATIC AND SHALL BE CONFIRMED BY THE ENGINEER AND POTHOLED BY THE CONTRACTOR PRIOR TO DEMOLITION AND CONSTRUCTION
- 5. CONTRACTOR SHALL CONFIGURE THE VIDEO DETECTION ZONE. FINAL SIZE AND LOCATION TO BE DETERMINED BY THE ENGINEER

#### **LEGEND & ABBREVIATIONS**

TRAFFIC SIGNAL HEAD PEDESTRIAN SIGNAL HEAD VIDEO DETECTION CAMERA

VIDEO DETECTION ZONE

LUMINAIRE

LUMINAIRE ON MAST ARM

EMERGENCY VEHICLE PREEMPTIONS (EVP)

SIGN ON POLE

SIGN ON MAST ARM

POLE

**PULLBOX** 

CONTROLLER CABINET

SERVICE CABINET

## **CONSTRUCTION NOTES (THIS SHEET ONLY)**

- FA ABANDON FOUNDATION (REMOVE TO 1' BELOW FINISHED GRADE)
- EQUIPMENT TO BE REMOVED AND BECOME PROPERTY OF THE
- CONTRACTOR 1 INSTALL NEW APS. SEE EQUIPMENT SCHEDULE FOR APS LOCATION
- L DETAILS. SEE SHEET ED-1 FOR DETAILS. 2 INSTALL NEW TYPE 2 PEDESTRIAN PUSH BUTTON POST AND
- FOUNDATION WITH R10-3r(L OR R) PER SCHEDULE.
- 3 INSTALL NEW TYPE 1-B POLE AND FOUNDATION PER SCHEDULE.
- 4 INSTALL NEW TYPE 15TS POLE AND FOUNDATION PER SCHEDULE.
- 6 INSTALL NEW SIGNAL MAST ARM POLE PER SCHEDULE
- 7 FURNISH AND INSTALL NEW TYPE III-AF SERVICE CABINET AND FOUNDATION
- 8 INSTALL NEW ECONOLITE P-44 TS2 CABINET, ECONOLITE COBALT CONTROLLERS (SHELF MOUNT FOR THE P-44 CABINETS), BATTERY BACKUP SYSTEM, AND FOUNDATION
- IS INSTALL SIGN ON SIGNAL MAST ARM

**65 % REVIEW SUBMITTAL** 

NOT FOR CONSTRUCTION

DRAWING NO. 226 OF 262

**ELECTRICAL PLAN** 

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ONE INCH AT FULL SCALE. IF NOT, SCALE ACCORDINGLY

SF8939003C-EL JOB No. C65700

DRAWN

CHECKED **RW** 

APPROVED DP

**CITY OF ALAMEDA** CORRIDOR SAFETY IMPROVEMENT PROJECT LINCOLN AVE | MARSHALL WAY | PACIFIC AVE

				CON	IDUCT	OR SCI	HEDUL	.E						
AWG OR CABLE	COND. DESIGN.	NUMBER OF CONDUCTORS												
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#10	SIGNAL COMMON													
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				EQUIPM	ENT AND	POLE S	CHEDULE			
LOCATION -		STANDARD		LED LUMINAIRE	VEHICLE SIGNAL MOUNTING		PEDESTRIAN SIGNAL		DESTRIAN SIGNAL PS)	SPECIAL REQUIREMENTS
LOCATION	TYPE			POLE	MOUNTING	PHASE	ARROW	OF EOIAL NEGOTILIMENTO		
(A')	19-4-100	25'-0"	12'-0"	TBD	MAS MAS	SV-1-T				INSTALL VIDEO DETECTION CAMERA ON MAST ARM. INSTALL "OAK ST" STREET NAME SIGN AND EVP ON SIGNAL MAST ARM
B	2							TBD	TBD	
<u>©</u>	1-B					TV-1-T	SP-2-T	TBD	TBD	
(D)	15TS		TBD	TBD		SV-1-T	SP-1-T	TBD	I IBII	INSTALL VIDEO DETECTION CAMERA ON POLE.
Ê)	1-B					TV-1-T	SP-1-T	TBD	TBD	
<b>(F')</b>	19-4-100	25'-0"	12'-0"	TBD	MAS MAS	SV-1-T	SP-1-T			INSTALL VIDEO DETECTION CAMERA ON MAST ARM. INSTALL "OAK ST" STREET NAME SIGN AND EVP ON SIGNAL MAST ARM
G	2							TBD	TBD	
(H)	1					TV-1-T	SP-1-T	TBD	TBD	
(1)	15TS		TBD	TBD		SV-1-T	SP-1-T	TBD	I IRII	INSTALL VIDEO DETECTION CAMERA ON POLE.
(2)	1					TV-1-T	SP-1-T	TBD	TBD	

- MAP EXISTING MAST ARM POLE
- SLP STREET LIGHT POLE
- ALL DIMENSIONS ARE APPROXIMATE
- ALL APS ARE NEW

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-A 10					APPROVED <b>DP</b>

ONE INCH AT FULL SCALE.
IF NOT, SCALE ACCORDINGLY

FILE NAME
SF8939003C-EL

JOB No.
C65700

DATE
06/2025

E. PRELIMINATION .


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P 510.343.6400
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PROJECT NAME

CITY OF ALAMEDA CORRIDOR SAFETY IMPROVEMENT PROJECT LINCOLN AVE | MARSHALL WAY | PACIFIC AVE 65 % REVIEW SUBMITTAL NOT FOR CONSTRUCTION

ELECTRICAL PLAN

DRAWING NO. 227 OF 262

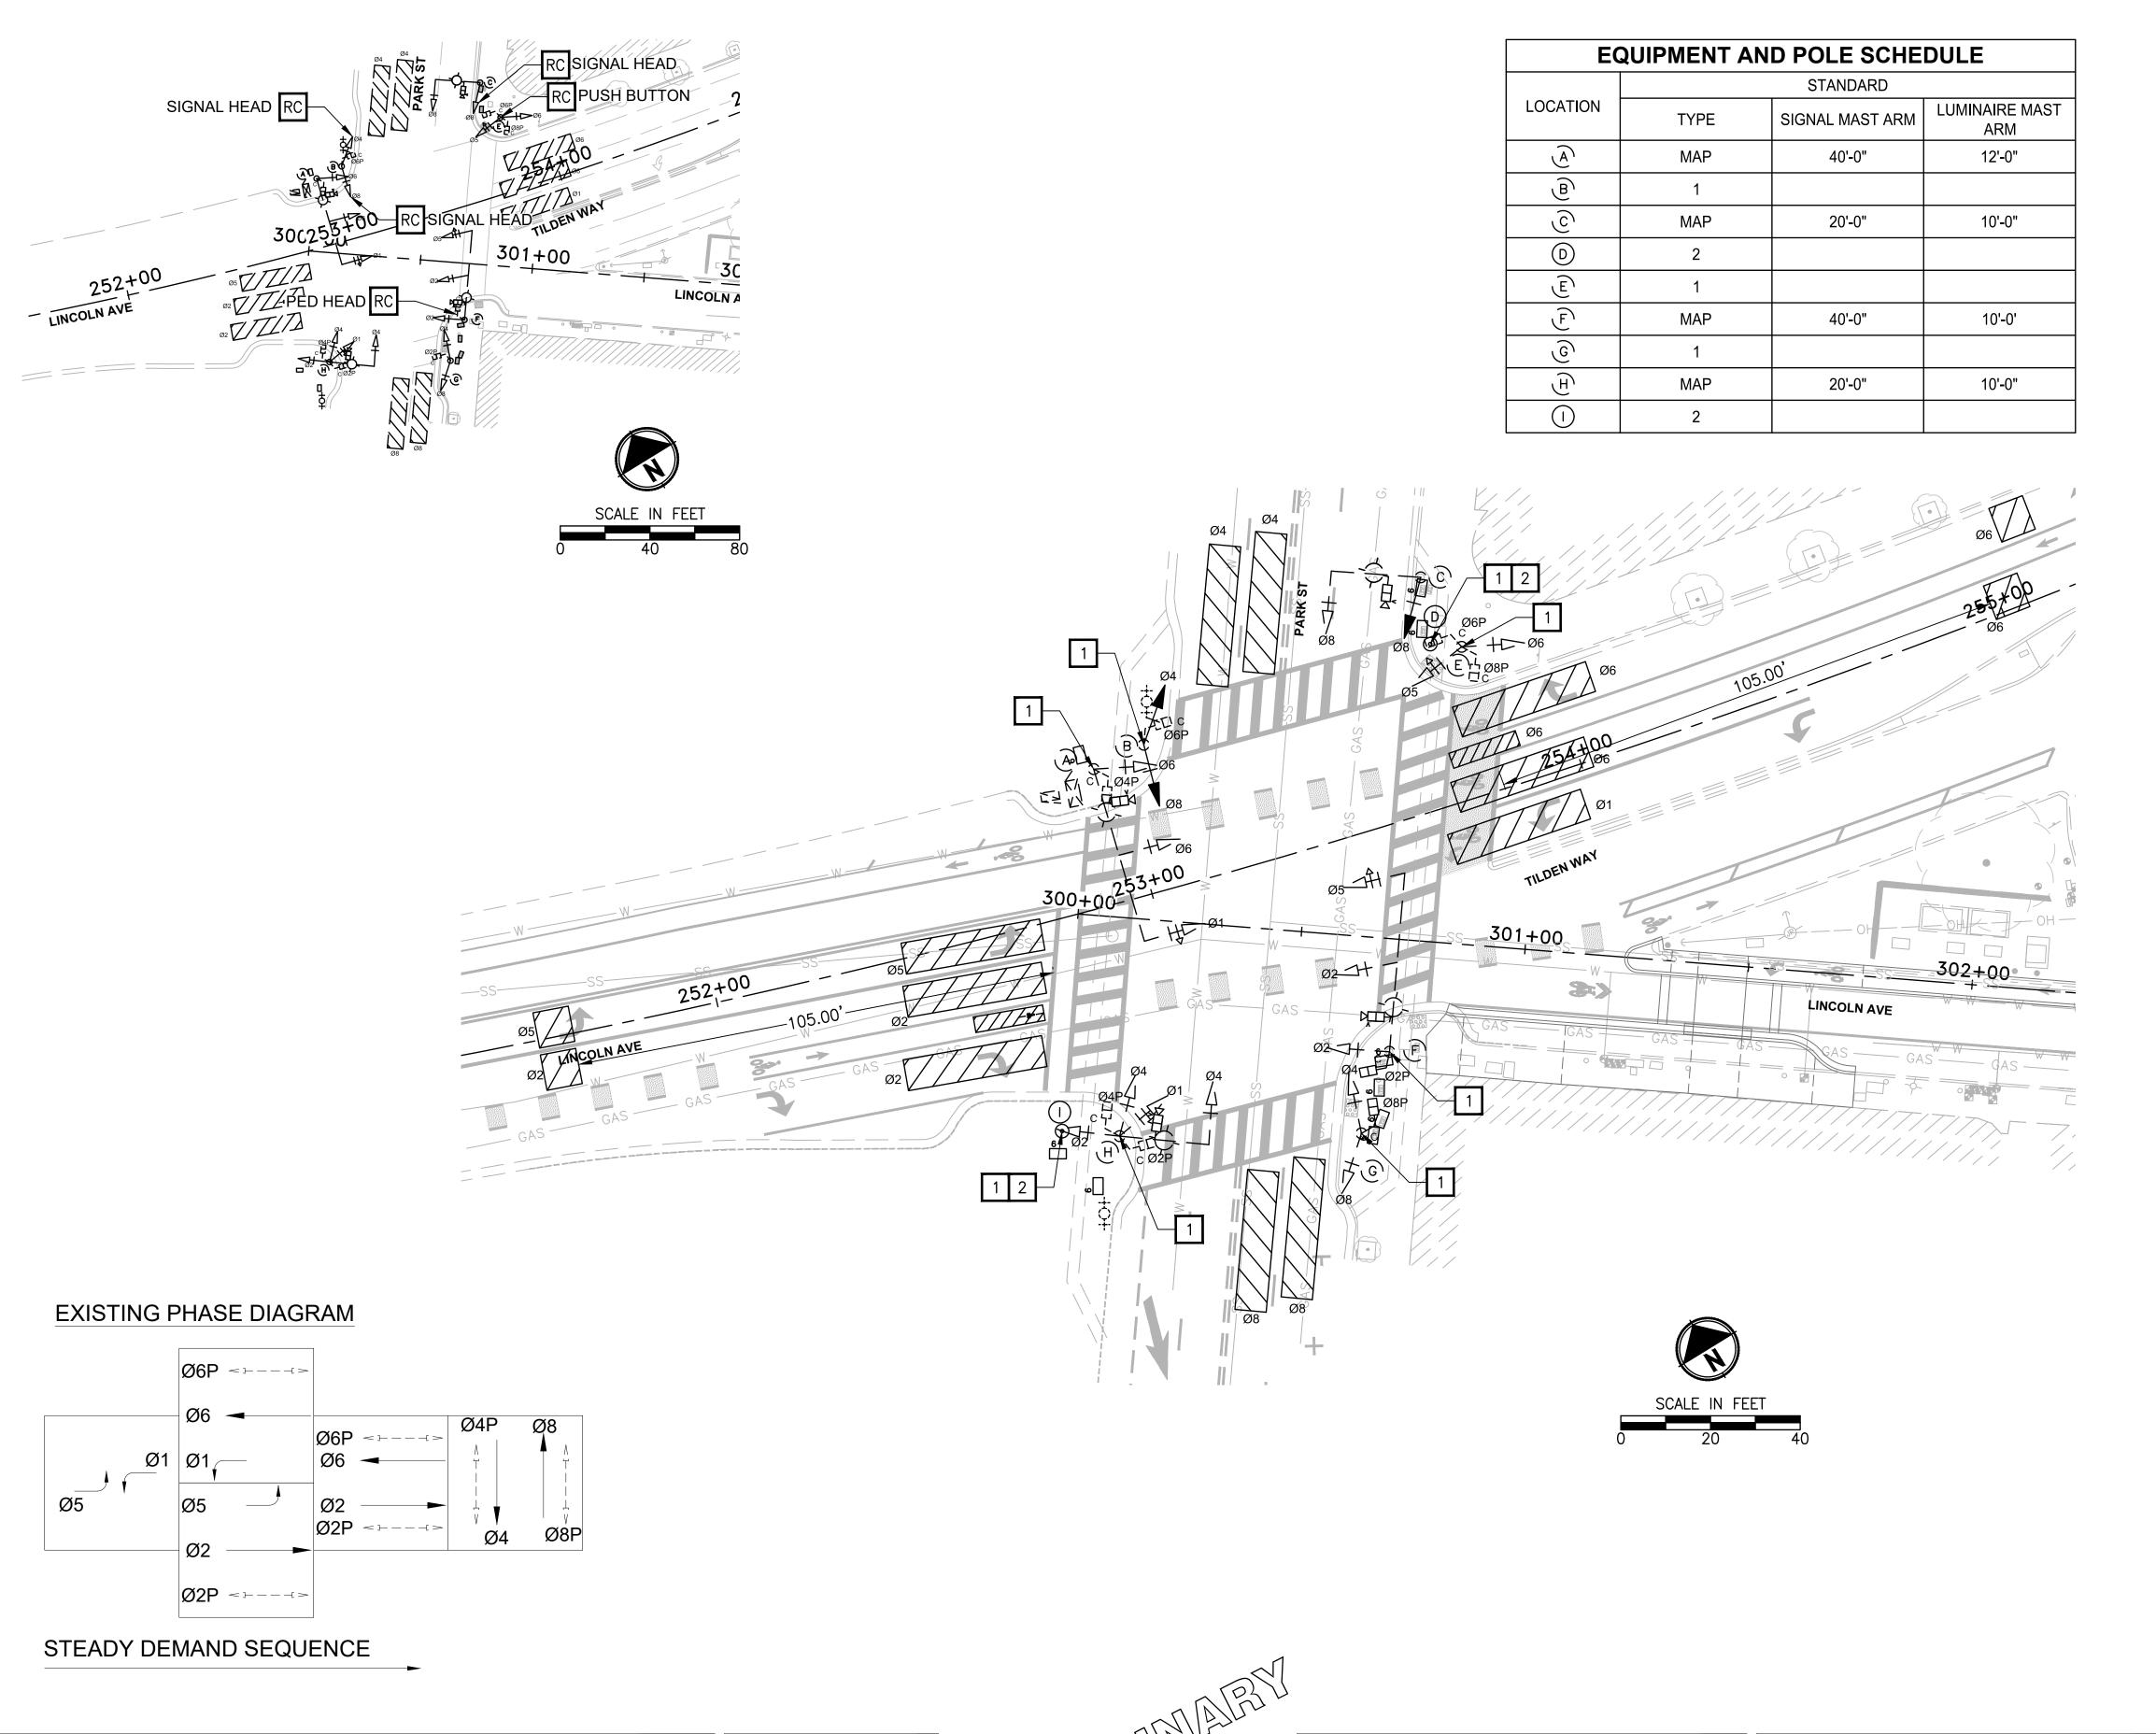

- 1. PROTECT IN PLACE EXISTING CONDUIT AND CONDUCTORS DURING INSTALLATION OF NEW TRAFFIC SIGNALS
- 2. INSTALL 2" REFLECTIVE TAPE ON ALL TRAFFIC SIGNAL HEAD BACKPLATES
- 3. APS TO BE INSTALLED <10" FROM ADA TRAVEL WAY AND 42-48" ABOVE FINAL GRADE
- 4. LOCATIONS OF NEW POLES AND CABINETS ARE SCHEMATIC AND SHALL BE CONFIRMED BY THE ENGINEER AND POTHOLED BY THE CONTRACTOR PRIOR TO DEMOLITION AND CONSTRUCTION.
- 5. CONTRACTOR SHALL CONFIGURE THE VIDEO DETECTION ZONE. FINAL SIZE AND LOCATION TO BE DETERMINED BY THE ENGINEER

#### **LEGEND & ABBREVIATIONS**

TRAFFIC SIGNAL HEAD PEDESTRIAN SIGNAL HEAD VIDEO DETECTION CAMERA

VIDEO DETECTION ZONE LUMINAIRE

LUMINAIRE ON MAST ARM

EMERGENCY VEHICLE PREEMPTIONS (EVP)

SIGN ON POLE

SIGN ON MAST ARM

POLE

PULLBOX

**CONTROLLER CABINET** 

SERVICE CABINET

### **CONSTRUCTION NOTES (THIS SHEET ONLY)**

- RC EQUIPMENT TO BE REMOVED AND BECOME PROPERTY OF THE CONTRACTOR
- INSTALL NEW APS. SEE EQUIPMENT SCHEDULE FOR APS LOCATION DETAILS. SEE SHEET ED-1 FOR DETAILS.
- INSTALL NEW TYPE 2 PEDESTRIAN PUSH BUTTON POST AND FOUNDATION WITH R10-3r(L OR R) PER SCHEDULE.

**65 % REVIEW SUBMITTAL** 

NOT FOR CONSTRUCTION

228 OF 262

E-19

**ELECTRICAL PLAN** 

REVISIONS

ONE INCH AT FULL SCALE. IF NOT, SCALE ACCORDINGLY

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PROJECT NAME

**CITY OF ALAMEDA** CORRIDOR SAFETY IMPROVEMENT PROJECT

LINCOLN AVE | MARSHALL WAY | PACIFIC AVE

				CON	DUCTO	OR SCI	HEDUL	.E						
AWG OR CABLE	COND. DESIGN.	NUMBER OF CONDUCTORS												
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	EQUIPMENT AND POLE SCHEDULE												
LOCATION		STANDARD		LED LUMINAIRE		VEHICLE SIGNAL MOUNTING		ACCESSIBLE PEDES	STRIAN SIGNAL (APS)	SPECIAL REQUIREMENTS			
	TYPE	SIGNAL MAST ARM	LUMINAIRE MAST ARM	WATTAGE	MAST ARM	POLE	MOUNTING	PHASE	ARROW				
Â	MAP	40'-0"	12'-0"	TBD	MAS MAS	SV-1-T	SP-1-T	TBD	TBD				
(B)	1					TV-2-T	SP-1-T	TBD	TBD				
(0)	MAP	20'-0"	10'-0"	TBD	MAS	SV-1-T							
Ф	2							TBD	TBD				
E	1					TV-2-T	SP-2-T	TBD	TBD				
F	MAP	40'-0"	10'-0'	TBD	MAS MAS	SV-1-T	SP-1-T	TBD	TBD				
(G)	1					TV-2-T	SP-1-T	TBD	TBD				
(F)	MAP	20'-0"	10'-0"	TBD	MAS	SV-3-TA	SP-2-T	TBD	TBD				
	2							TBD	TBD				

- MAP EXISTING MAST ARM POLE
- SLP STREET LIGHT POLE
- ALL DIMENSIONS ARE APPROXIMATE
- ALL APS ARE NEW

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Ž					APPROVED

ONE INCH AT FULL SCALE.
IF NOT, SCALE ACCORDINGLY

FILE NAME
SF8939003C-EL

JOB No.
C65700

DATE
06/2025

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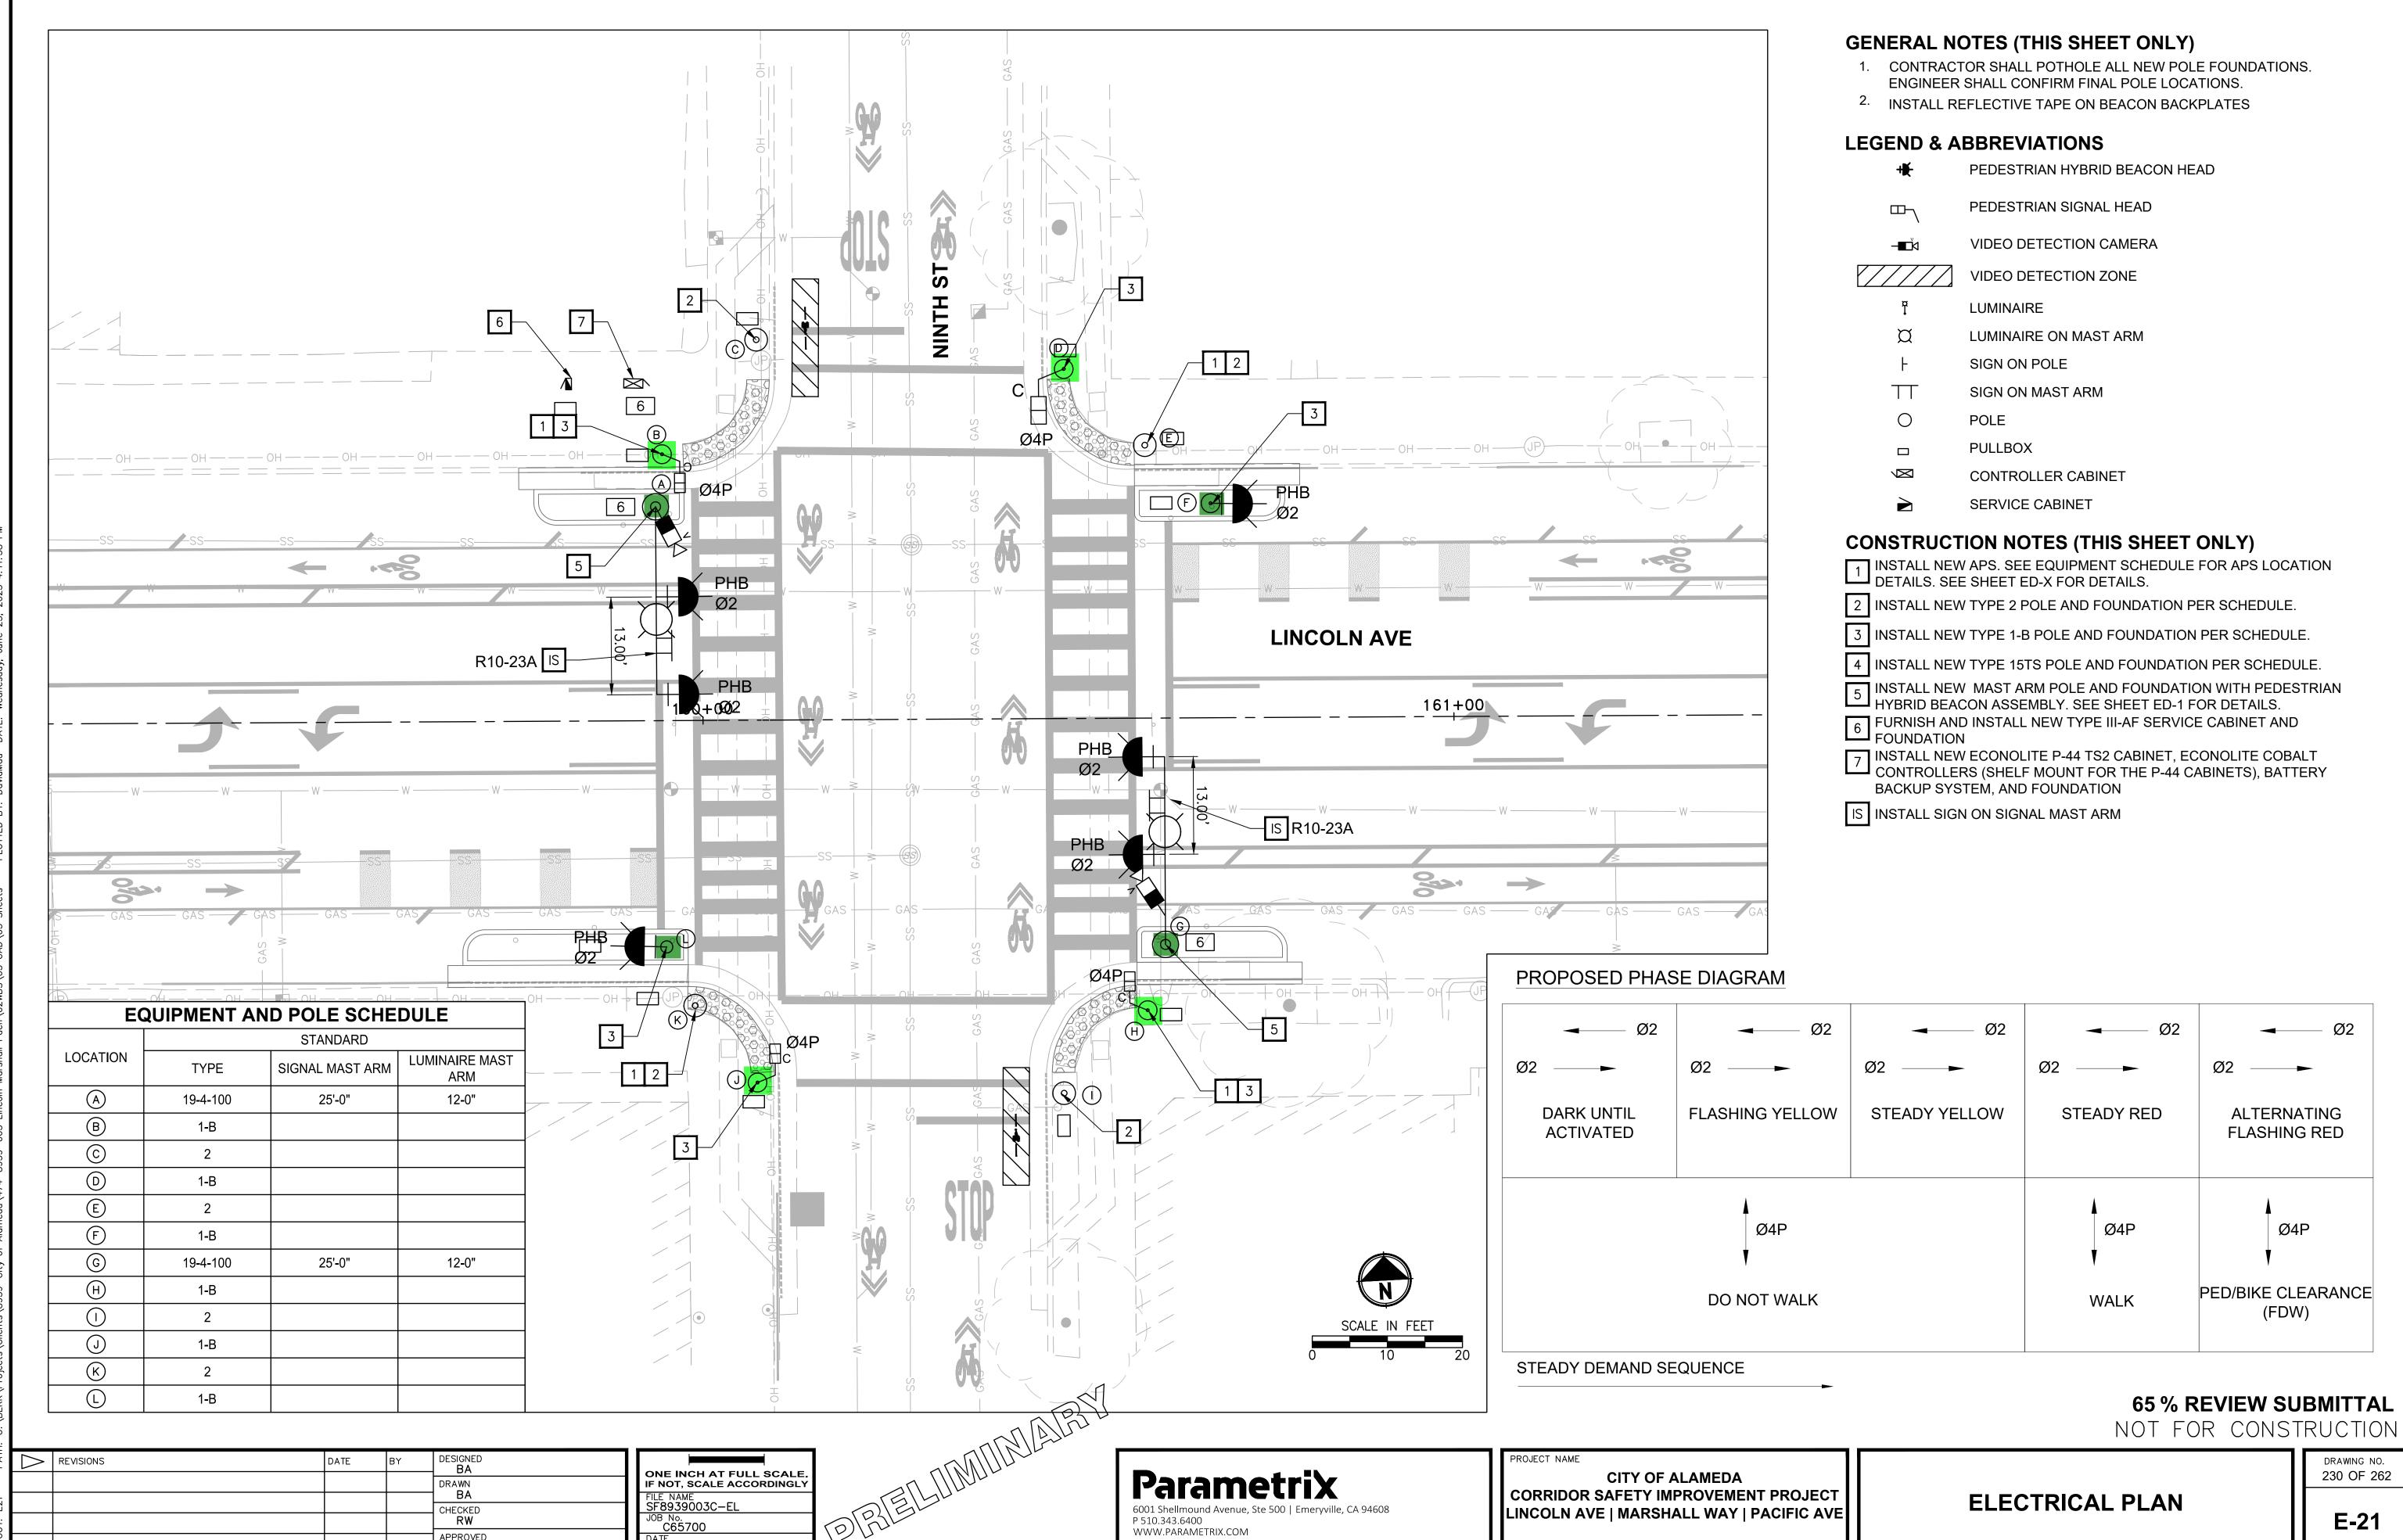
PROJECT NAME

CITY OF ALAMEDA CORRIDOR SAFETY IMPROVEMENT PROJECT LINCOLN AVE | MARSHALL WAY | PACIFIC AVE NOT FOR CONSTRUCTION

65 % REVIEW SUBMITTAL

**ELECTRICAL PLAN** 

DRAWING NO. 229 OF 262



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APPROVED **DP** 

DRAWING NO. 230 OF 262

				CON	IDUCT	OR SCI	HEDUL	.E						
AWG OR CABLE	COND. DESIGN.		NUMBER OF CONDUCTORS											
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	NDUIT SIZE													
PER	RCENT FILL													

EQUIPMENT AND POLE SCHEDULE											
LOCATION		STANDARD		LED LUMINAIRE WATTAGE	VEHICLE SIGNAL MOUNTING		PEDESTRIAN SIGNAL		PEDESTRIAN L (APS)	SPECIAL REQUIREMENTS	
	TYPE	SIGNAL MAST ARM	LUMINAIRE MAST ARM		MAST ARM	POLE	MOUNTING	PHASE	ARROW		
A	19-4-100	25'-0"	12-0"	TBD	MAS-3A MAS-3A						
В	1-B						SP-1-T	TBD	TBD		
©	2									ADD BICYCLE DETECTED WHEN ILLUMINATED SIGN	
D	1-B						SP-1-T				
E	2							TBD	TBD		
F	1-B					TV-1-T					
G	19-4-100	25'-0"	12-0"	TBD	MAS-3A MAS-3A						
Н	1-B						SP-1-T	TBD	TBD		
()	2									ADD BICYCLE DETECTED WHEN ILLUMINATED SIGN	
J	1-B						SP-1-T				
K	2							TBD	TBD		
L	1-B					TV-1-T					

- MAP EXISTING MAST ARM POLE
- SLP STREET LIGHT POLE
- ALL DIMENSIONS ARE APPROXIMATE
- ALL APS ARE NEW

PAT	REVISIONS	DATE	BY	DESIGNED BA
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YOU				APPROVED DP

ONE INCH AT FULL SCALE.
IF NOT, SCALE ACCORDINGLY

FILE NAME
SF8939003C-EL

JOB No.
C65700

DATE
06/2025

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PRETATION

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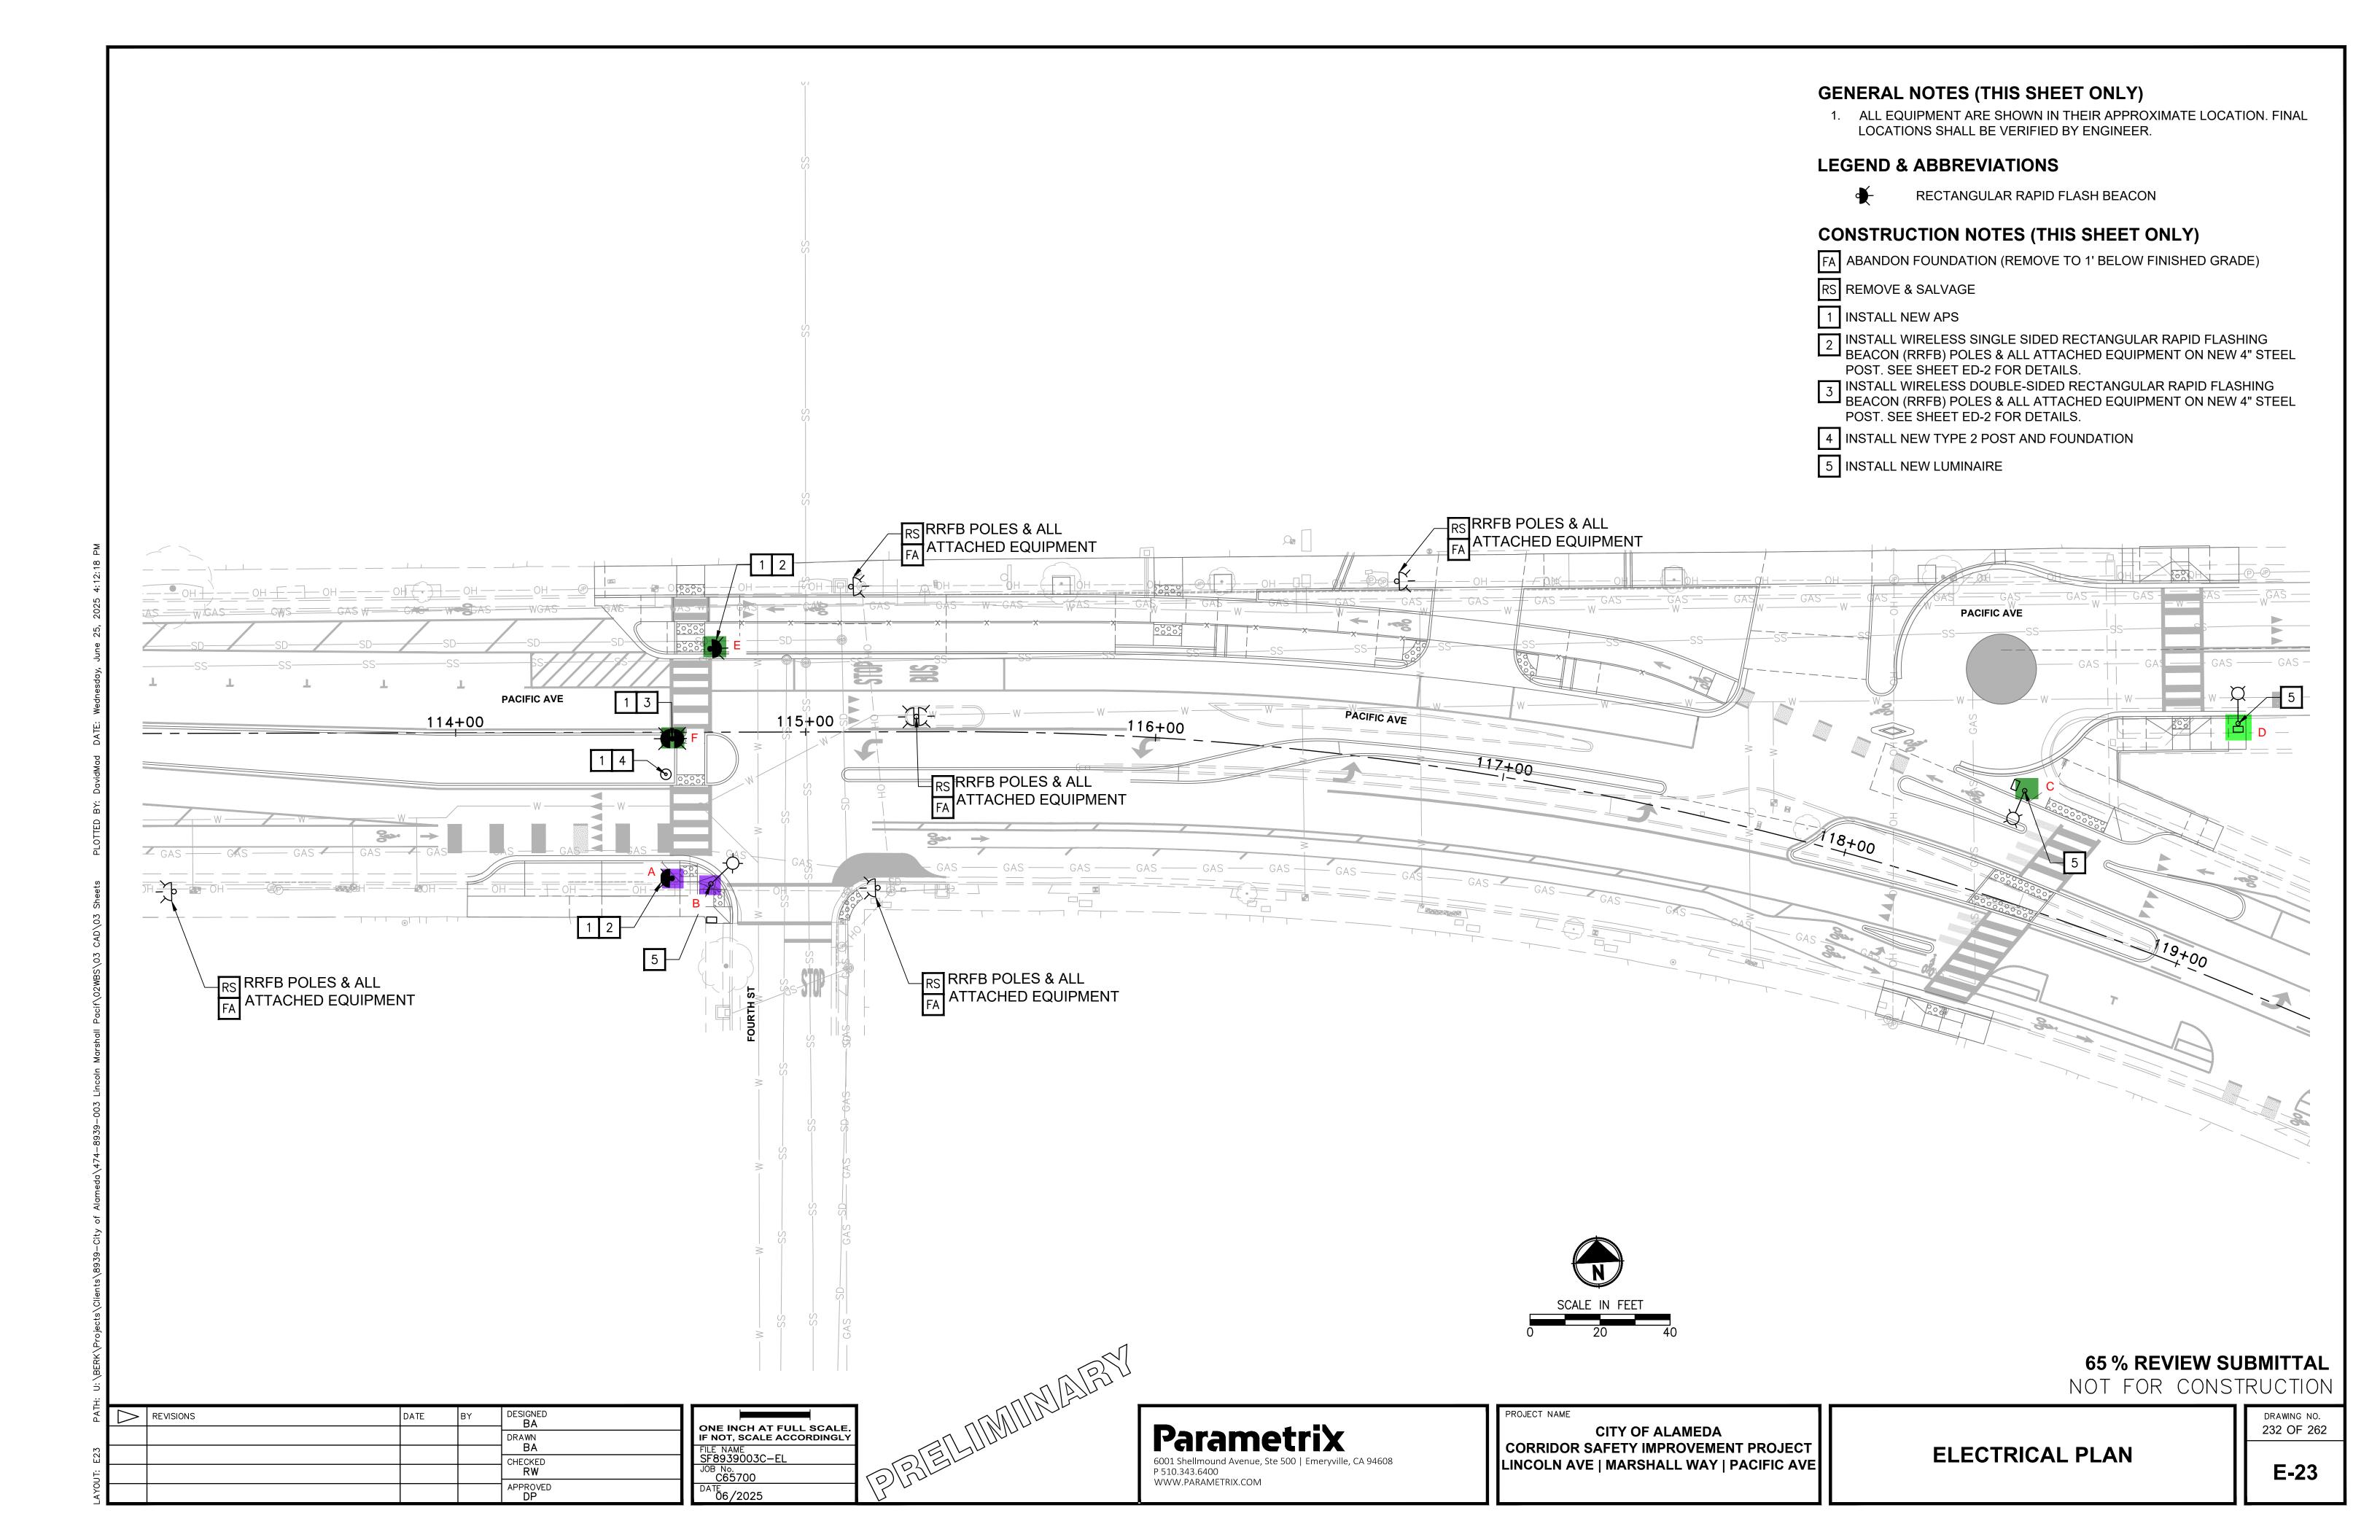
PROJECT NAME


CITY OF ALAMEDA CORRIDOR SAFETY IMPROVEMENT PROJECT LINCOLN AVE | MARSHALL WAY | PACIFIC AVE 65 % REVIEW SUBMITTAL NOT FOR CONSTRUCTION


ELECTRICAL PLAN

E-22

DRAWING NO. 231 OF 262



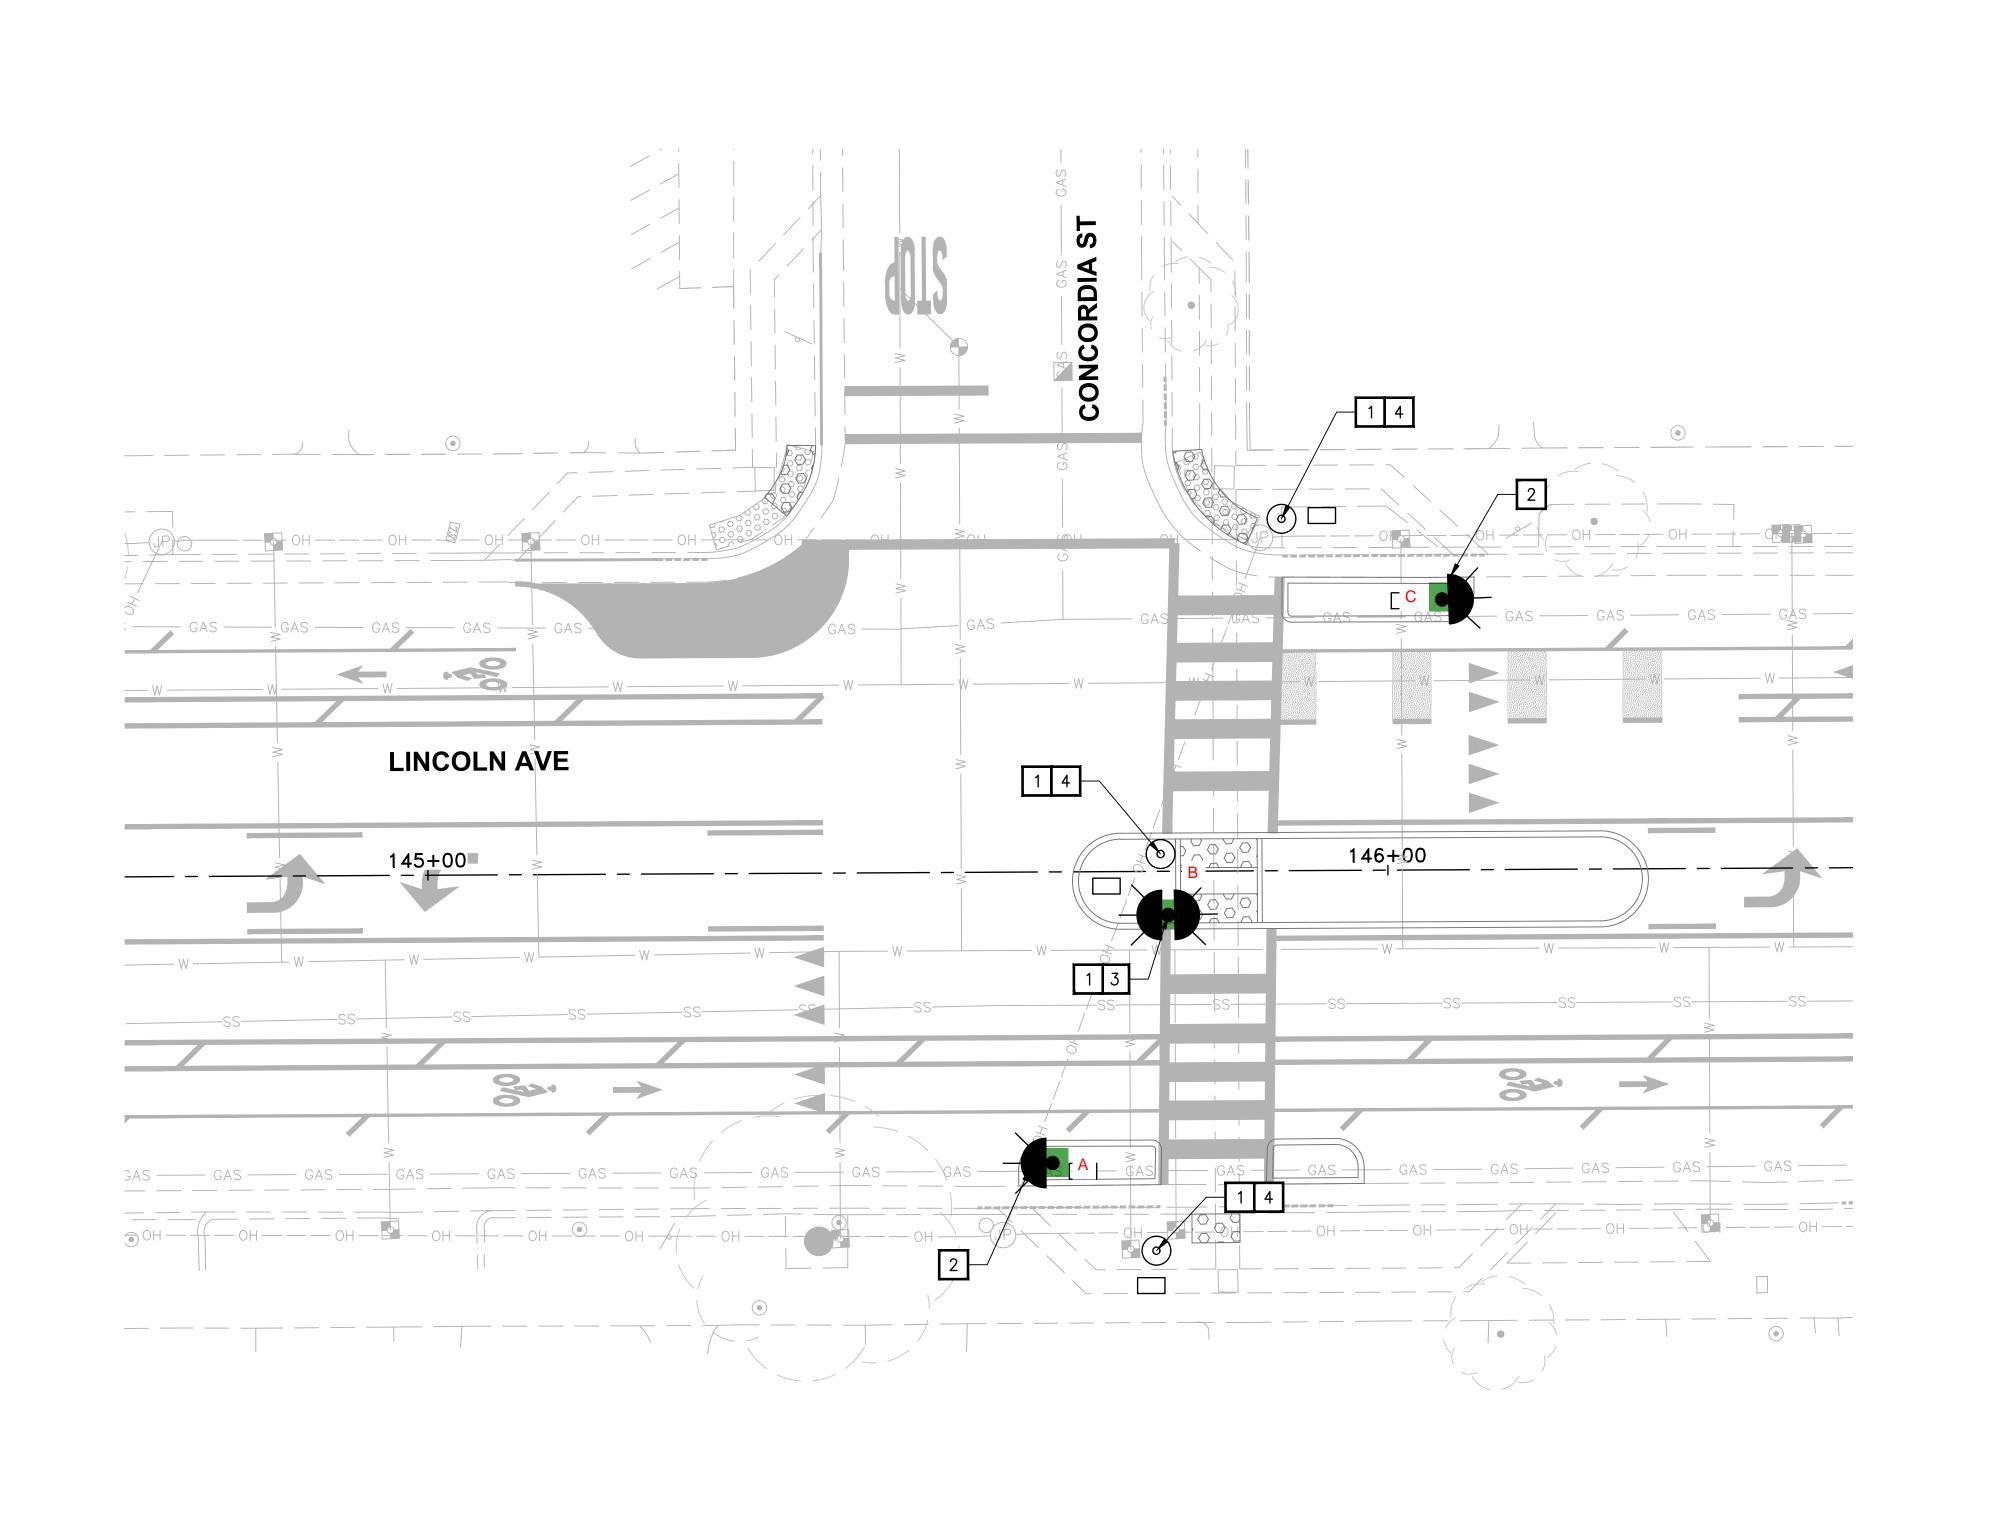

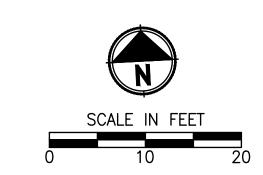

NOT FOR CONSTRUCTION

DESIGNED BA CHECKED **RW** 

REVISIONS

ONE INCH AT FULL SCALE. IF NOT, SCALE ACCORDINGLY

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PROJECT NAME **CITY OF ALAMEDA** 

CORRIDOR SAFETY IMPROVEMENT PROJECT LINCOLN AVE | MARSHALL WAY | PACIFIC AVE

**ELECTRICAL PLAN** 

**GENERAL NOTES (THIS SHEET ONLY)** 

**LEGEND & ABBREVIATIONS** 

POST. SEE SHEET ED-2 FOR DETAILS.

POST. SEE SHEET ED-2 FOR DETAILS.

4 INSTALL NEW TYPE 2 POST AND FOUNDATION

1 INSTALL NEW APS

LOCATIONS SHALL BE VERIFIED BY ENGINEER.

**CONSTRUCTION NOTES (THIS SHEET ONLY)** 


RECTANGULAR RAPID FLASH BEACON


1. ALL EQUIPMENT ARE SHOWN IN THEIR APPROXIMATE LOCATION. FINAL

INSTALL WIRELESS SINGLE SIDED RECTANGULAR RAPID FLASHING BEACON (RRFB) POLES & ALL ATTACHED EQUIPMENT ON NEW 4" STEEL

INSTALL WIRELESS DOUBLE-SIDED RECTANGULAR RAPID FLASHING BEACON (RRFB) POLES & ALL ATTACHED EQUIPMENT ON NEW 4" STEEL

233 OF 262

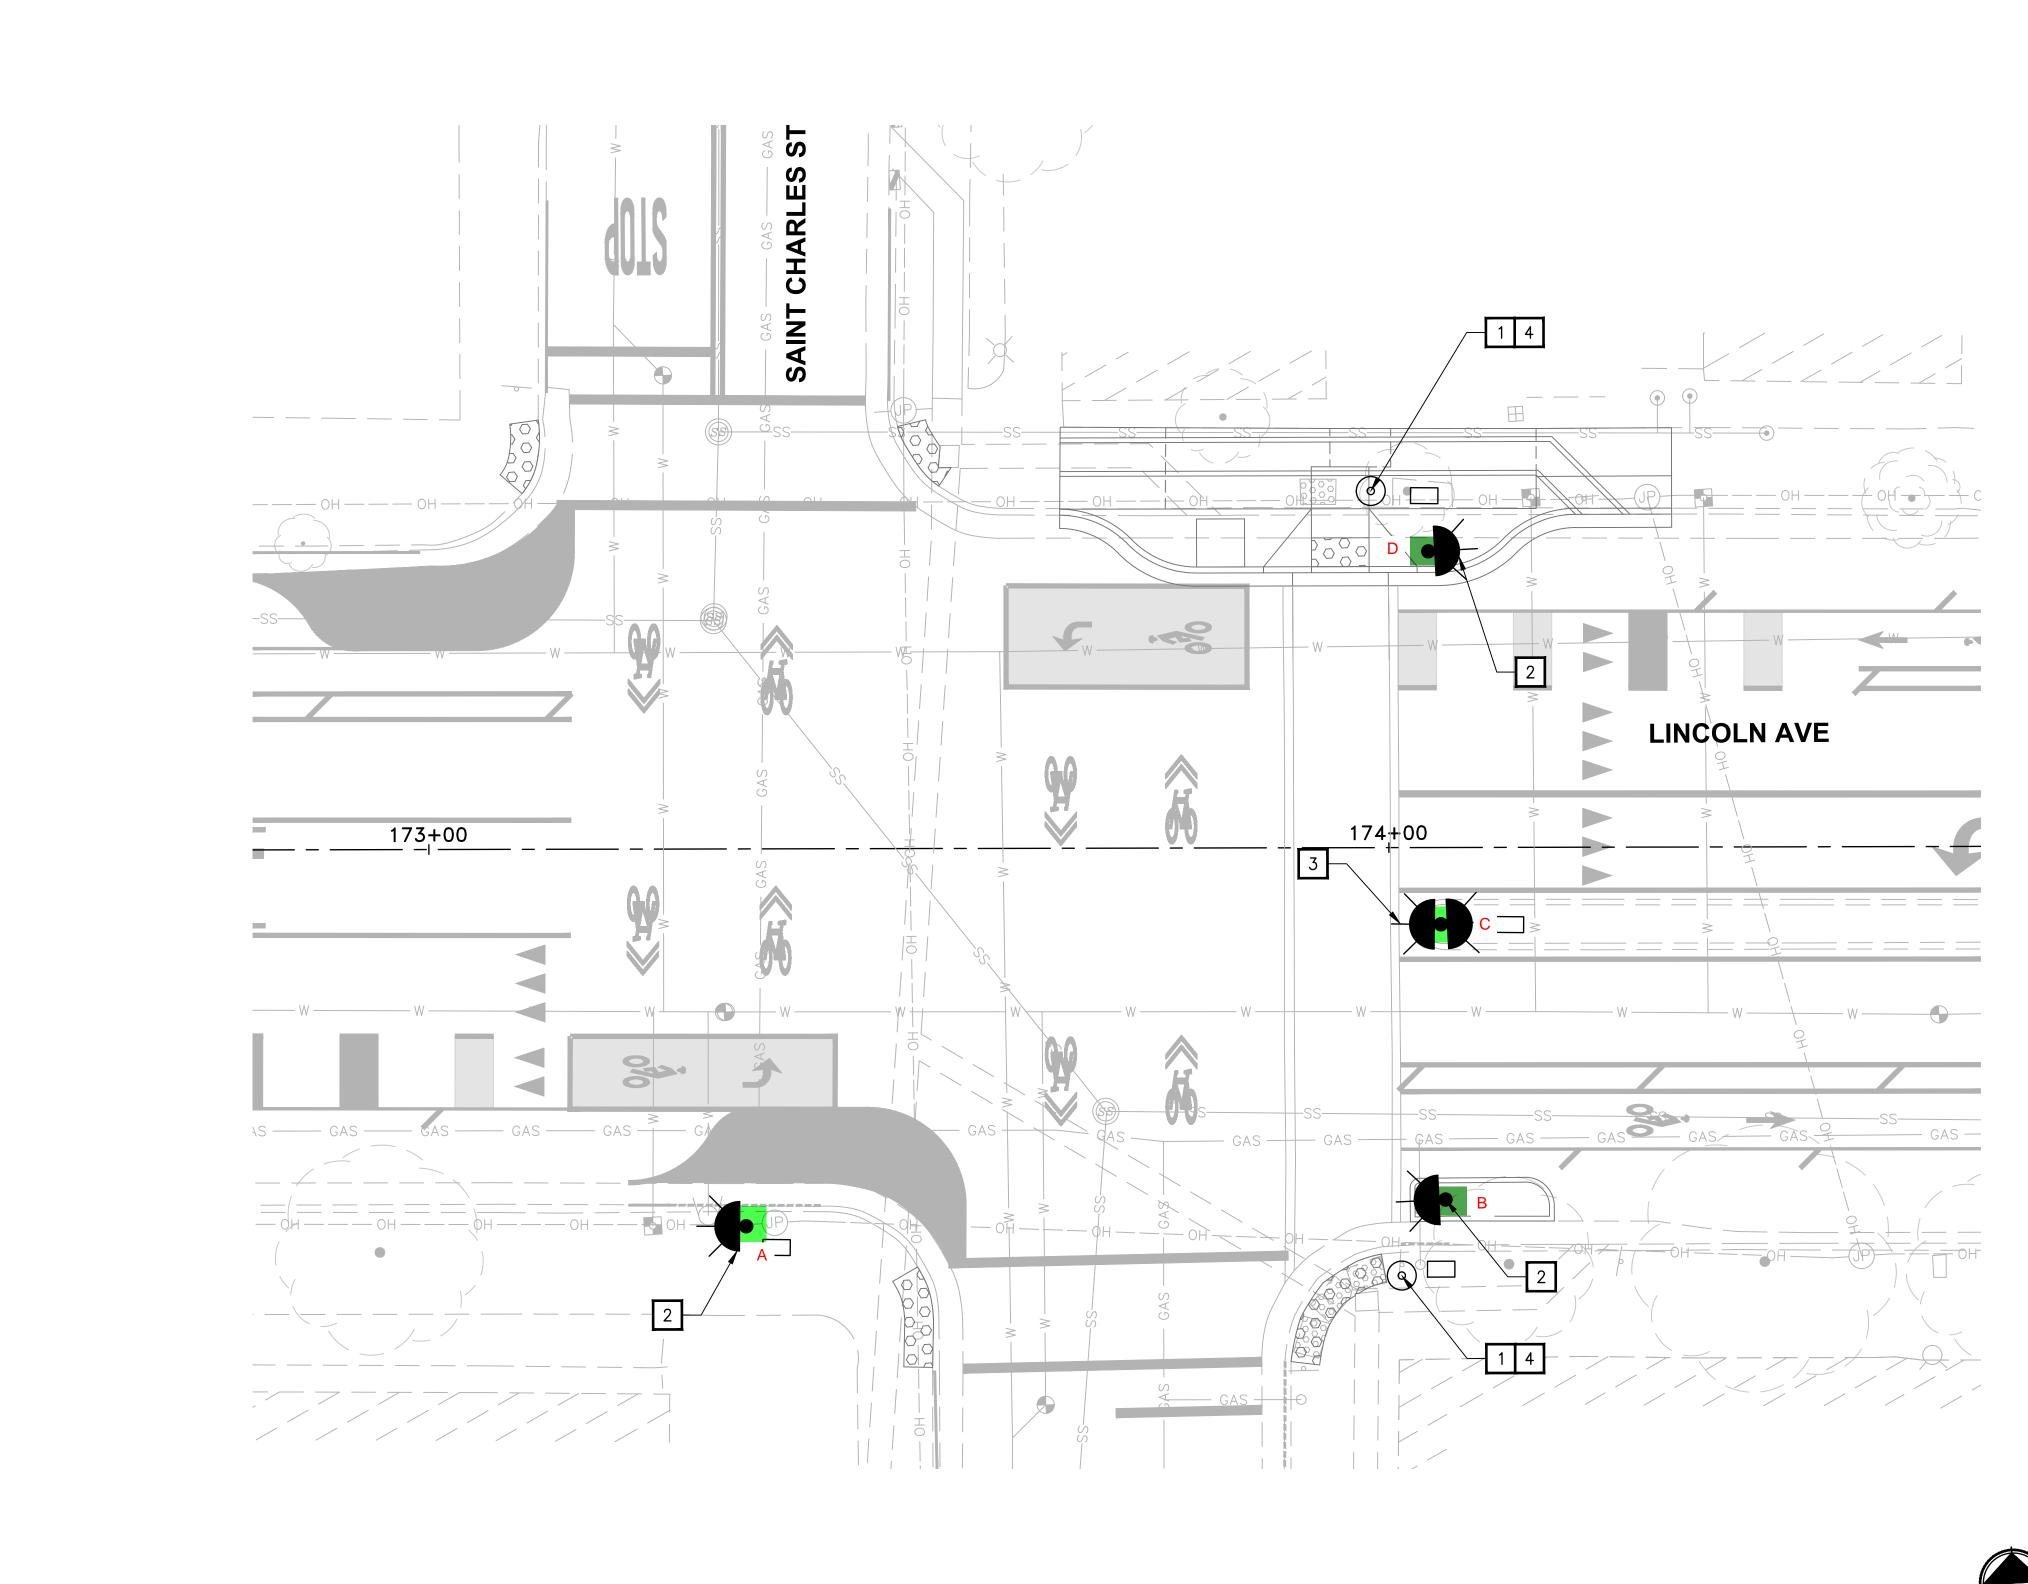

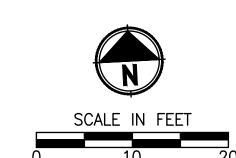

NOT FOR CONSTRUCTION

REVISIONS

DATE
BY
DESIGNED
BA

DRAWN
BA

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RW

ONE INCH AT FULL SCALE.
IF NOT, SCALE ACCORDINGLY

FILE NAME
SF8939003C-EL

JOB No.
C65700

DATE
06/2025

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P 510.343.6400
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PROJECT NAME

CITY OF ALAMEDA CORRIDOR SAFETY IMPROVEMENT PROJECT LINCOLN AVE | MARSHALL WAY | PACIFIC AVE

**ELECTRICAL PLAN** 

**GENERAL NOTES (THIS SHEET ONLY)** 

**LEGEND & ABBREVIATIONS** 

POST. SEE SHEET ED-2 FOR DETAILS.

POST. SEE SHEET ED-2 FOR DETAILS.

4 INSTALL NEW TYPE 2 POST AND FOUNDATION

1 INSTALL NEW APS

LOCATIONS SHALL BE VERIFIED BY ENGINEER.

**CONSTRUCTION NOTES (THIS SHEET ONLY)** 

RECTANGULAR RAPID FLASH BEACON


1. ALL EQUIPMENT ARE SHOWN IN THEIR APPROXIMATE LOCATION. FINAL


INSTALL WIRELESS SINGLE SIDED RECTANGULAR RAPID FLASHING BEACON (RRFB) POLES & ALL ATTACHED EQUIPMENT ON NEW 4" STEEL

INSTALL WIRELESS DOUBLE-SIDED RECTANGULAR RAPID FLASHING BEACON (RRFB) POLES & ALL ATTACHED EQUIPMENT ON NEW 4" STEEL

DRAWING NO. 234 OF 262

\_ PLAN ||

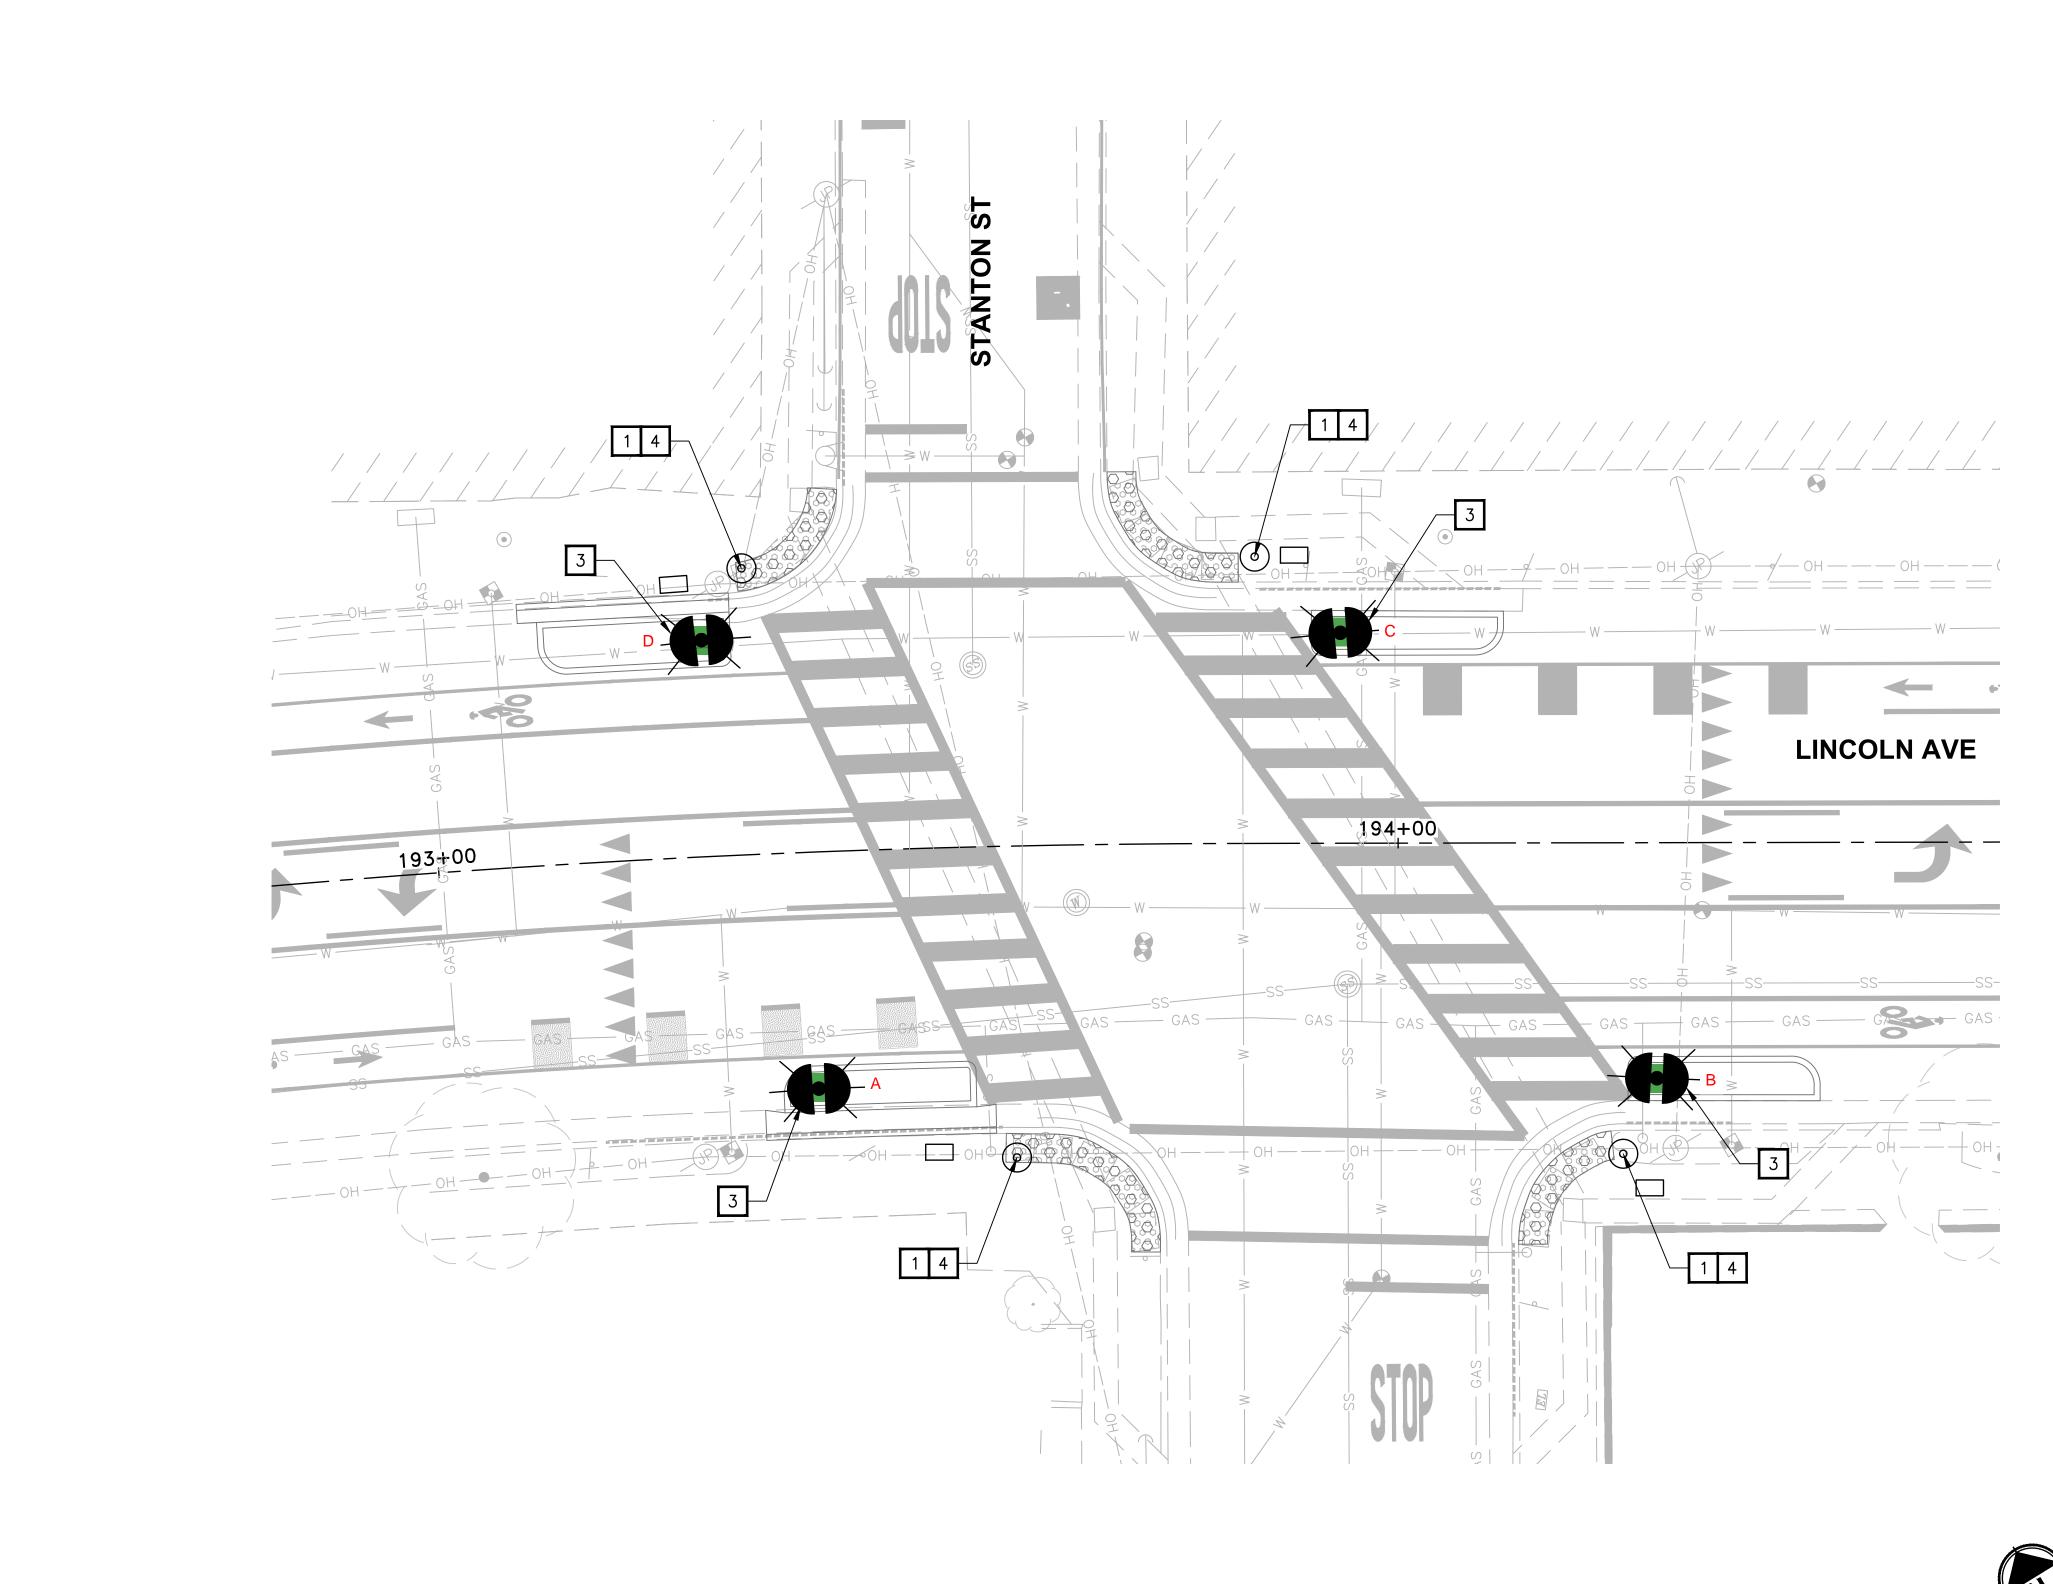

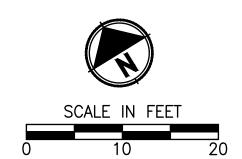

NOT FOR CONSTRUCTION

REVISIONS

DATE
BY

DESIGNED
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CHECKED
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ONE INCH AT FULL SCALE.
IF NOT, SCALE ACCORDINGLY

FILE NAME
SF8939003C-EL

JOB No.
C65700

DATE
06/2025

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PROJECT NAME

CITY OF ALAMEDA CORRIDOR SAFETY IMPROVEMENT PROJECT LINCOLN AVE | MARSHALL WAY | PACIFIC AVE

**ELECTRICAL PLAN** 

**GENERAL NOTES (THIS SHEET ONLY)** 

**LEGEND & ABBREVIATIONS** 

POST. SEE SHEET ED-X FOR DETAILS.

POST. SEE SHEET ED-X FOR DETAILS.

4 INSTALL NEW TYPE 2 POST AND FOUNDATION

1 INSTALL NEW APS

LOCATIONS SHALL BE VERIFIED BY ENGINEER.

**CONSTRUCTION NOTES (THIS SHEET ONLY)** 

RECTANGULAR RAPID FLASH BEACON


INSTALL WIRELESS SINGLE SIDED RECTANGULAR RAPID FLASHING BEACON (RRFB) POLES & ALL ATTACHED EQUIPMENT ON NEW 4" STEEL


INSTALL WIRELESS DOUBLE-SIDED RECTANGULAR RAPID FLASHING BEACON (RRFB) POLES & ALL ATTACHED EQUIPMENT ON NEW 4" STEEL

1. ALL EQUIPMENT ARE SHOWN IN THEIR APPROXIMATE LOCATION. FINAL

DRAWING NO. 235 OF 262

AN || E-26

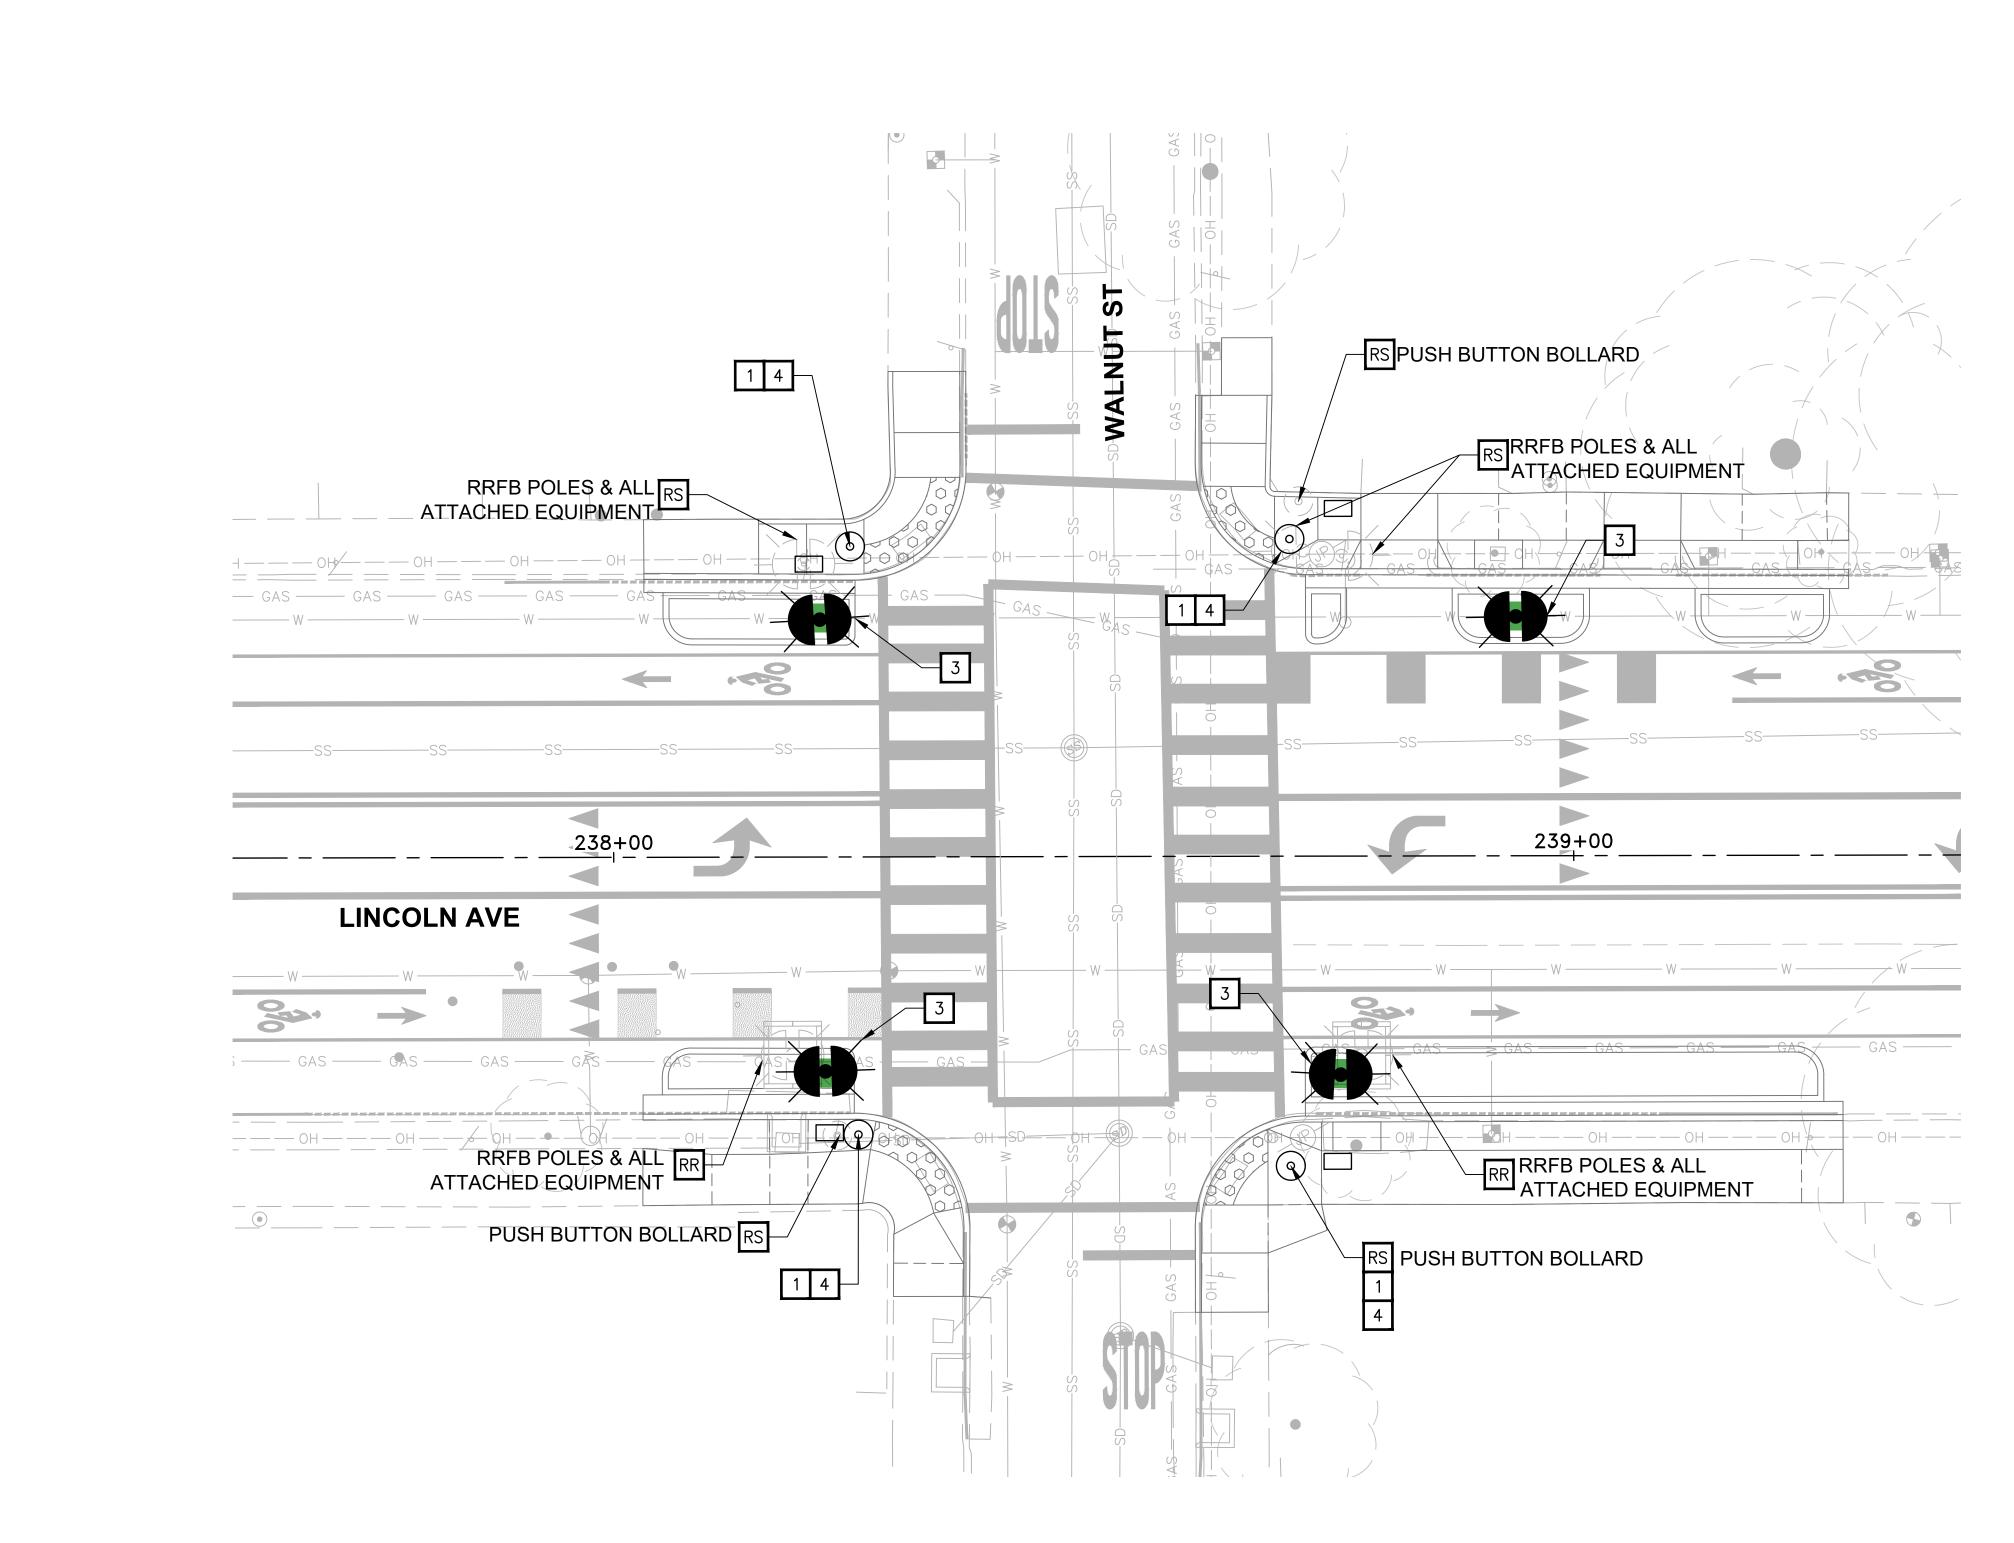

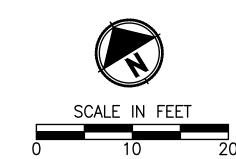

NOT FOR CONSTRUCTION

DATE BY DESIGNED BA

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REVISIONS

ONE INCH AT FULL SCALE.
IF NOT, SCALE ACCORDINGLY

FILE NAME
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PROJECT NAME

CITY OF ALAMEDA CORRIDOR SAFETY IMPROVEMENT PROJECT LINCOLN AVE | MARSHALL WAY | PACIFIC AVE

**ELECTRICAL PLAN** 

**GENERAL NOTES (THIS SHEET ONLY)** 

**LEGEND & ABBREVIATIONS** 

POST. SEE SHEET ED-X FOR DETAILS.

POST. SEE SHEET ED-X FOR DETAILS.

4 INSTALL NEW TYPE 2 POST AND FOUNDATION

RS REMOVE & SALVAGE

5 INSTALL NEW LUMINAIRE

1 INSTALL NEW APS

LOCATIONS SHALL BE VERIFIED BY ENGINEER.

**CONSTRUCTION NOTES (THIS SHEET ONLY)** 

RECTANGULAR RAPID FLASH BEACON

2 INSTALL WIRELESS SINGLE SIDED RECTANGULAR RAPID FLASHING

3 INSTALL WIRELESS DOUBLE-SIDED RECTANGULAR RAPID FLASHING


BEACON (RRFB) POLES & ALL ATTACHED EQUIPMENT ON NEW 4" STEEL


BEACON (RRFB) POLES & ALL ATTACHED EQUIPMENT ON NEW 4" STEEL

1. ALL EQUIPMENT ARE SHOWN IN THEIR APPROXIMATE LOCATION. FINAL

DRAWING NO. 236 OF 262

|| E-27

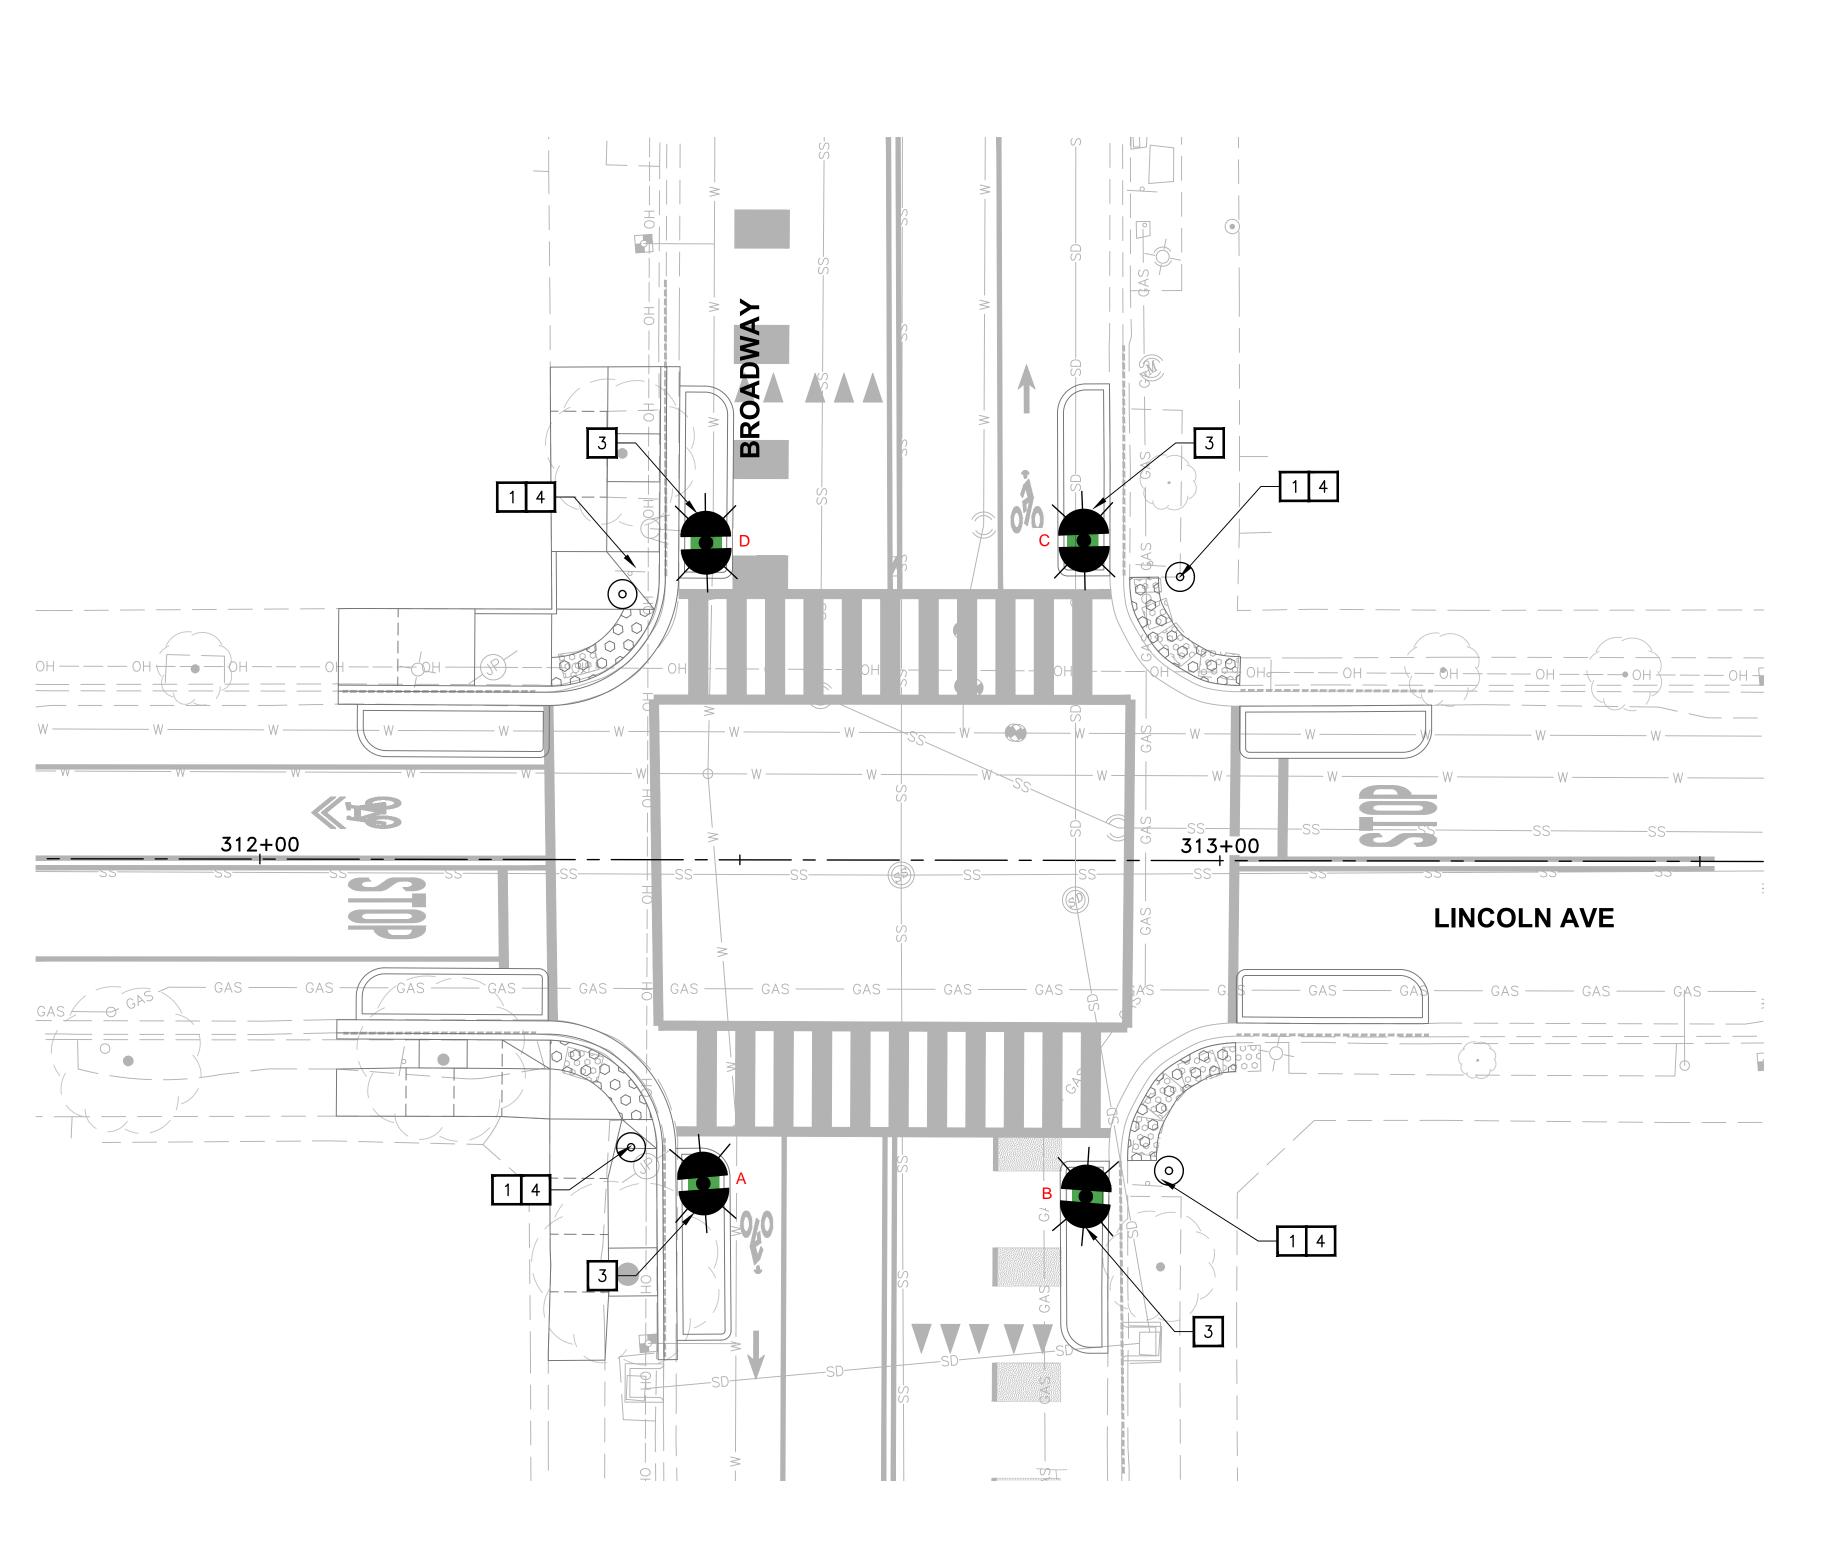

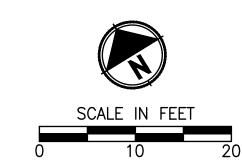

NOT FOR CONSTRUCTION

REVISIONS

ONE INCH AT FULL SCALE. IF NOT, SCALE ACCORDINGLY

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PROJECT NAME

**CITY OF ALAMEDA** CORRIDOR SAFETY IMPROVEMENT PROJECT LINCOLN AVE | MARSHALL WAY | PACIFIC AVE

**ELECTRICAL PLAN** 

**GENERAL NOTES (THIS SHEET ONLY)** 

**LEGEND & ABBREVIATIONS** 

POST. SEE SHEET ED-X FOR DETAILS.

4 INSTALL NEW TYPE 2 POST AND FOUNDATION

1 INSTALL NEW APS

LOCATIONS SHALL BE VERIFIED BY ENGINEER.

**CONSTRUCTION NOTES (THIS SHEET ONLY)** 


RECTANGULAR RAPID FLASH BEACON


INSTALL WIRELESS DOUBLE-SIDED RECTANGULAR RAPID FLASHING BEACON (RRFB) POLES & ALL ATTACHED EQUIPMENT ON NEW 4" STEEL

1. ALL EQUIPMENT ARE SHOWN IN THEIR APPROXIMATE LOCATION. FINAL

237 OF 262

1. NO LANDSCAPE IMPROVEMENTS THIS SHEET

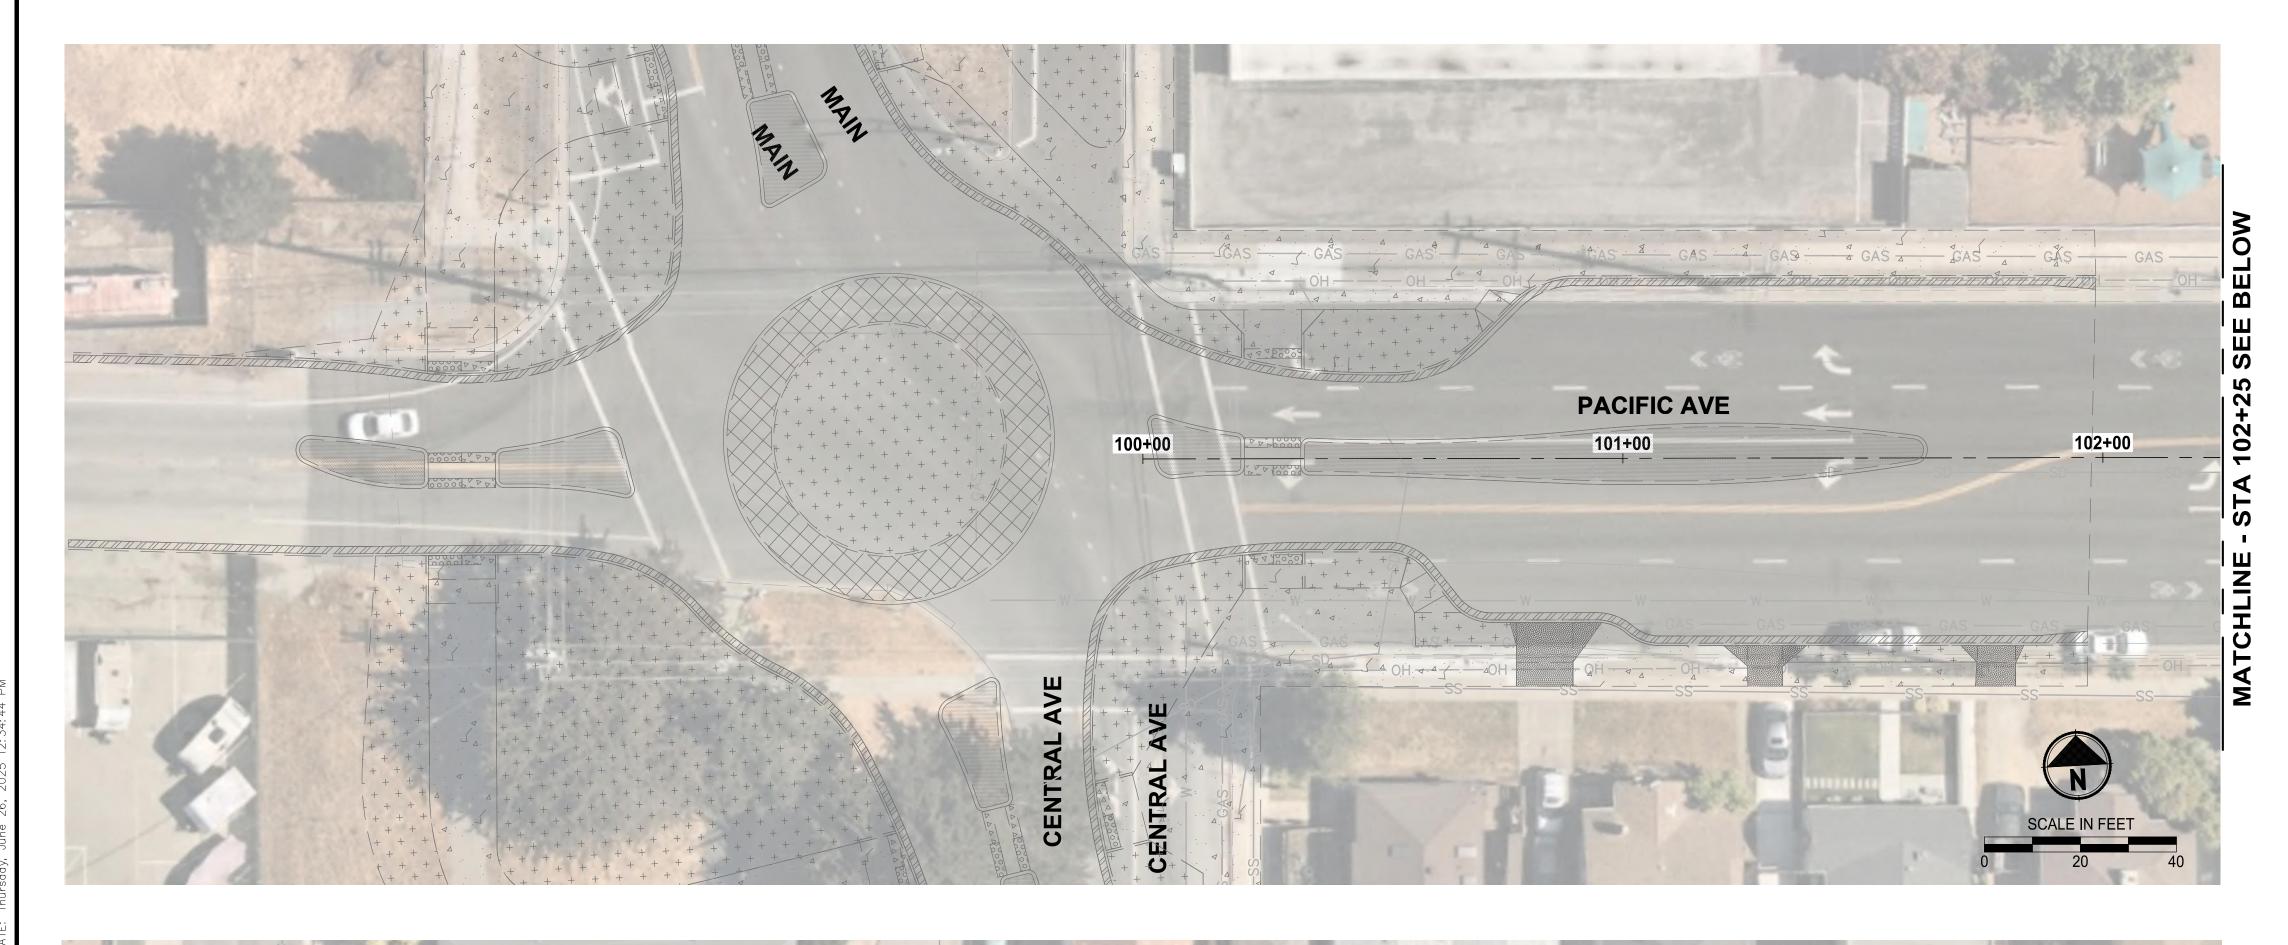

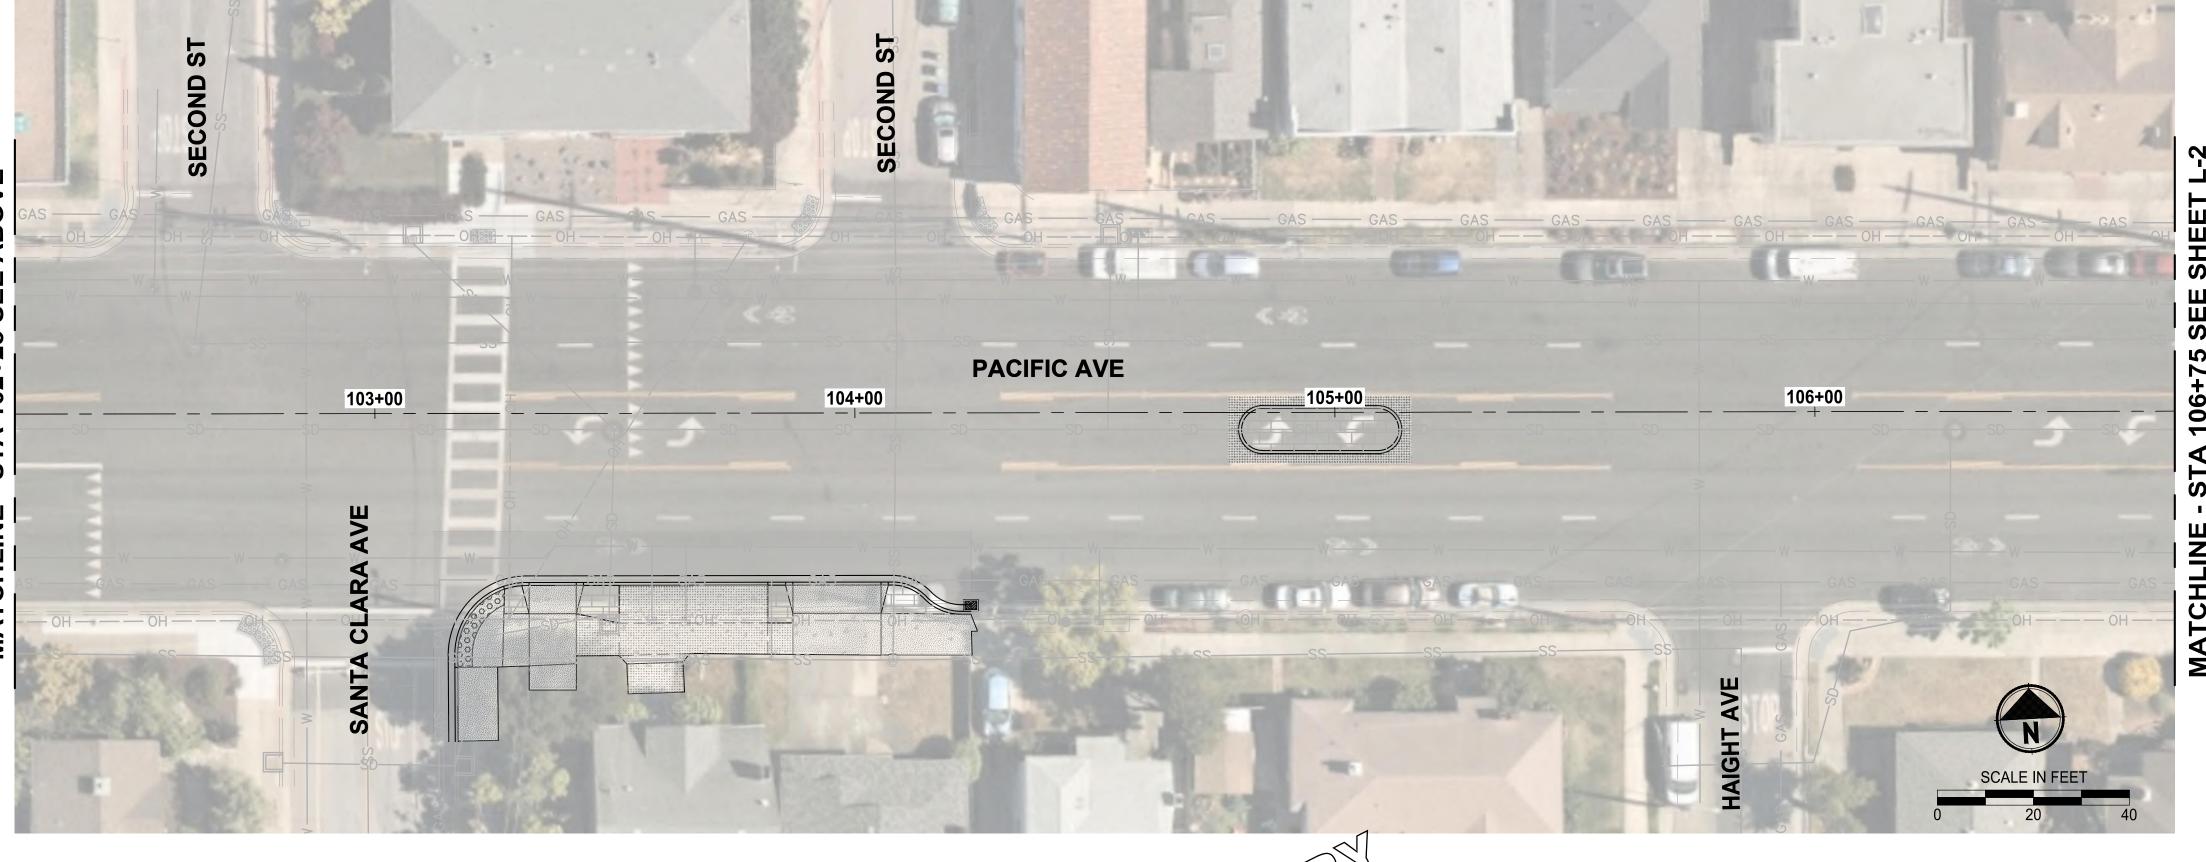

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CITY OF ALAMEDA CORRIDOR SAFETY IMPROVEMENT PROJECT LINCOLN AVE | MARSHALL WAY | PACIFIC AVE

LANDSCAPE PLAN

DRAWING NO. **240 OF 262** 


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PATH	REVISIONS	DATE	BY	DESIGNED DSB
<u></u>				DRAWN DSB
				CHECKED DCS
				APPROVED.

	ONE INCH AT FULL SCALE. IF NOT, SCALE ACCORDINGLY	
	FILE NAME SF8939003C-LS	
	JOB No. C65700	6
	DATE 06/2025	7

P6 6001 St P 510.3 WWW.

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P 510.343.6400
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- ALL WORK SHALL BE PERFORMED TO THE SATISFACTION OF THE 2. OWNER'S REPRESENTATIVE.
- 3. ALL AREAS DISTURBED BY CONSTRUCTION SHALL BE RESTORED.

## **LEGEND & ABBREVIATIONS**

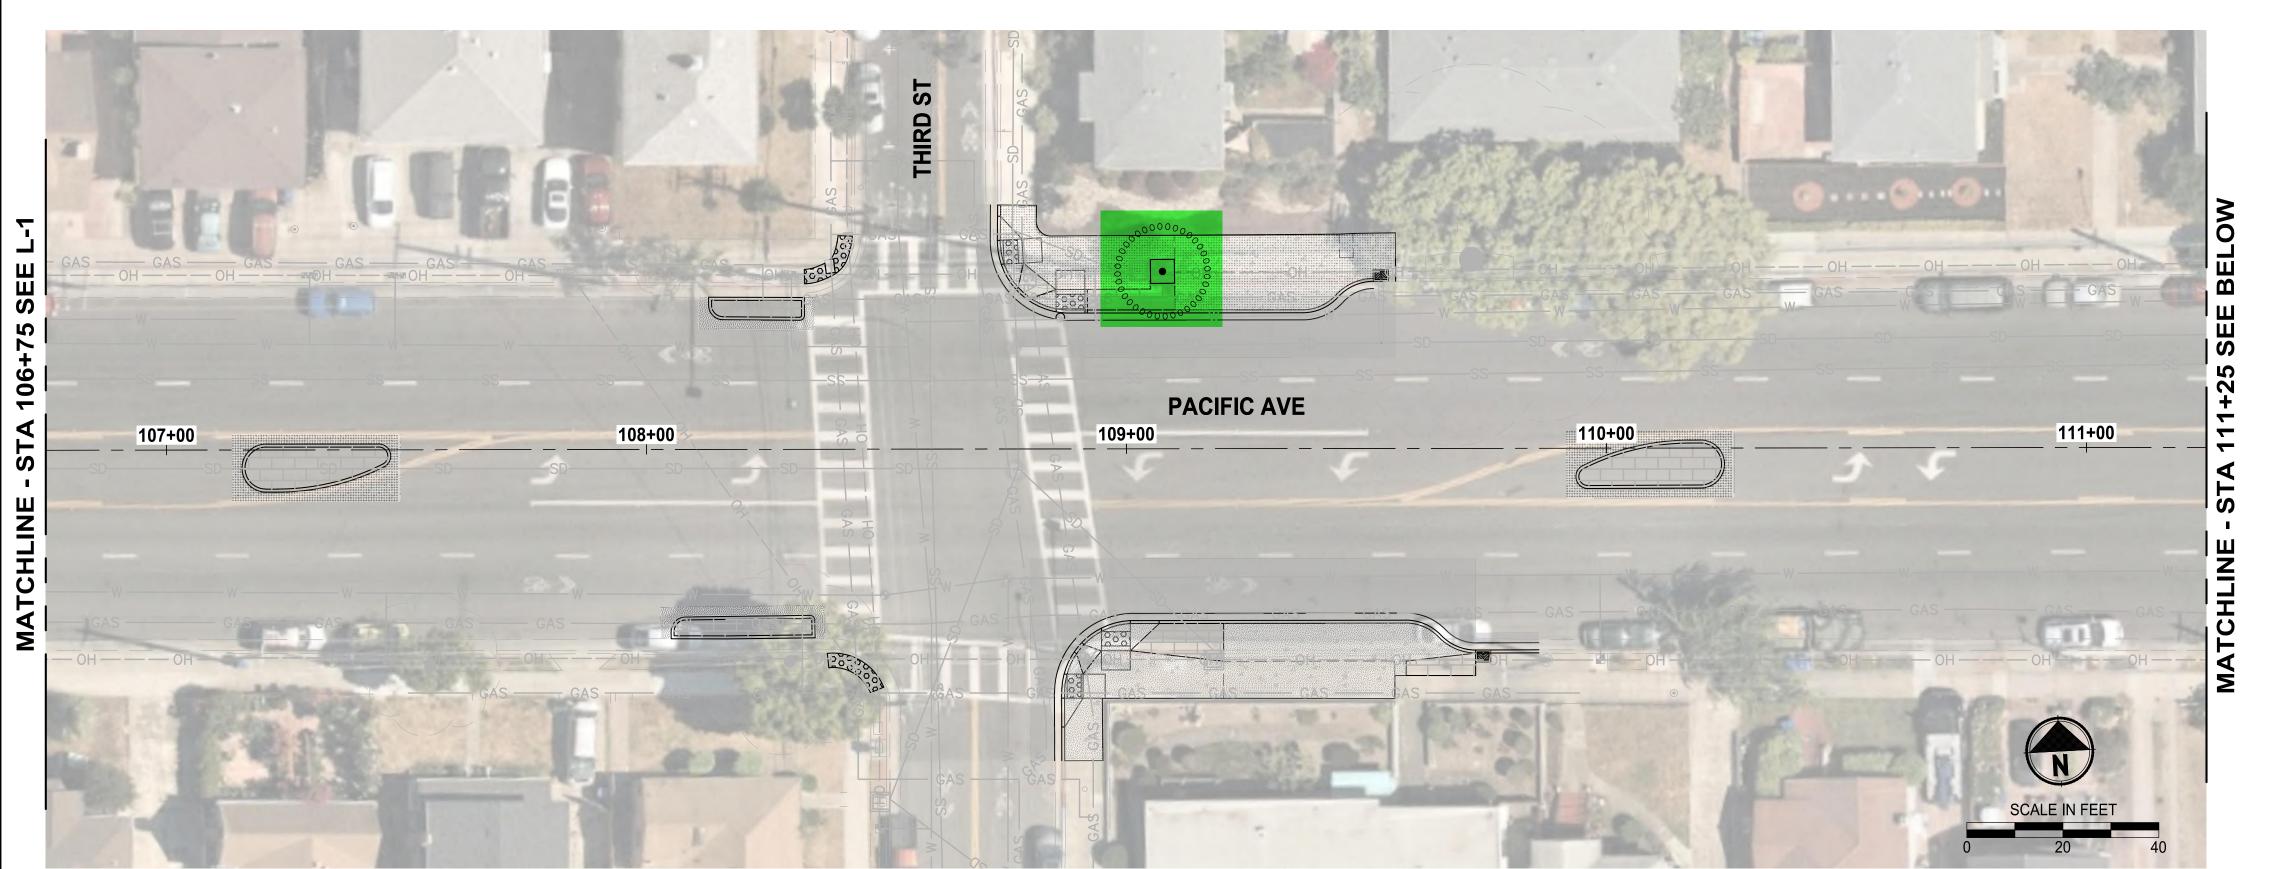· · · · · · ·	· · · · · · · · · · · · · · · · · · ·
$\bigcirc$	OCTOBER GLORY RED MAPLE
	RED FLOWERING GUM
	STERLING SILVER LINDEN
00000000000000000000000000000000000000	ACCOLADE ELM
•	ORCHID ROSE
	SAGELEAF ROCKROSE
	YANKEE POINT CARMEL CREEPER
$\bigcirc$	STICKY MONKEYFLOWER
	FORTNIGHT LILY
	WHITE PACIFIC COAST IRIS
	ISLAND MALLOW
$\langle \cdot \rangle$	DEER GRASS

	_
FOOTHILL SEDGE	
SMALL CAPE RUSH	

**HUMMINGBIRD SAGE** 

**CLEVELAND SAGE** 

BEACH STRAWBERRY

SPREADING RUSH

LOW HORIZON COAST ROSEMARY

65 % REVIEW SUBMITTAL

DESIGNED DSB REVISIONS DRAWN DSB CHECKED DCS APPROVED DP


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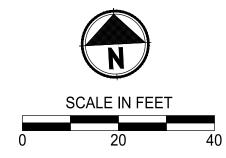
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CITY OF ALAMEDA
CORRIDOR SAFETY IMPROVEMENT PROJECT LINCOLN AVE | MARSHALL WAY | PACIFIC AVE NOT FOR CONSTRUCTION

LANDSCAPE PLAN

DRAWING NO. 241 OF 262



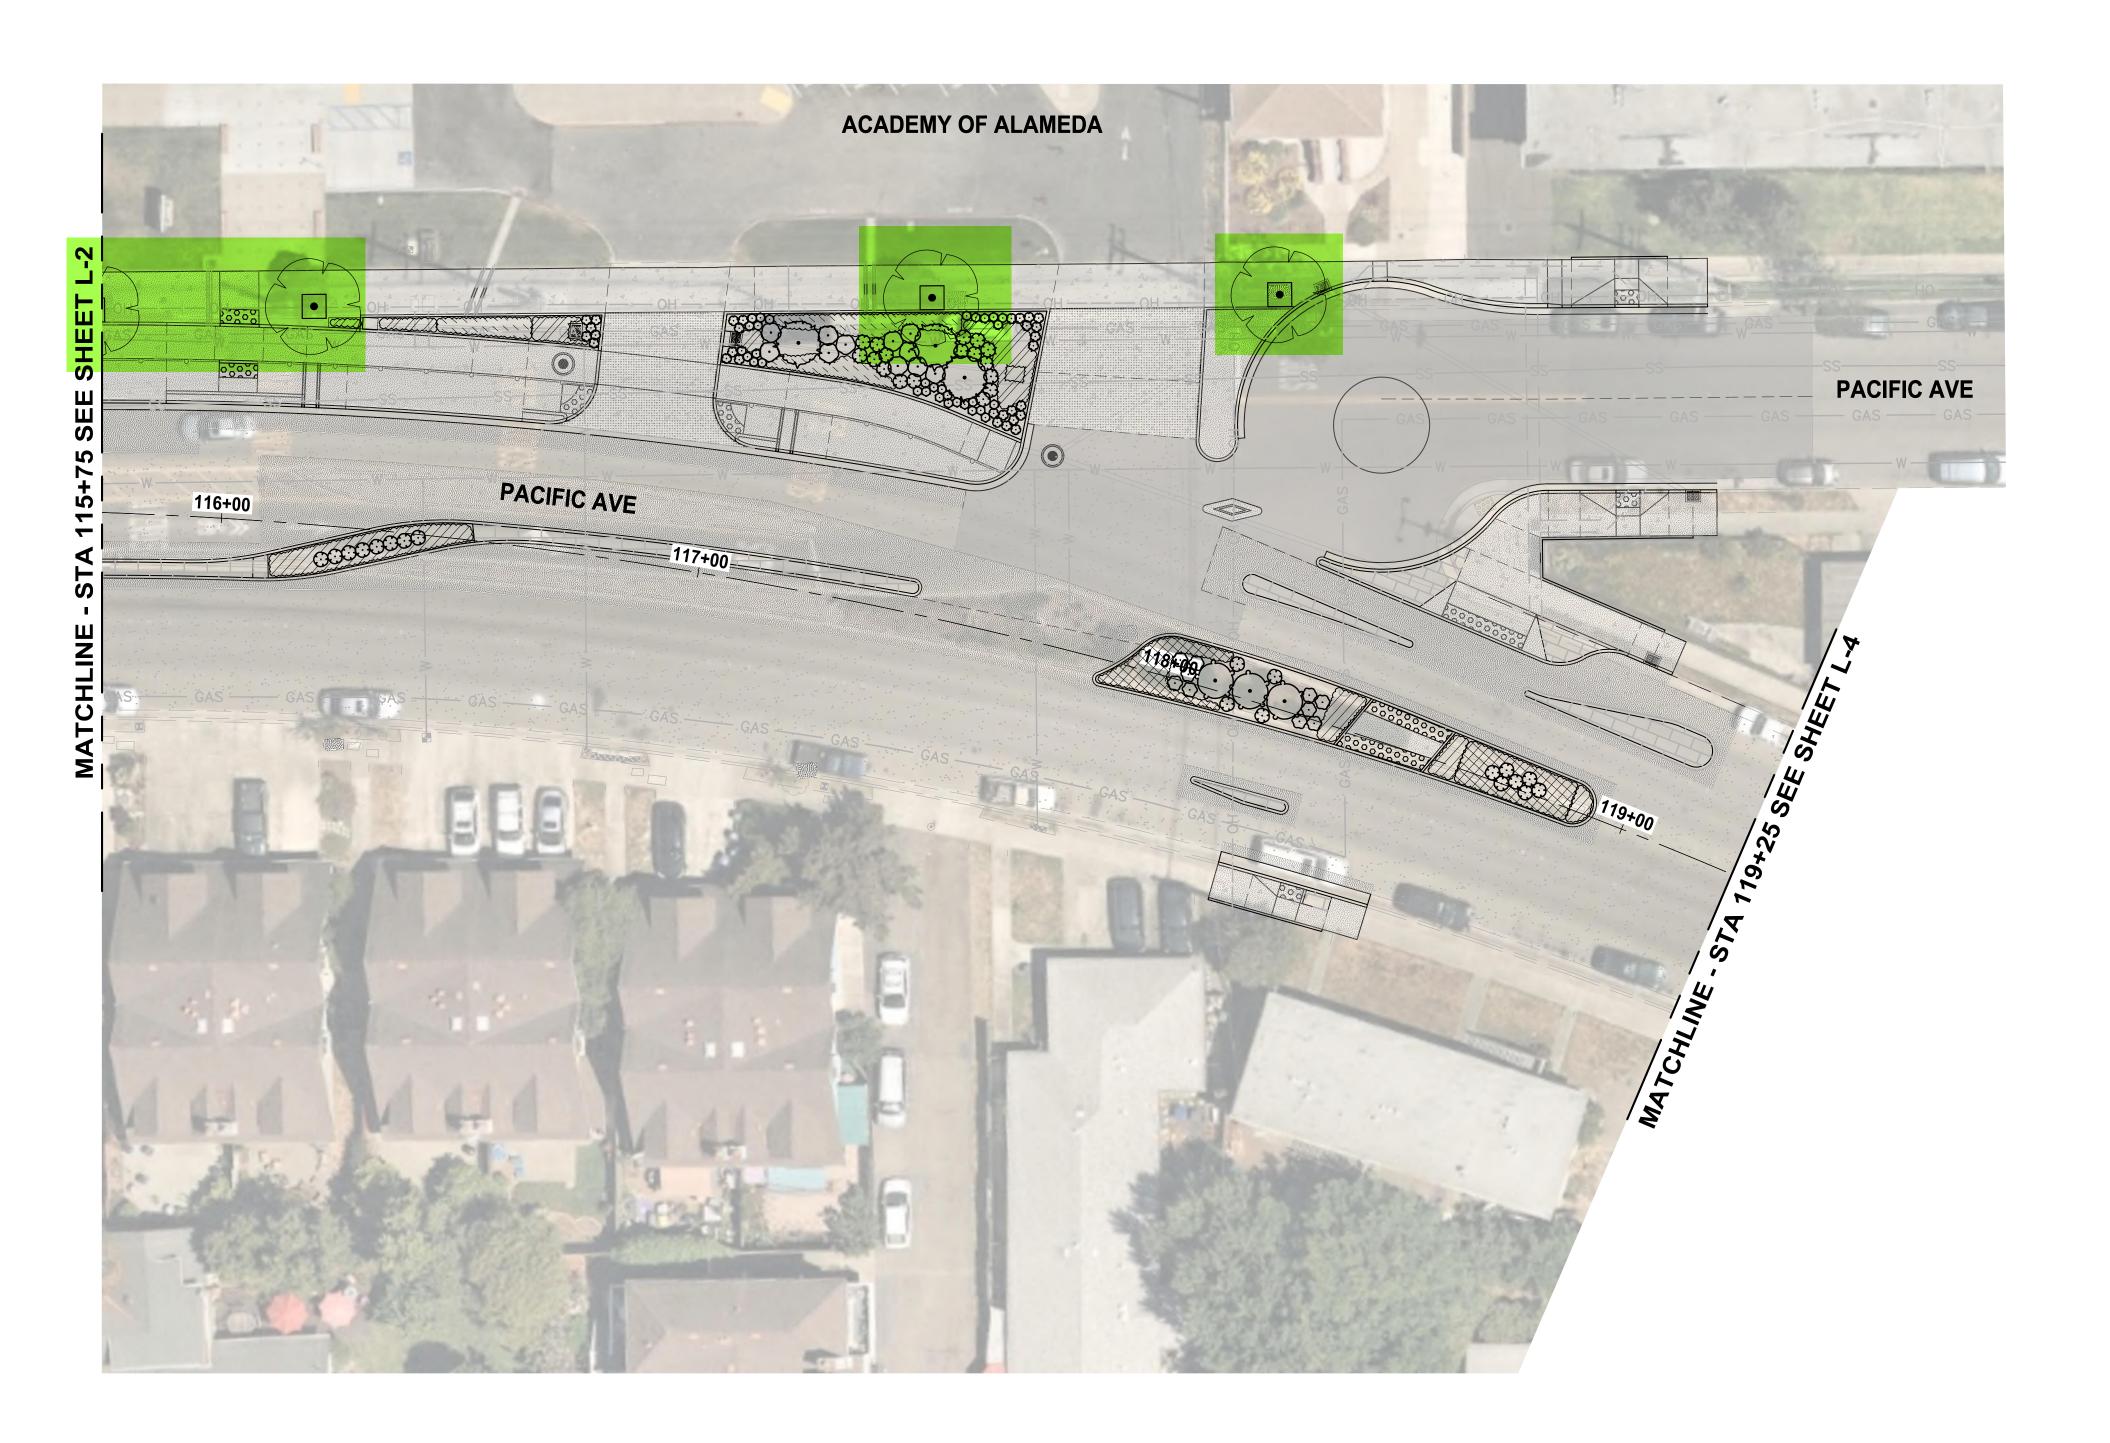

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LEGEND &	ABBREVIATIONS
$\bigcirc$	OCTOBER GLORY RED MAPLE
	RED FLOWERING GUM
	STERLING SILVER LINDEN
00000000000000000000000000000000000000	ACCOLADE ELM
	ORCHID ROSE
	SAGELEAF ROCKROSE
	YANKEE POINT CARMEL CREEPER
	STICKY MONKEYFLOWER
	FORTNIGHT LILY
	WHITE PACIFIC COAST IRIS
	ISLAND MALLOW
$\langle \cdot \rangle$	DEER GRASS
	HUMMINGBIRD SAGE
•	CLEVELAND SAGE
	FOOTHILL SEDGE
	SMALL CAPE RUSH
	BEACH STRAWBERRY
	SPREADING RUSH
	LOW HORIZON COAST ROSEMARY

65 % REVIEW SUBMITTAL

NOT FOR CONSTRUCTION

DESIGNED DSB DRAWN DSB CHECKED DCS

APPROVED DP

REVISIONS

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CITY OF ALAMEDA CORRIDOR SAFETY IMPROVEMENT PROJECT LINCOLN AVE | MARSHALL WAY | PACIFIC AVE

LANDSCAPE PLAN

DRAWING NO. **242 OF 262** 



- REFER TO SHEET L-23 FOR LANDSCAPE CONSTRUCTION NOTES, DETAILS, AND PLANT SCHEULE.
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LEGEND &	ABBREVIATIONS
$\bigcirc$	OCTOBER GLORY RED MAPLE
	RED FLOWERING GUM
E C	STERLING SILVER LINDEN
00 <sup>0000</sup> 000000000000000000000000000000	ACCOLADE ELM
	ORCHID ROSE
•	SAGELEAF ROCKROSE
	YANKEE POINT CARMEL CREEPER
	STICKY MONKEYFLOWER
	FORTNIGHT LILY
	WHITE PACIFIC COAST IRIS
	ISLAND MALLOW
•	DEER GRASS
	HUMMINGBIRD SAGE
•	CLEVELAND SAGE
	FOOTHILL SEDGE
	SMALL CAPE RUSH
	BEACH STRAWBERRY
	SPREADING RUSH
	LOW HORIZON COAST ROSEMARY

65 % REVIEW SUBMITTAL NOT FOR CONSTRUCTION

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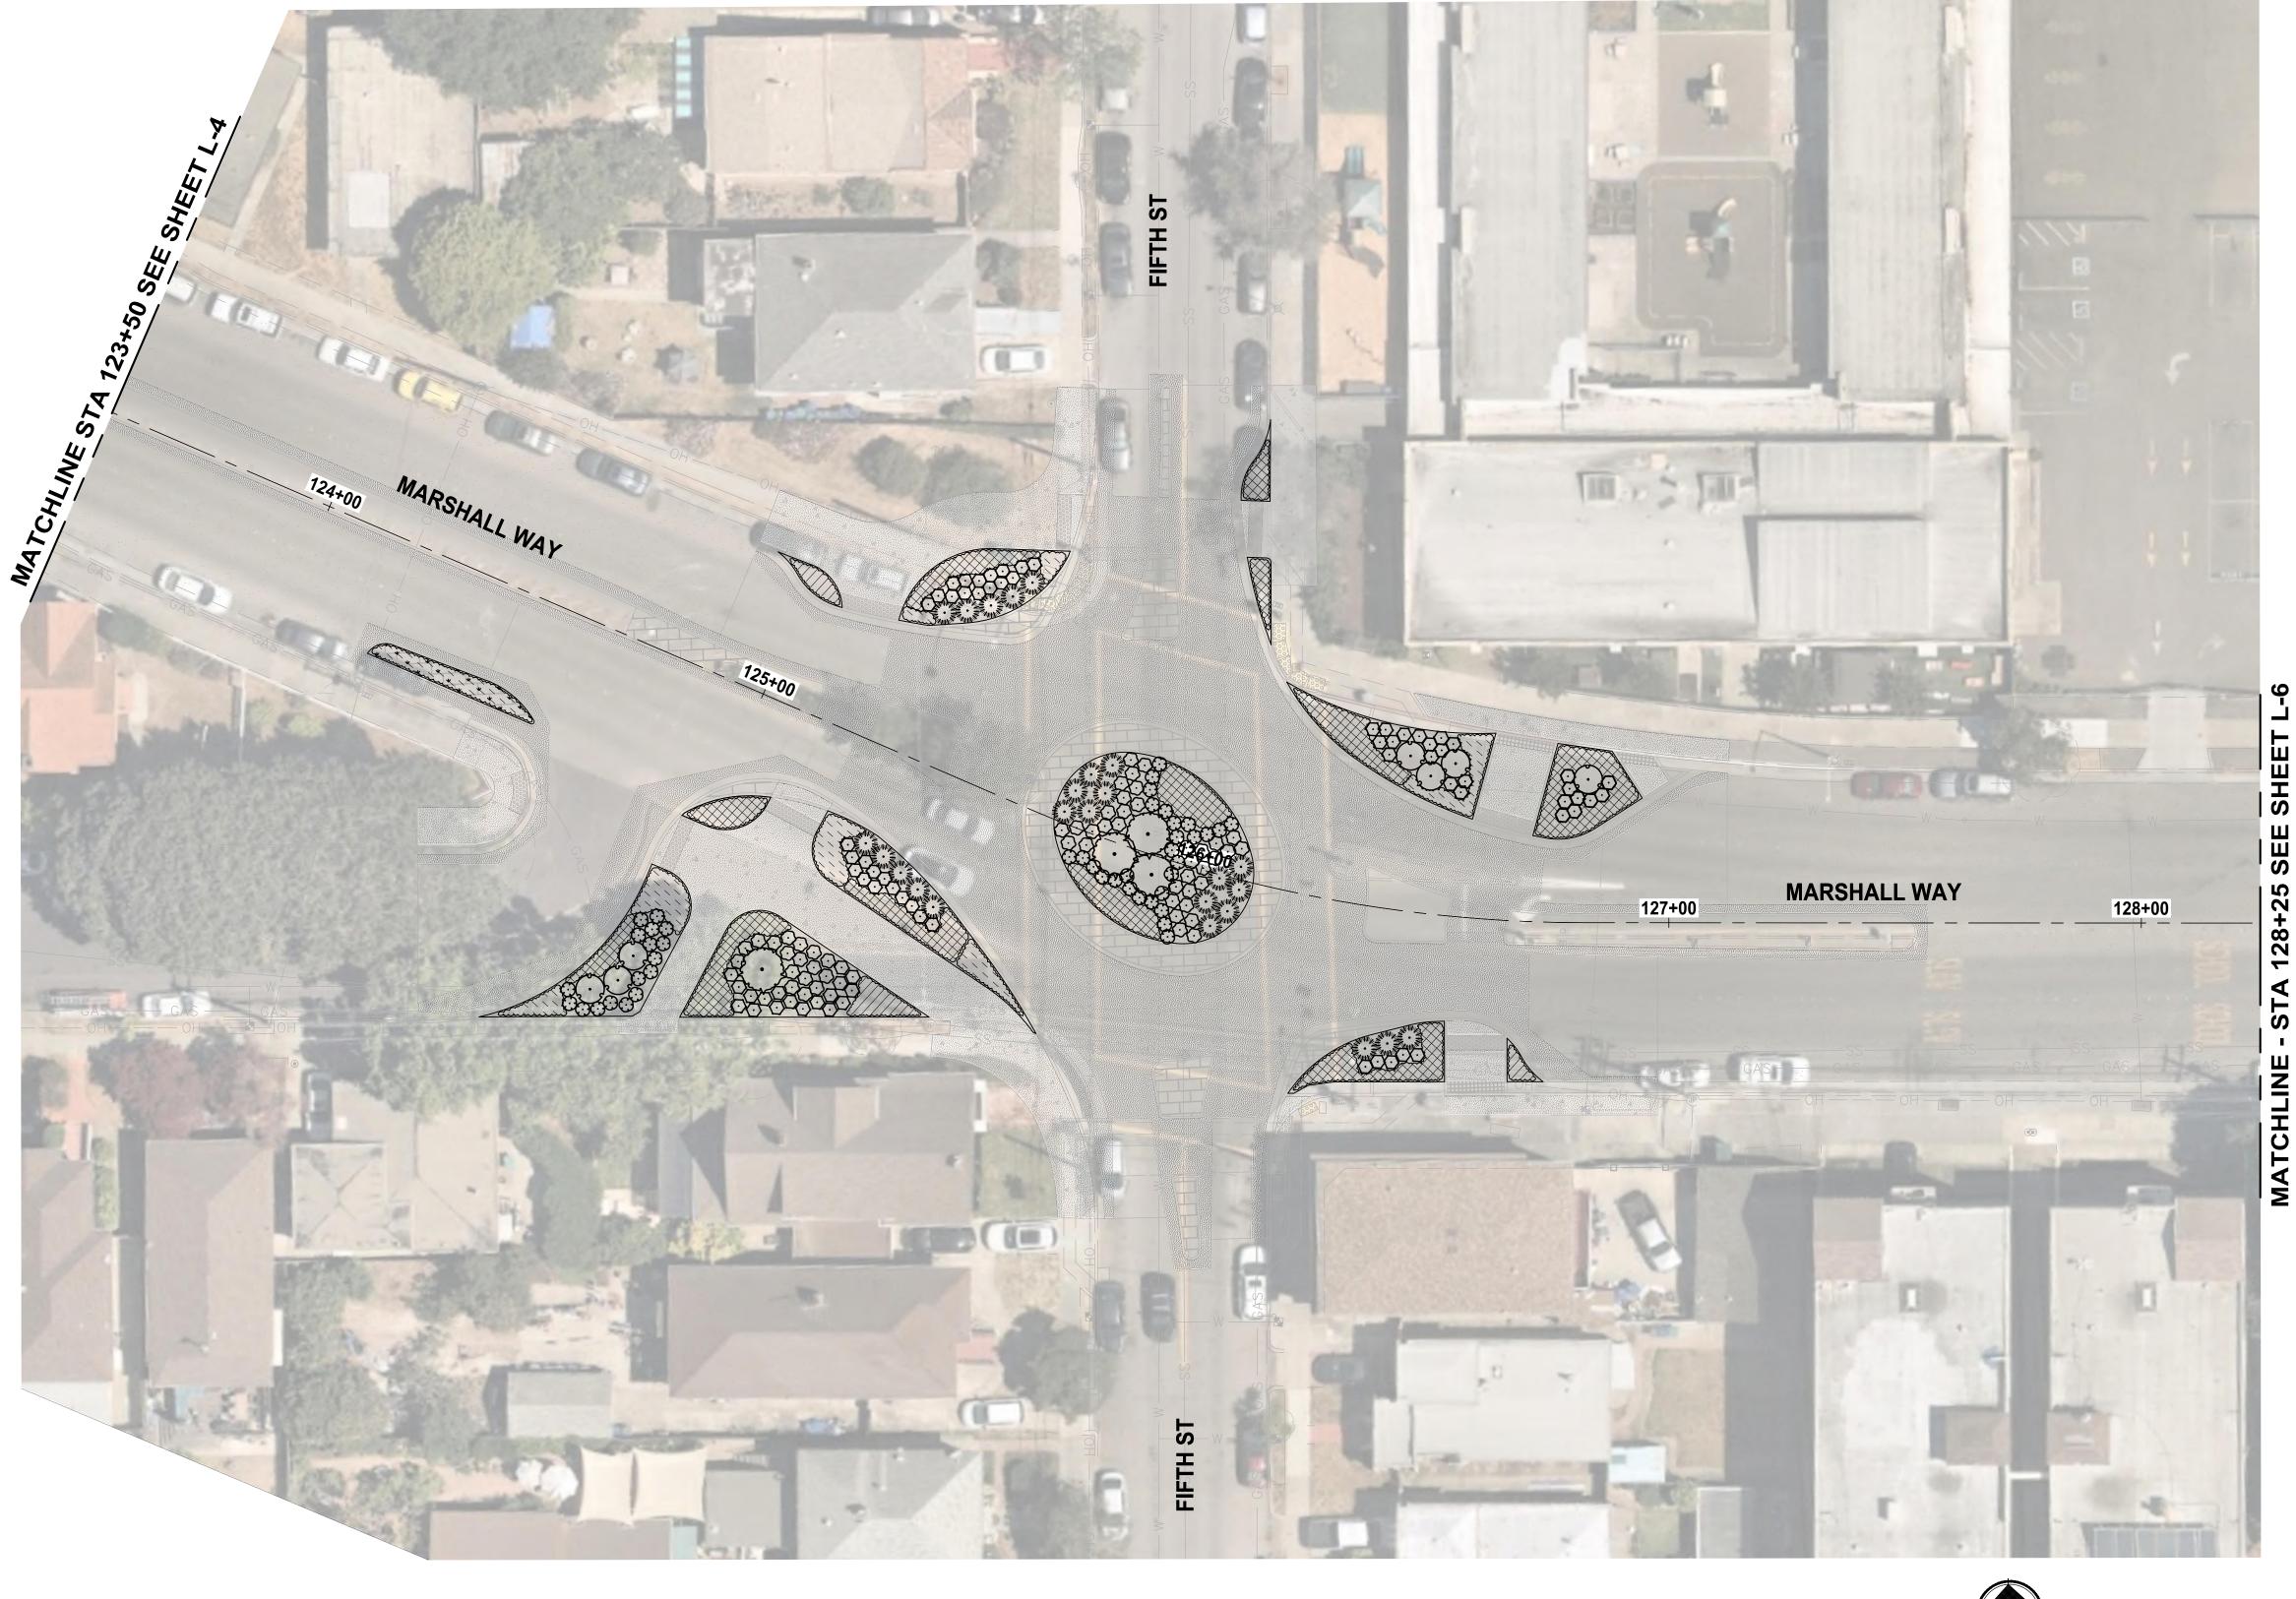
**CITY OF ALAMEDA** CORRIDOR SAFETY IMPROVEMENT PROJECT LINCOLN AVE | MARSHALL WAY | PACIFIC AVE

LANDSCAPE PLAN

243 OF 262

**L-4** 

ONE INCH AT FULL SCALE.
IF NOT, SCALE ACCORDINGLY



- 1. REFER TO SHEET L-23 FOR LANDSCAPE CONSTRUCTION NOTES, DETAILS, AND PLANT SCHEULE.
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- 3. ALL AREAS DISTURBED BY CONSTRUCTION SHALL BE RESTORED.

## **LEGEND & ABBREVIATIONS**

OCTORED	<b>GLORY RED</b>	
OCTOBER	GLOIN I INLU	

RED FLOWERING GUM

STERLING SILVER LINDEN

ACCOLADE ELM

ORCHID ROSE

• SAGELEAF ROCKROSE

YANKEE POINT CARMEL CREEPER

STICKY MONKEYFLOWER

FORTNIGHT LILY

WHITE PACIFIC COAST IRIS

] ISLAND MALLOW

DEER GRASS

**HUMMINGBIRD SAGE** 

CLEVELAND SAGE


FOOTHILL SEDGE

SMALL CAPE RUSH

BEACH STRAWBERRY

SPREADING RUSH

LOW HORIZON COAST ROSEMARY

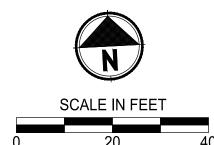

65 % REVIEW SUBMITTAL

NOT FOR CONSTRUCTION

244 OF 262

REVISIONS	DATE	BY	DESIGNED DSB
			DRAWN DSB
			CHECKED DCS
			APPROVED


ONE INCH AT FULL SCALE. IF NOT, SCALE ACCORDINGLY
FILE NAME SF8939003C-LS JOB No. C65700
DATE 06/2025

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CITY OF ALAMEDA CORRIDOR SAFETY IMPROVEMENT PROJECT LINCOLN AVE | MARSHALL WAY | PACIFIC AVE

LANDSCAPE PLAN



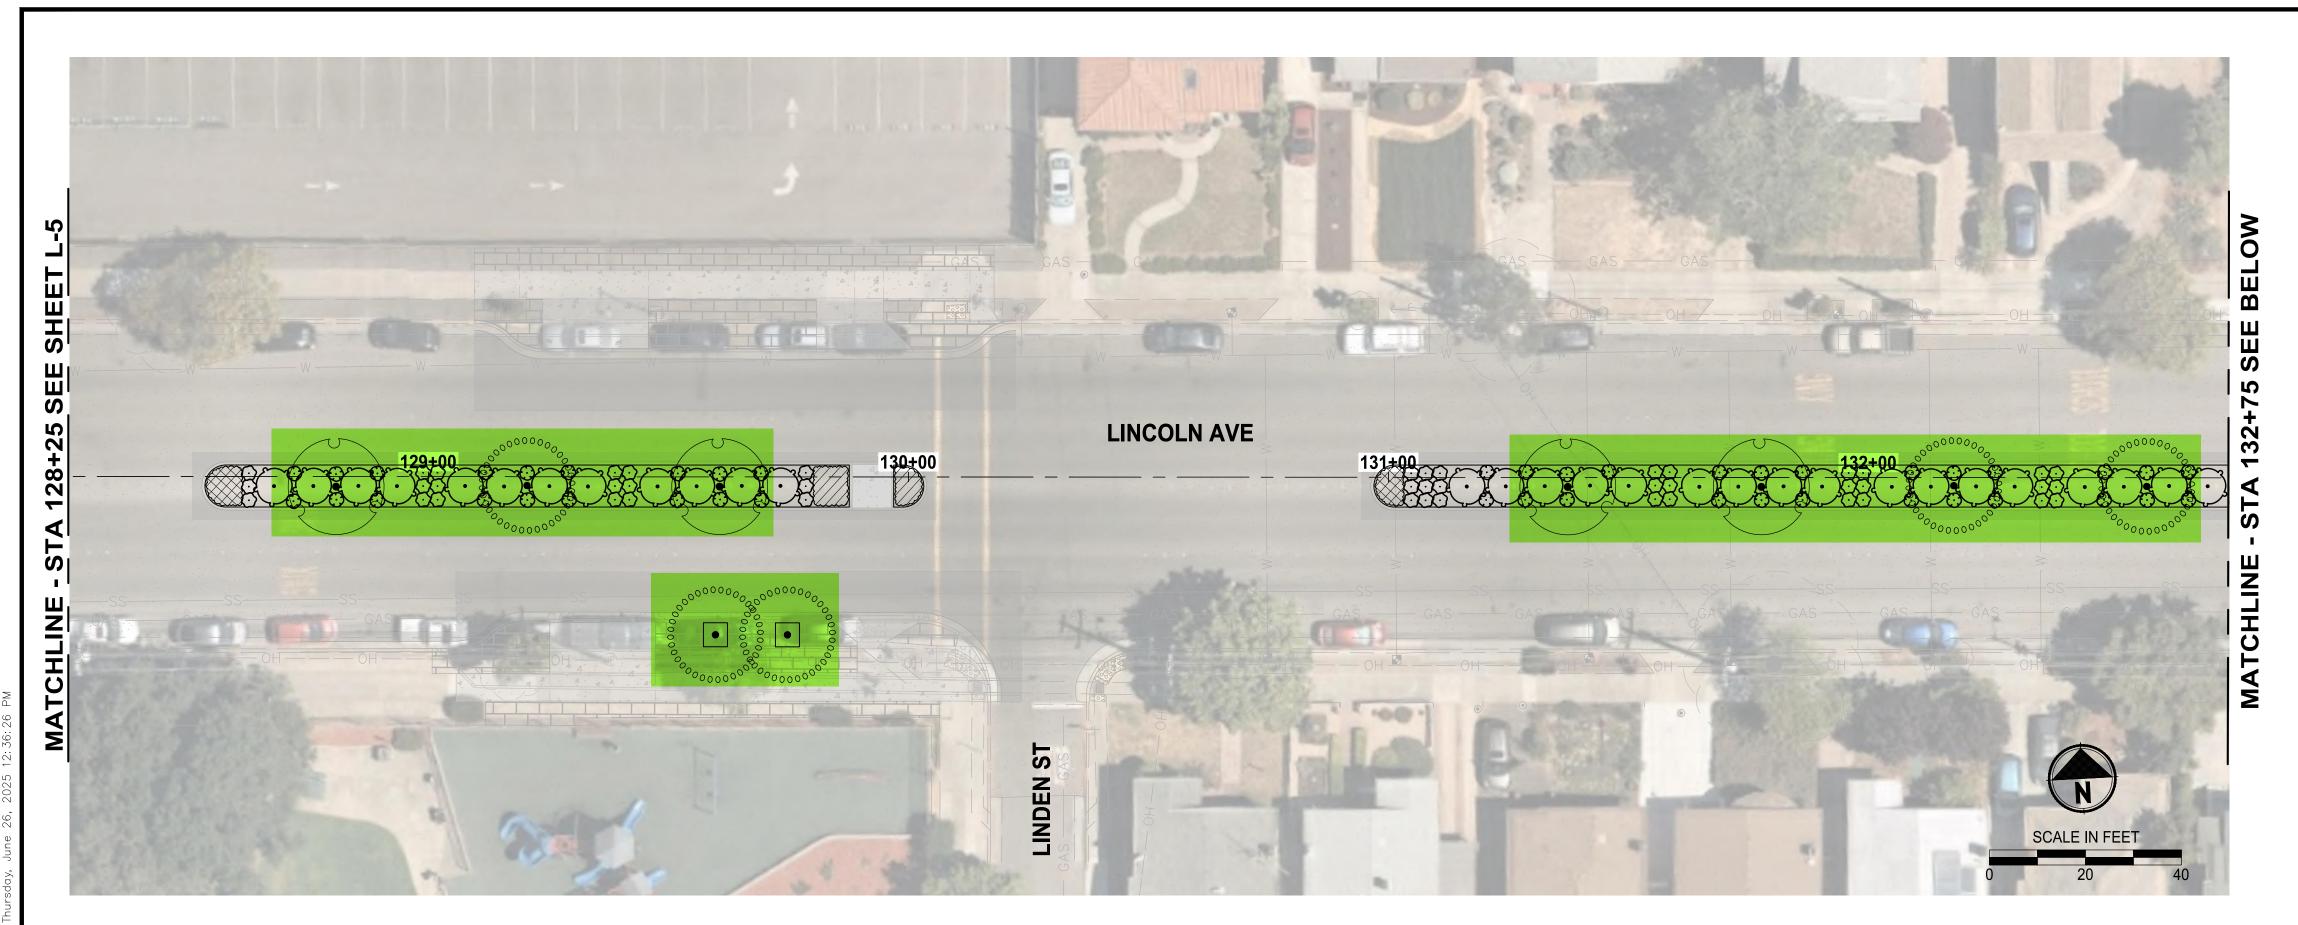

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EGEND &	ABBREVIATIONS
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	RED FLOWERING GUM
	STERLING SILVER LINDEN
00000000000000000000000000000000000000	ACCOLADE ELM
	ORCHID ROSE
•	SAGELEAF ROCKROSE
	YANKEE POINT CARMEL CREEPER
	STICKY MONKEYFLOWER
	FORTNIGHT LILY
	WHITE PACIFIC COAST IRIS
And the second	ISLAND MALLOW
•	DEER GRASS
	HUMMINGBIRD SAGE
•	CLEVELAND SAGE
	FOOTHILL SEDGE
	SMALL CAPE RUSH
	BEACH STRAWBERRY

LOW HORIZON COAST ROSEMARY

SPREADING RUSH

65 % REVIEW SUBMITTAL

DESIGNED DSB DRAWN DSB CHECKED DCS REVISIONS

APPROVED DP

ONE INCH AT FULL SCALE. IF NOT, SCALE ACCORDINGLY


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CITY OF ALAMEDA
CORRIDOR SAFETY IMPROVEMENT PROJECT LINCOLN AVE | MARSHALL WAY | PACIFIC AVE NOT FOR CONSTRUCTION

245 OF 262 LANDSCAPE PLAN

1. NO LANDSCAPE IMPROVEMENTS THIS SHEET



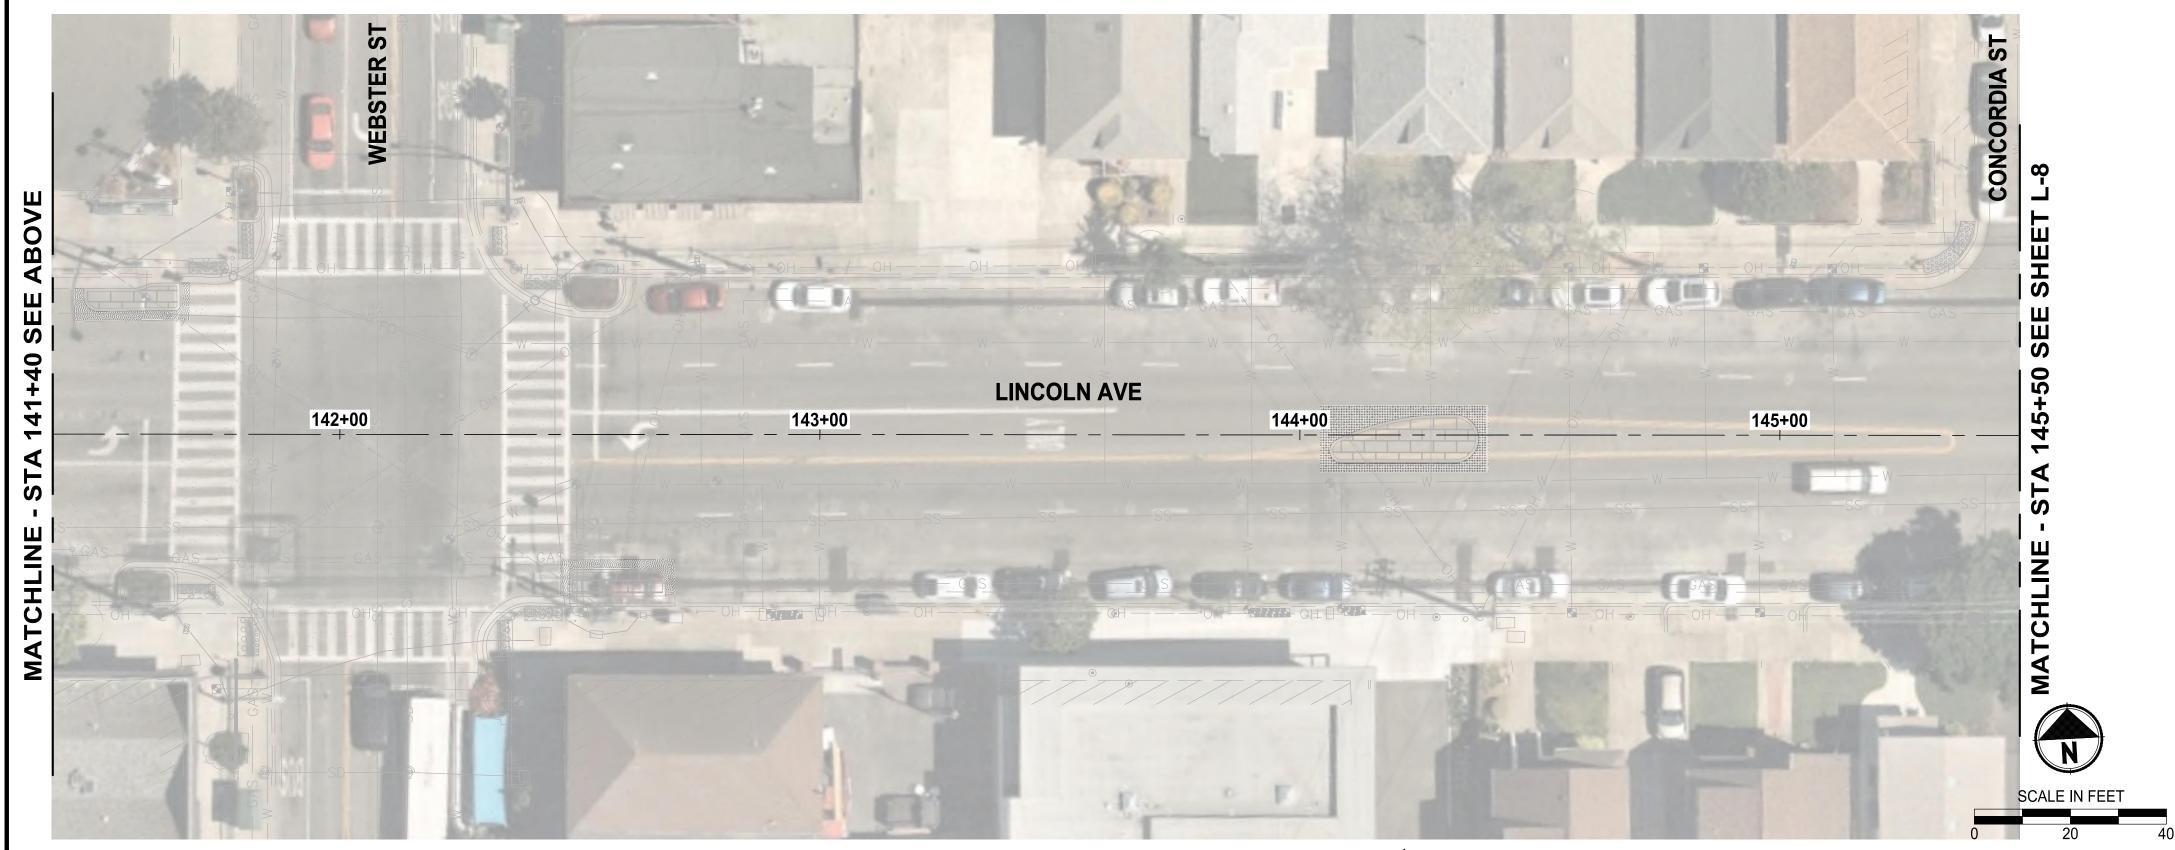

65 % REVIEW SUBMITTAL

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REVISIONS

DATE
BY
DESIGNED
DSB

DRAWN
DSB

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DCS

APPROVED
DP

ONE INCH AT FULL SCALE.
IF NOT, SCALE ACCORDINGLY

FILE NAME
SF8939003C-LS

JOB No.
C65700

DATE
06/2025

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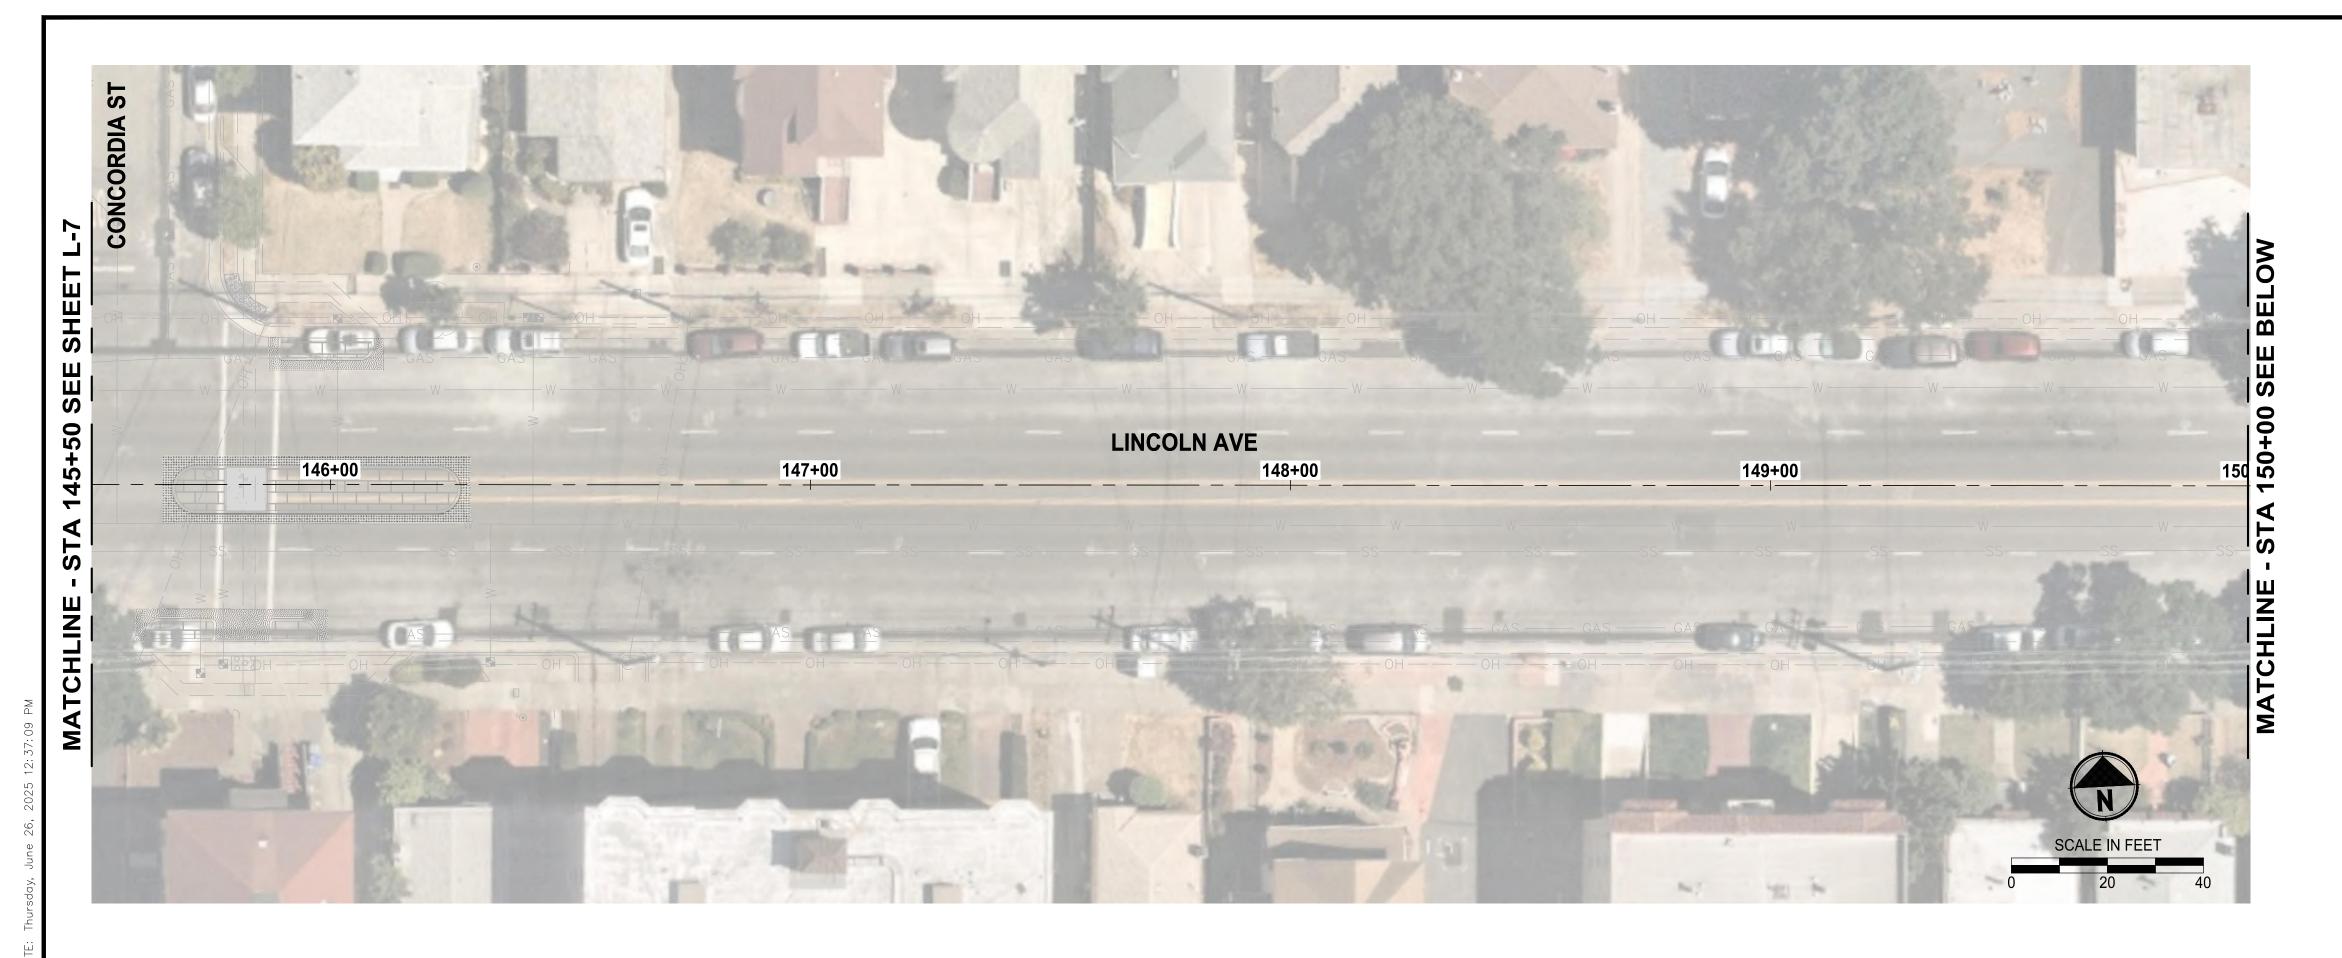
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THOUSE THE MINE				
CITY OF ALAMEDA				
<b>CORRIDOR SAFETY IMPROVEMENT PROJECT</b>				
LINCOLN AVE   MARSHALL WAY   PACIFIC A	VE			

DRAWING NO. **246 OF 262** 

1. NO LANDSCAPE IMPROVEMENTS THIS SHEET



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APPROVED DP ONE INCH AT FULL SCALE.
IF NOT, SCALE ACCORDINGLY

FILE NAME
SF8939003C-LS

JOB No.
C65700

DATE
06/2025

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PRIMITANTA


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CITY OF ALAMEDA CORRIDOR SAFETY IMPROVEMENT PROJECT LINCOLN AVE | MARSHALL WAY | PACIFIC AVE

LANDSCAPE PLAN

DRAWING NO. **247 OF 262** 

1. NO LANDSCAPE IMPROVEMENTS THIS SHEET

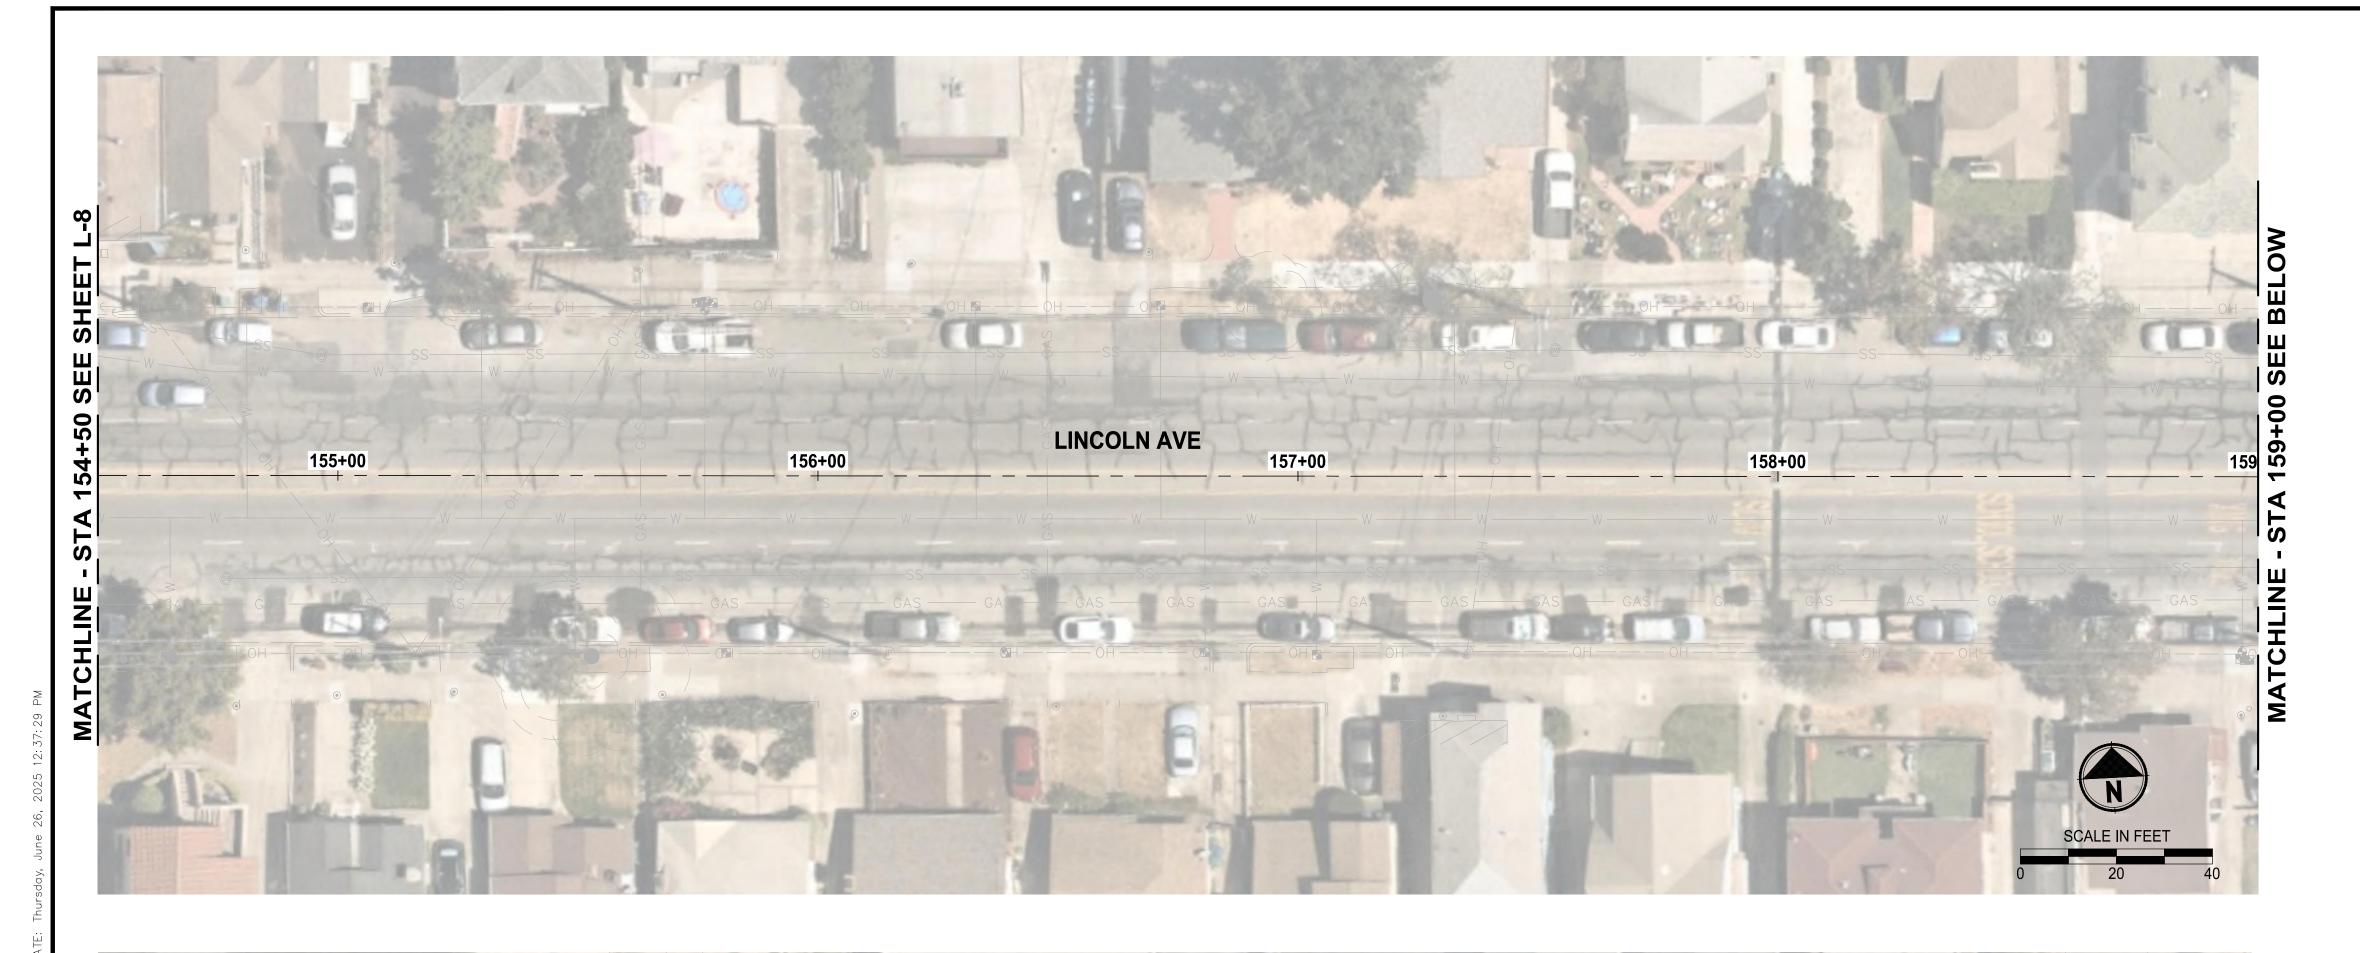

159+00 SEE ABOVE SEE 163+50 LINCOLN AVE 160+00 163+00 161+00 162+00 MATCHLINE SCALE IN FEET

ONE INCH AT FULL SCALE. IF NOT, SCALE ACCORDINGLY

DESIGNED DSB DRAWN DSB CHECKED DCS

APPROVED DP

REVISIONS

65 % REVIEW SUBMITTAL NOT FOR CONSTRUCTION


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CITY OF ALAMEDA CORRIDOR SAFETY IMPROVEMENT PROJECT LINCOLN AVE | MARSHALL WAY | PACIFIC AVE

LANDSCAPE PLAN

248 OF 262

1. NO LANDSCAPE IMPROVEMENTS THIS SHEET

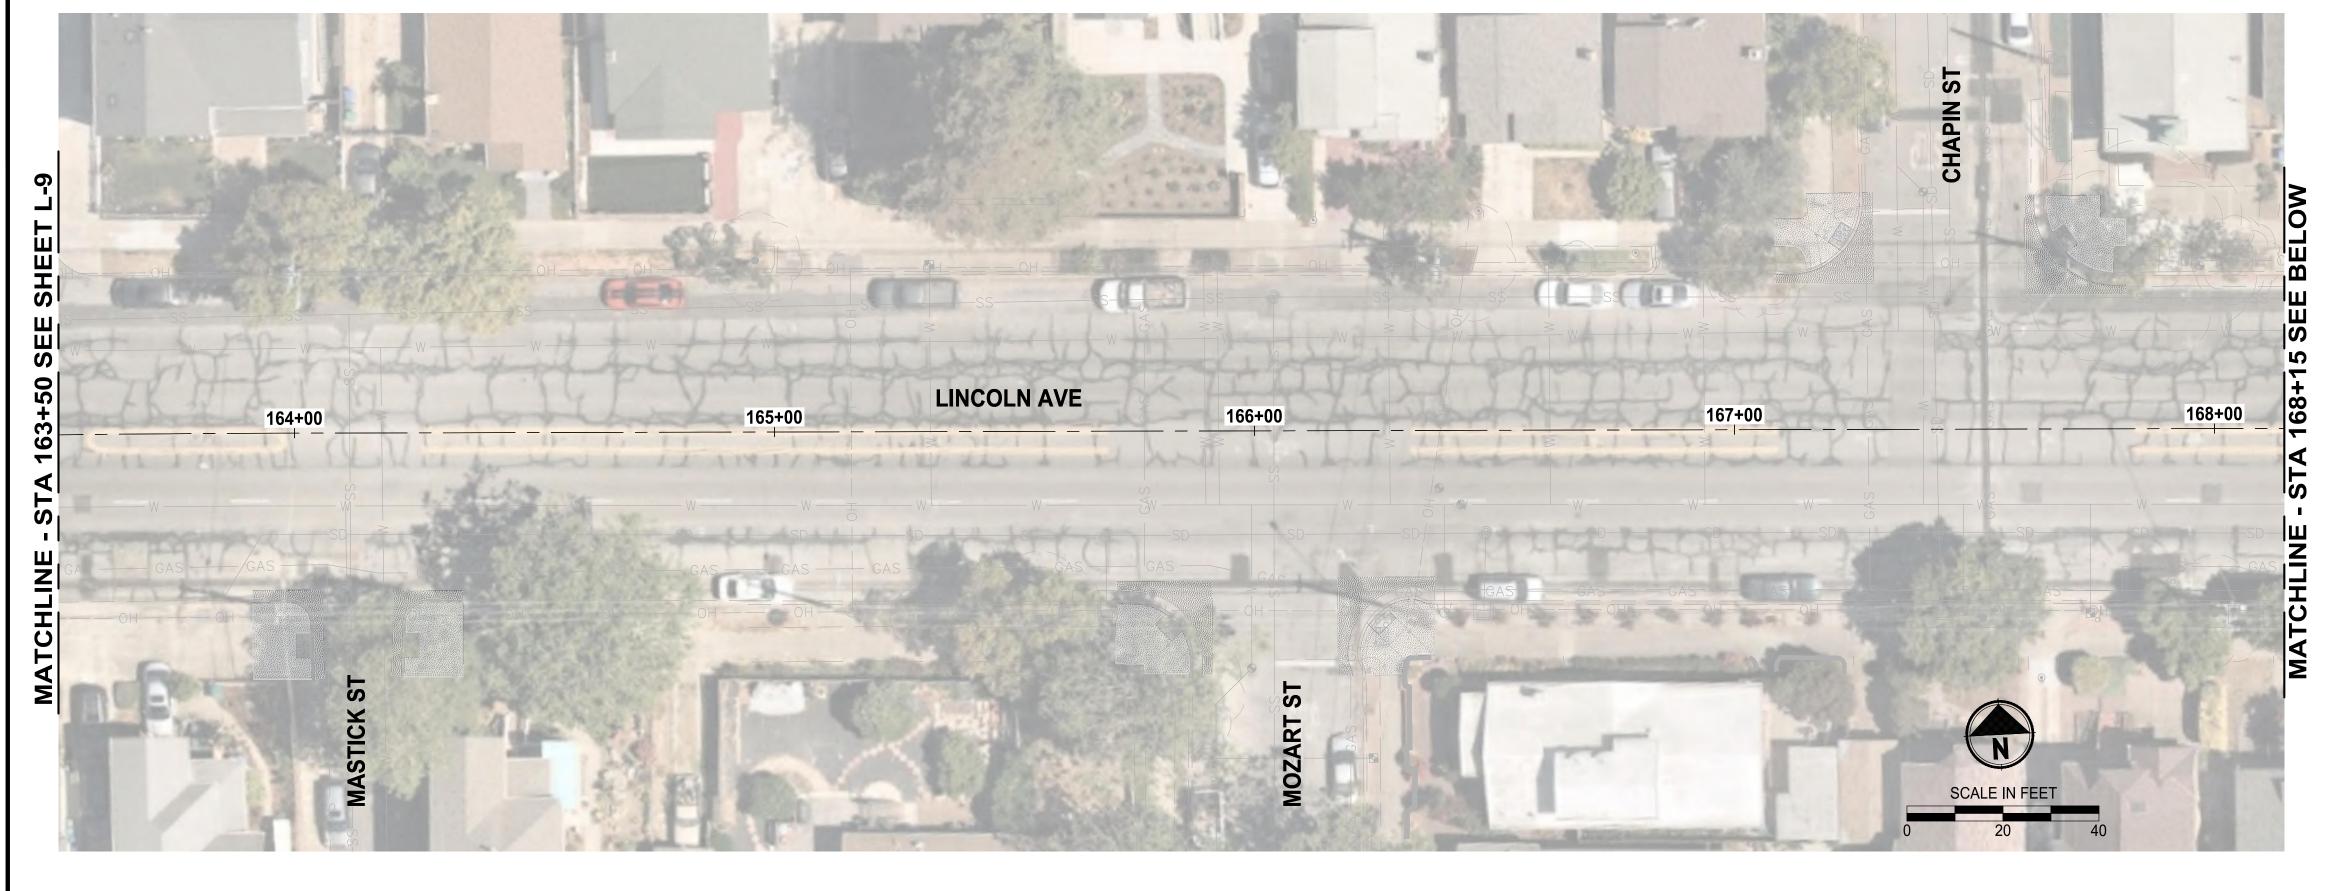

SHEET LINCOLN AVE 172+00 171+00 169+00 VERDI ST

65 % REVIEW SUBMITTAL NOT FOR CONSTRUCTION

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LANDSCAPE PLAN

249 OF 262

L-10

_	REVISIONS	DATE	BY	DSB
				DRAWN
				DSB CHECKED
				DCS
				APPROVED DP

ONE INCH AT FULL SCALE. IF NOT, SCALE ACCORDINGLY

CITY OF ALAMEDA CORRIDOR SAFETY IMPROVEMENT PROJECT LINCOLN AVE | MARSHALL WAY | PACIFIC AVE





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#### I FGEND & ARREVIATIONS

LEGEND &	ABBREVIATIONS
$\bigcirc$	OCTOBER GLORY RED MAPLE
	RED FLOWERING GUM
	STERLING SILVER LINDEN
00000000000000000000000000000000000000	ACCOLADE ELM
	ORCHID ROSE
	SAGELEAF ROCKROSE
	YANKEE POINT CARMEL CREEPER
	STICKY MONKEYFLOWER
	FORTNIGHT LILY
	WHITE PACIFIC COAST IRIS
	ISLAND MALLOW
$\langle \cdot \rangle$	DEER GRASS
	HUMMINGBIRD SAGE
lacksquare	CLEVELAND SAGE
	FOOTHILL SEDGE
	SMALL CAPE RUSH
	BEACH STRAWBERRY

SPREADING RUSH

LOW HORIZON COAST ROSEMARY

65 % REVIEW SUBMITTAL

L-11

NOT FOR CONSTRUCTION

250 OF 262

LANDSCAPE PLAN


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				CHECKED DCS
4 Y U				APPROVED DP

ONE INCH AT FULL SCALE. IF NOT, SCALE ACCORDINGLY

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CITY OF ALAMEDA CORRIDOR SAFETY IMPROVEMENT PROJECT LINCOLN AVE | MARSHALL WAY | PACIFIC AVE

1. NO LANDSCAPE IMPROVEMENTS THIS SHEET

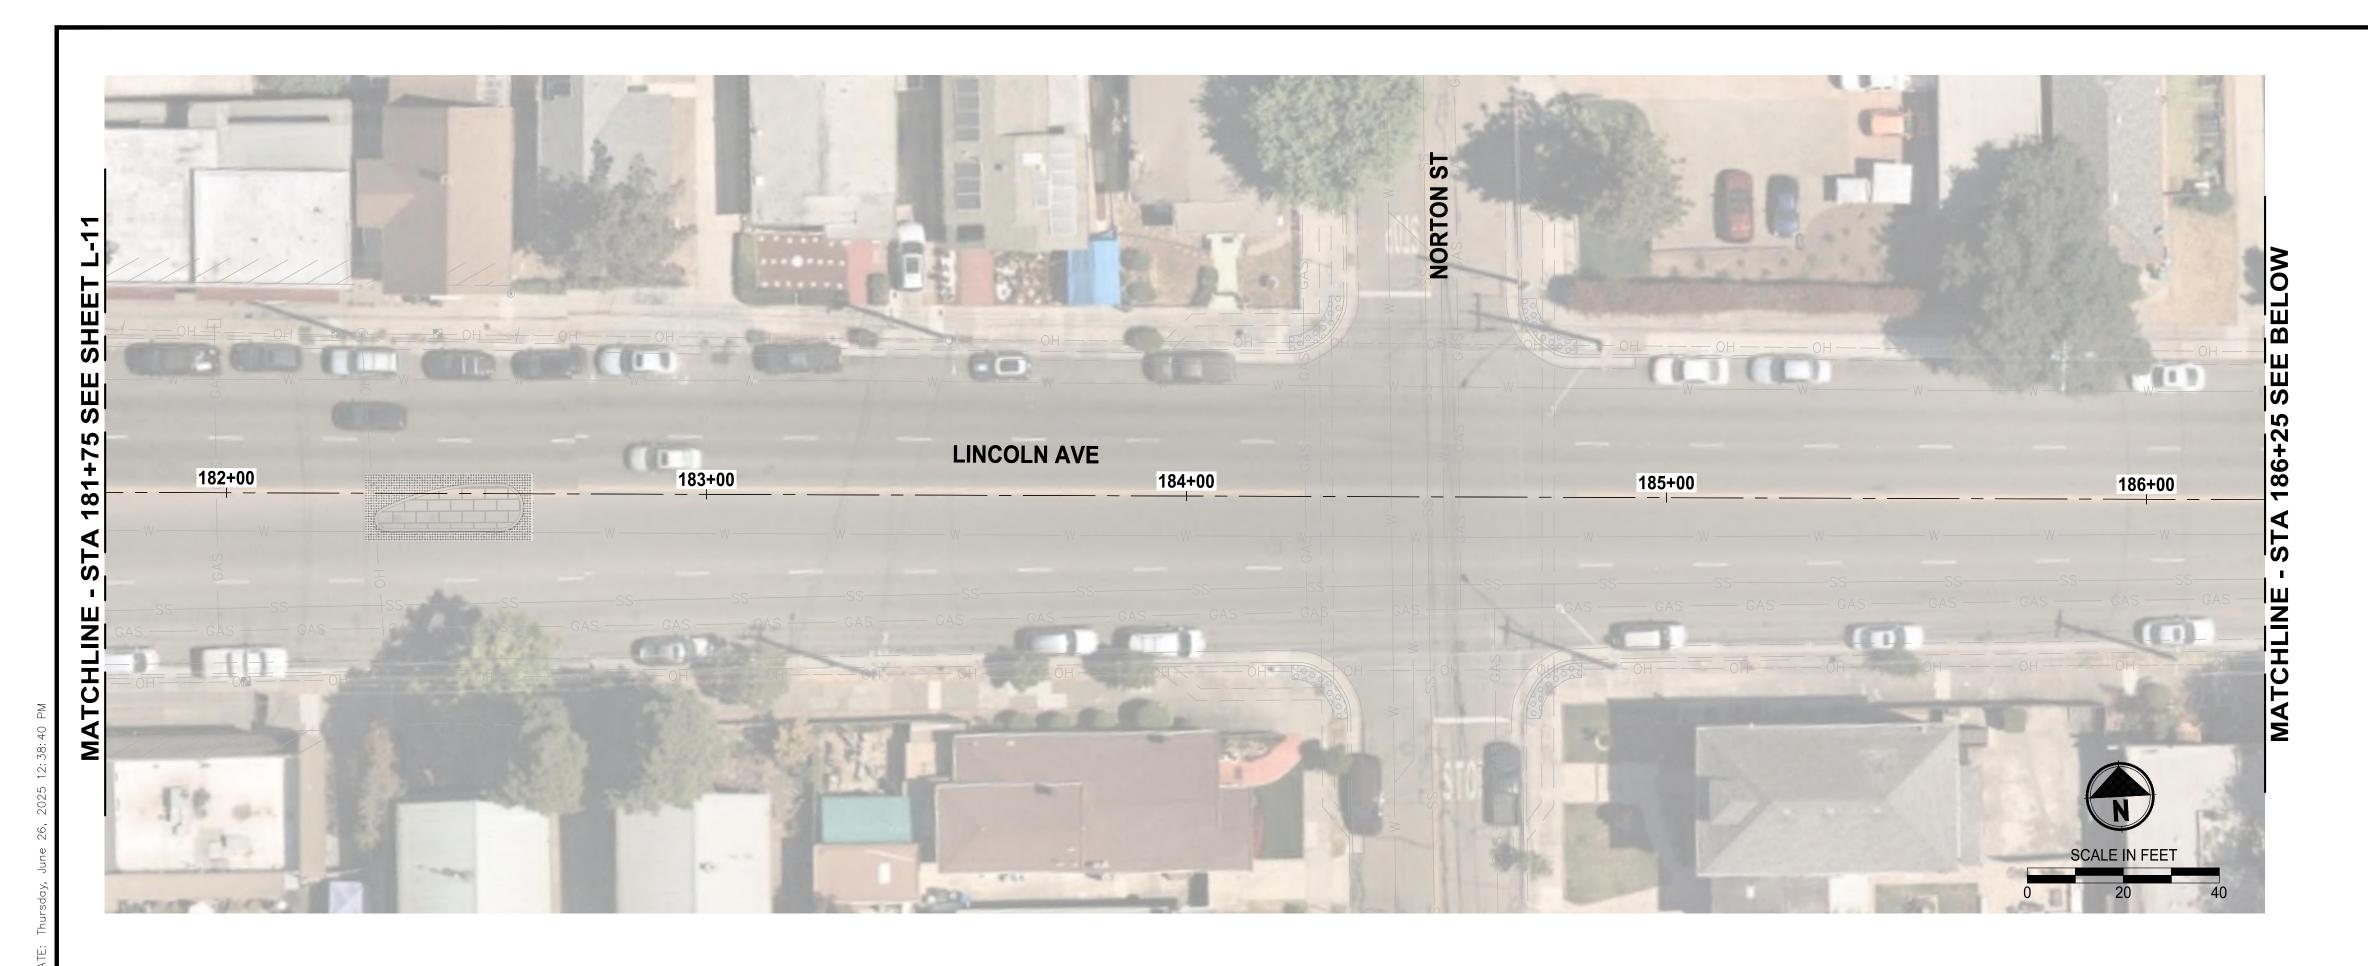

STA 186+25 SEE ABOVE	OHOHOHOHOHOH	LINCOLN AVE  188+00	189+00 189+00	MEL 1-13
MATCHLINE - S  GAS  GAS  GAS  GAS  GAS  GAS  GAS  G	SS—— SS—— SS—— GAS —— GAS —— GAS —— OH —— OH —— OH ——	SS—— SS—— SS—— GAS—— GAS	GASS GAS GAS GAS GAS GAS GAS GAS GAS GAS	190+00  WALCHLINE SCALE IN FEET  0 20 40

65 % REVIEW SUBMITTAL

NOT FOR CONSTRUCTION

ONE INCH AT FULL SCALE.
IF NOT, SCALE ACCORDINGLY

FILE NAME
SF8939003C-LS

JOB No.
C65700

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CITY OF ALAMEDA
CORRIDOR SAFETY IMPROVEMENT PROJECT
LINCOLN AVE | MARSHALL WAY | PACIFIC AVE

LANDSCAPE PLAN

DRAWING NO. **251 OF 262** 

1. NO LANDSCAPE IMPROVEMENTS THIS SHEET





65 % REVIEW SUBMITTAL

NOT FOR CONSTRUCTION

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DESIGNED DSB	
DRAWN DSB	
CHECKED DCS	
APPROVED DP	

REVISIONS

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IF NOT, SCALE ACCORDINGLY

FILE NAME
SF8939003C-LS

JOB No.
C65700

DATE
06/2025

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CITY OF ALAMEDA CORRIDOR SAFETY IMPROVEMENT PROJECT LINCOLN AVE | MARSHALL WAY | PACIFIC AVE


PROJECT NAME

LANDSCAPE PLAN

DRAWING NO. 252 OF 262

1. NO LANDSCAPE IMPROVEMENTS THIS SHEET



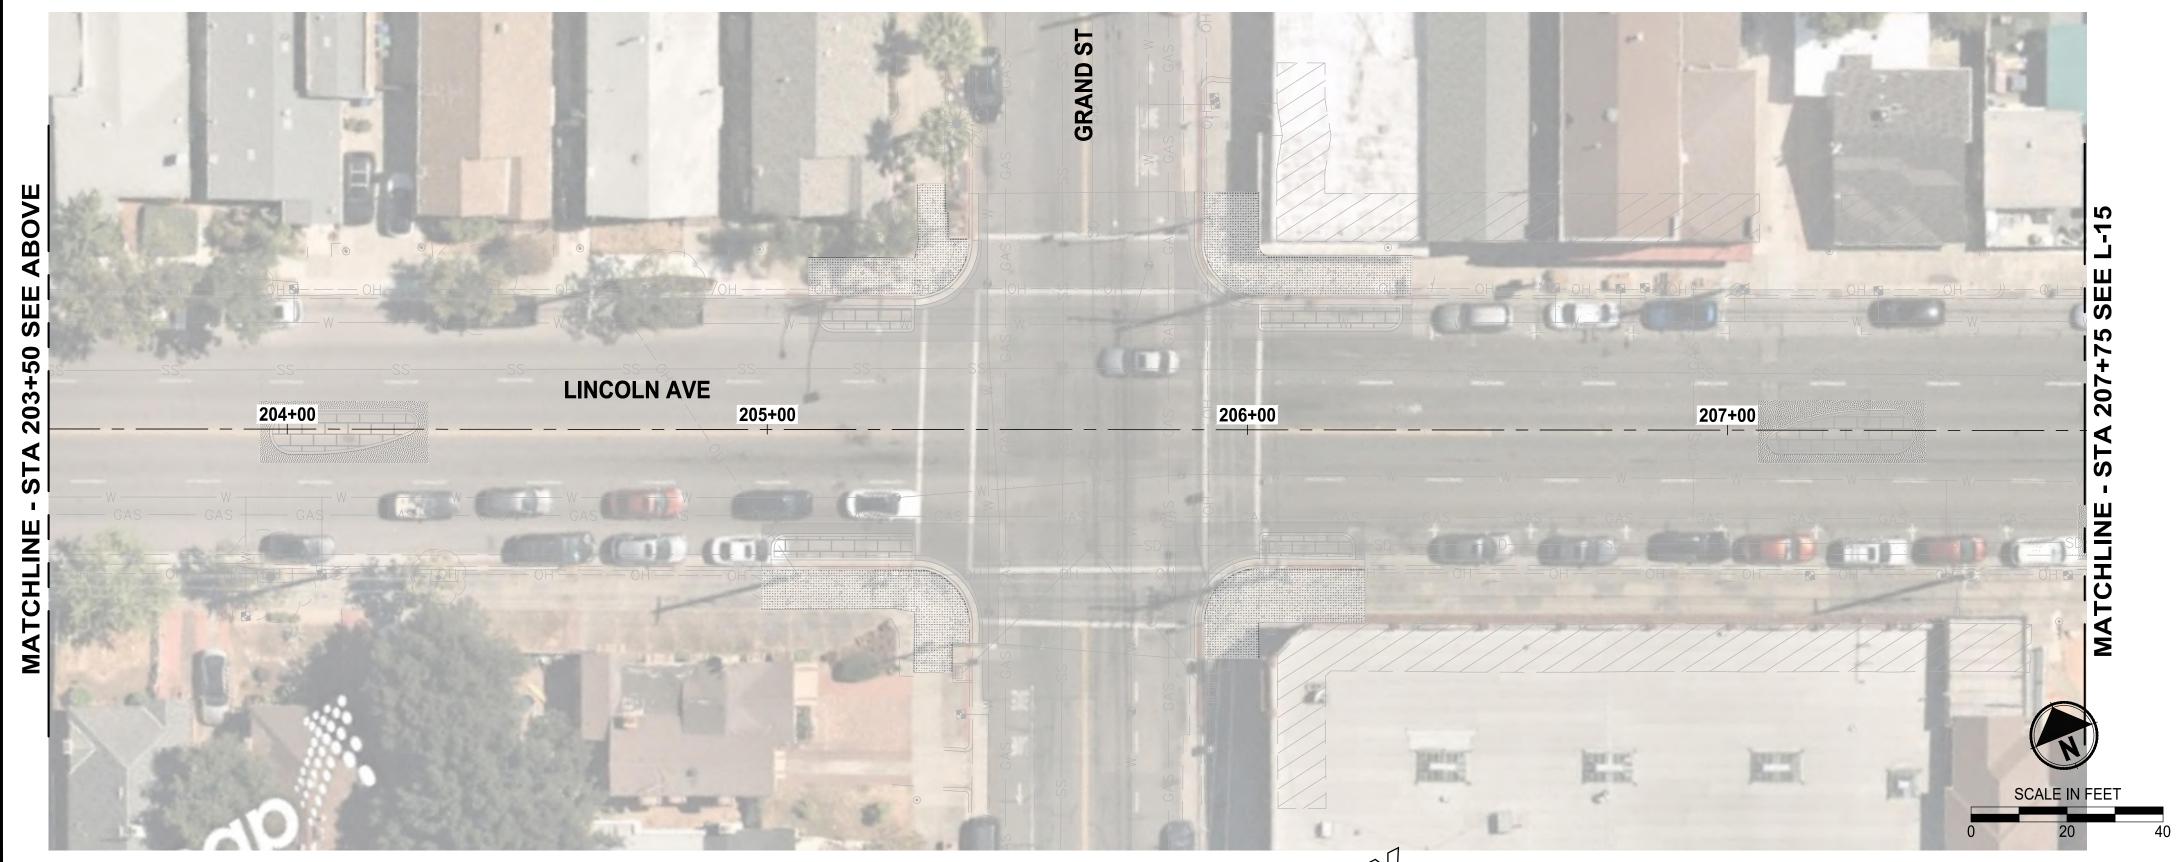

65 % REVIEW SUBMITTAL

NOT FOR CONSTRUCTION

REVISIONS

DATE
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DSB

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APPROVED
DP

ONE INCH AT FULL SCALE.
IF NOT, SCALE ACCORDINGLY

FILE NAME
SF8939003C-LS

JOB No.
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DATE
06/2025


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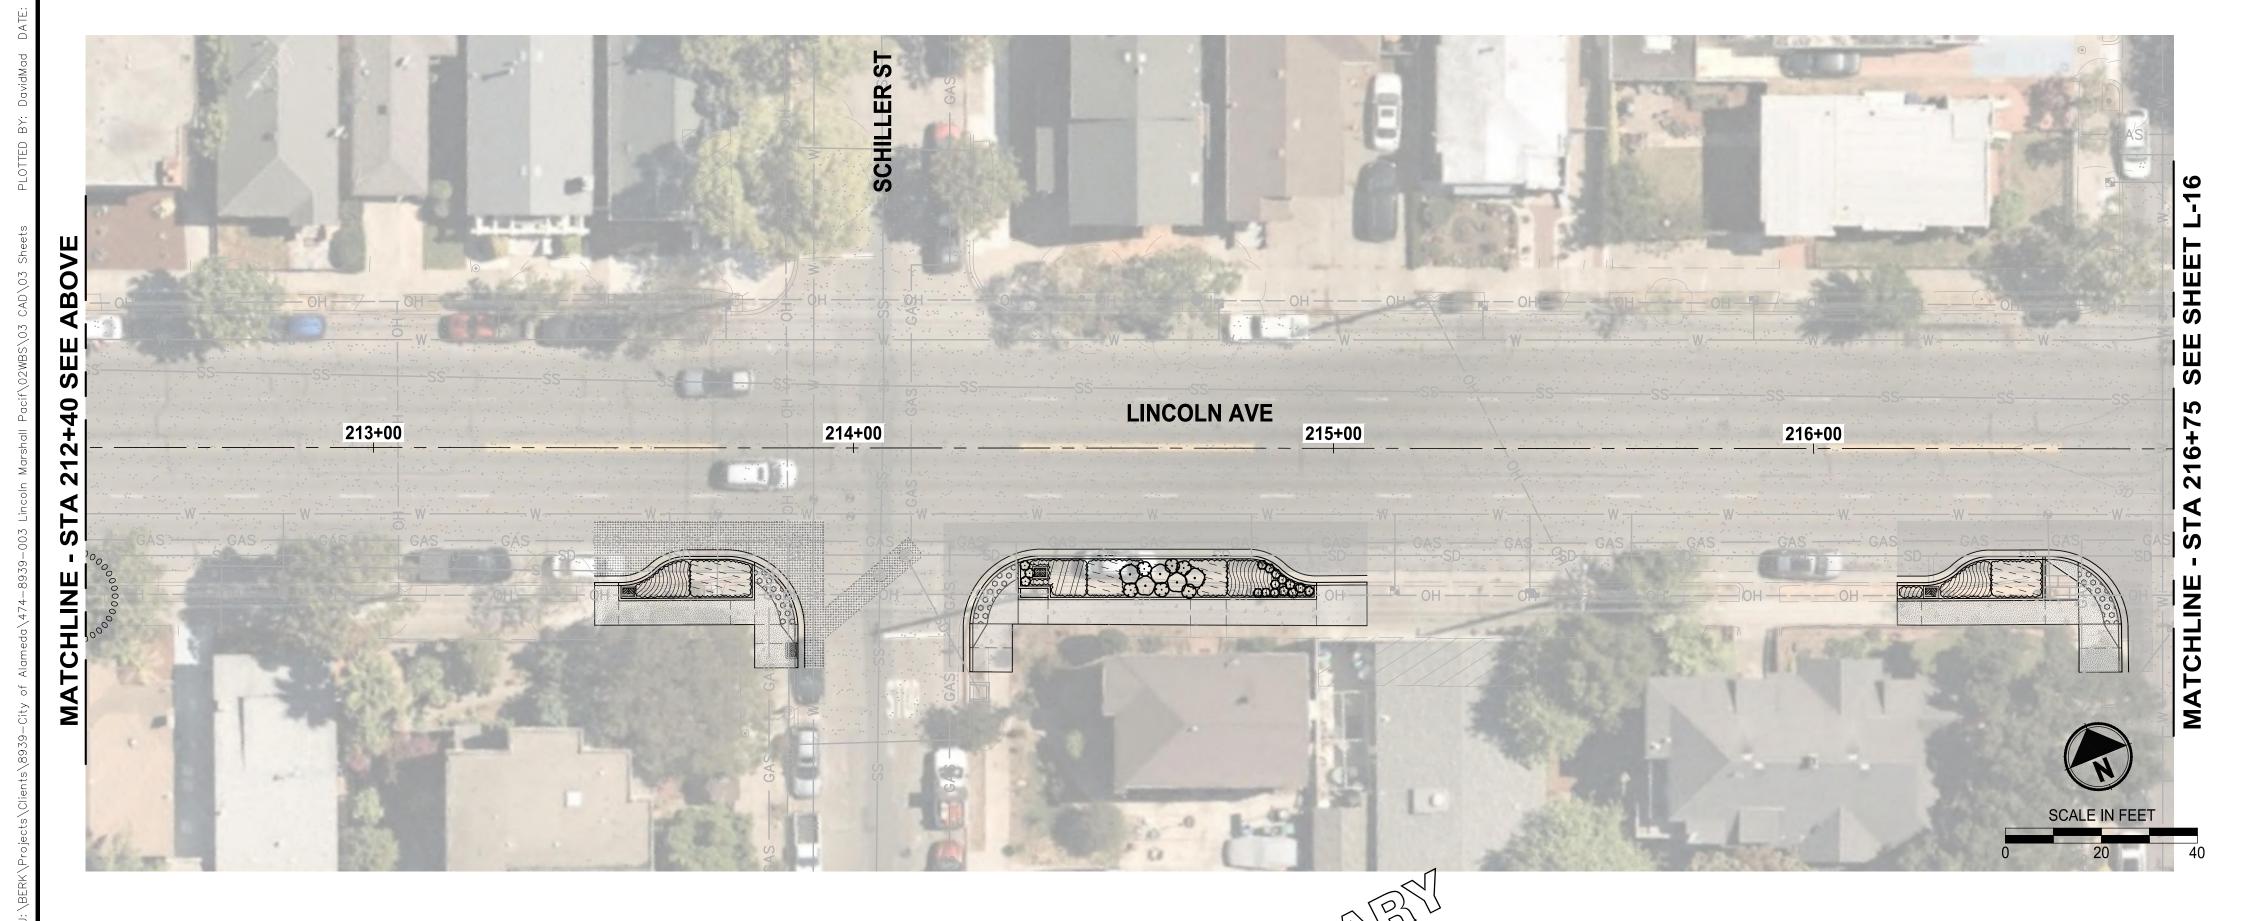
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P 510.343.6400
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CITY OF ALAMEDA CORRIDOR SAFETY IMPROVEMENT PROJECT LINCOLN AVE | MARSHALL WAY | PACIFIC AVE

LANDSCAPE PLAN

DRAWING NO. 253 OF 262



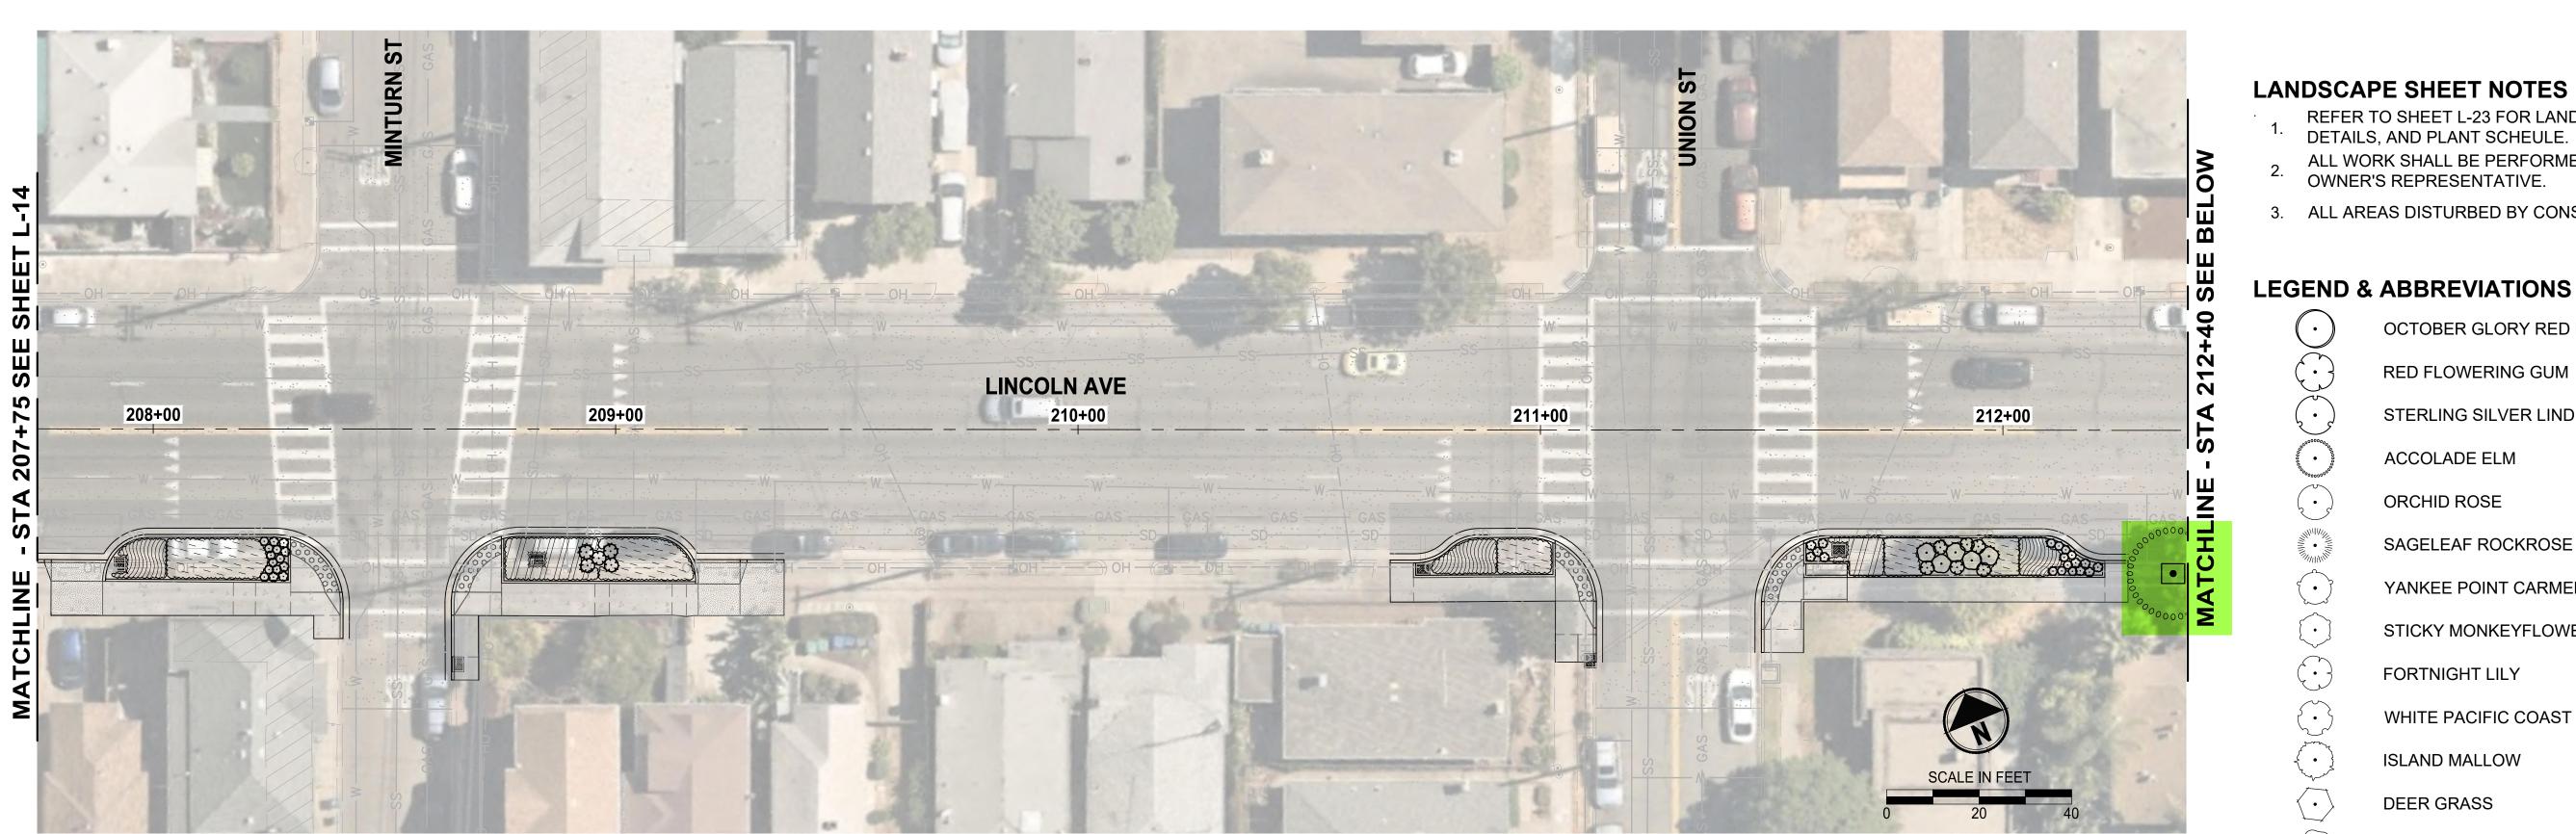

- REFER TO SHEET L-23 FOR LANDSCAPE CONSTRUCTION NOTES, DETAILS, AND PLANT SCHEULE.
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#### **LEGEND & ABBREVIATIONS**

OCTOBER GLORY RED MAPLE RED FLOWERING GUM

STERLING SILVER LINDEN

ACCOLADE ELM ORCHID ROSE

SAGELEAF ROCKROSE

YANKEE POINT CARMEL CREEPER

STICKY MONKEYFLOWER

FORTNIGHT LILY

WHITE PACIFIC COAST IRIS

ISLAND MALLOW

DEER GRASS **HUMMINGBIRD SAGE** 

**CLEVELAND SAGE** 

FOOTHILL SEDGE

SMALL CAPE RUSH

**BEACH STRAWBERRY** 

SPREADING RUSH LOW HORIZON COAST ROSEMARY

> 65 % REVIEW SUBMITTAL NOT FOR CONSTRUCTION

> > 254 OF 262

L-15

LANDSCAPE PLAN

DESIGNED DSB DRAWN DSB REVISIONS CHECKED DCS APPROVED DP

ONE INCH AT FULL SCALE. IF NOT, SCALE ACCORDINGLY

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**CITY OF ALAMEDA** CORRIDOR SAFETY IMPROVEMENT PROJECT LINCOLN AVE | MARSHALL WAY | PACIFIC AVE

1. NO LANDSCAPE IMPROVEMENTS THIS SHEET



LINCOLN AVE 222+00 225+00 224+00 MATCHLINE LOVE ELEMENTARY SCHOOL

APPROVED DP

65 % REVIEW SUBMITTAL NOT FOR CONSTRUCTION


DESIGNED DSB DRAWN DSB CHECKED DCS REVISIONS Parametrix
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P 510.343.6400
WWW.PARAMETRIX.COM ONE INCH AT FULL SCALE. IF NOT, SCALE ACCORDINGLY

CITY OF ALAMEDA CORRIDOR SAFETY IMPROVEMENT PROJECT LINCOLN AVE | MARSHALL WAY | PACIFIC AVE

LANDSCAPE PLAN

255 OF 262

1. NO LANDSCAPE IMPROVEMENTS THIS SHEET

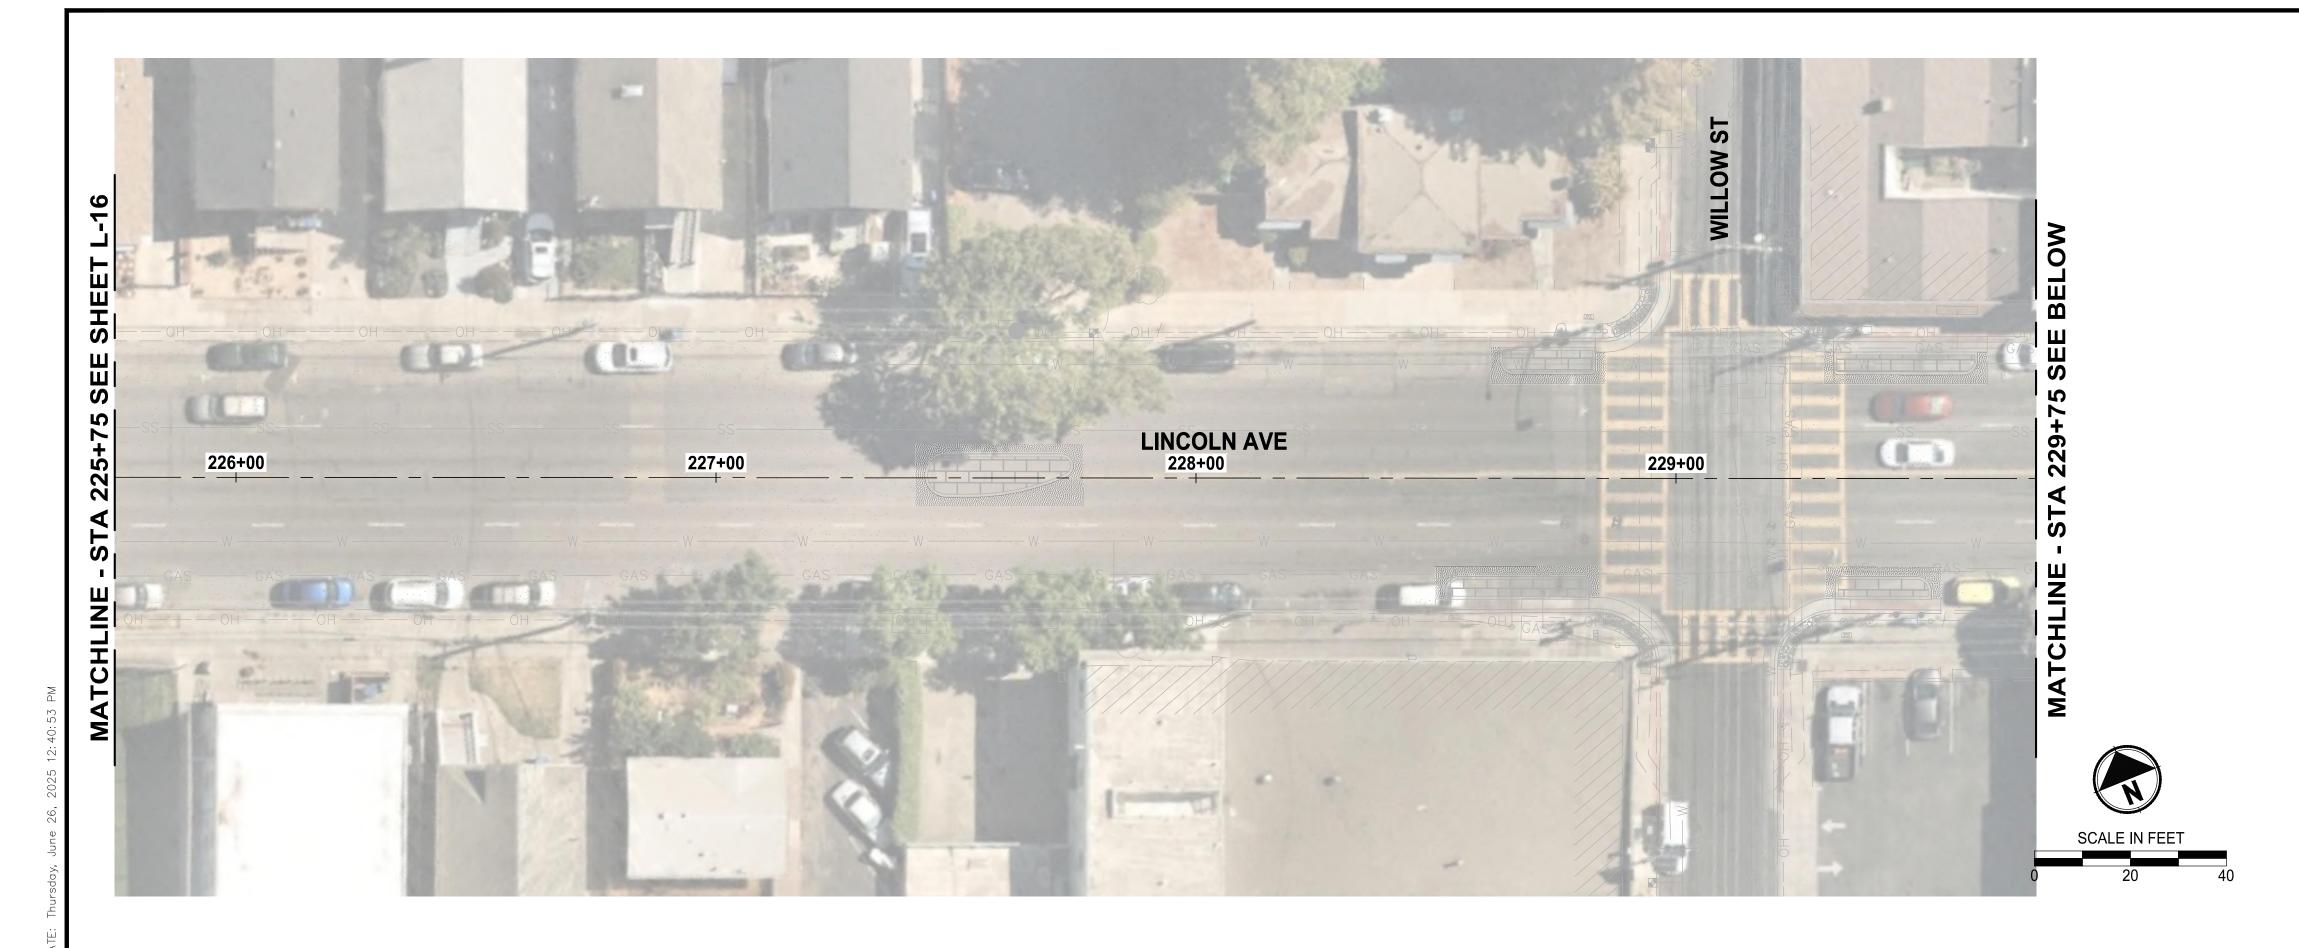

			SHEET L-18
AS	SS SS LINCOLN AVE	GAS	233+75 SEE
W GAS	W — W — W — W — W — W — GAS —	W	TCHLINE - STA
			WATC SCALE IN F

65 % REVIEW SUBMITTAL
NOT FOR CONSTRUCTION

РА	REVISIONS	DATE	BY	DESIGNED DSB
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2				APPROVED

ONE INCH AT FULL SCALE.
IF NOT, SCALE ACCORDINGLY

FILE NAME
SF8939003C-LS

JOB No.
C65700


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CITY OF ALAMEDA
CORRIDOR SAFETY IMPROVEMENT PROJECT
LINCOLN AVE | MARSHALL WAY | PACIFIC AVE

LANDSCAPE PLAN

DRAWING NO. 256 OF 262



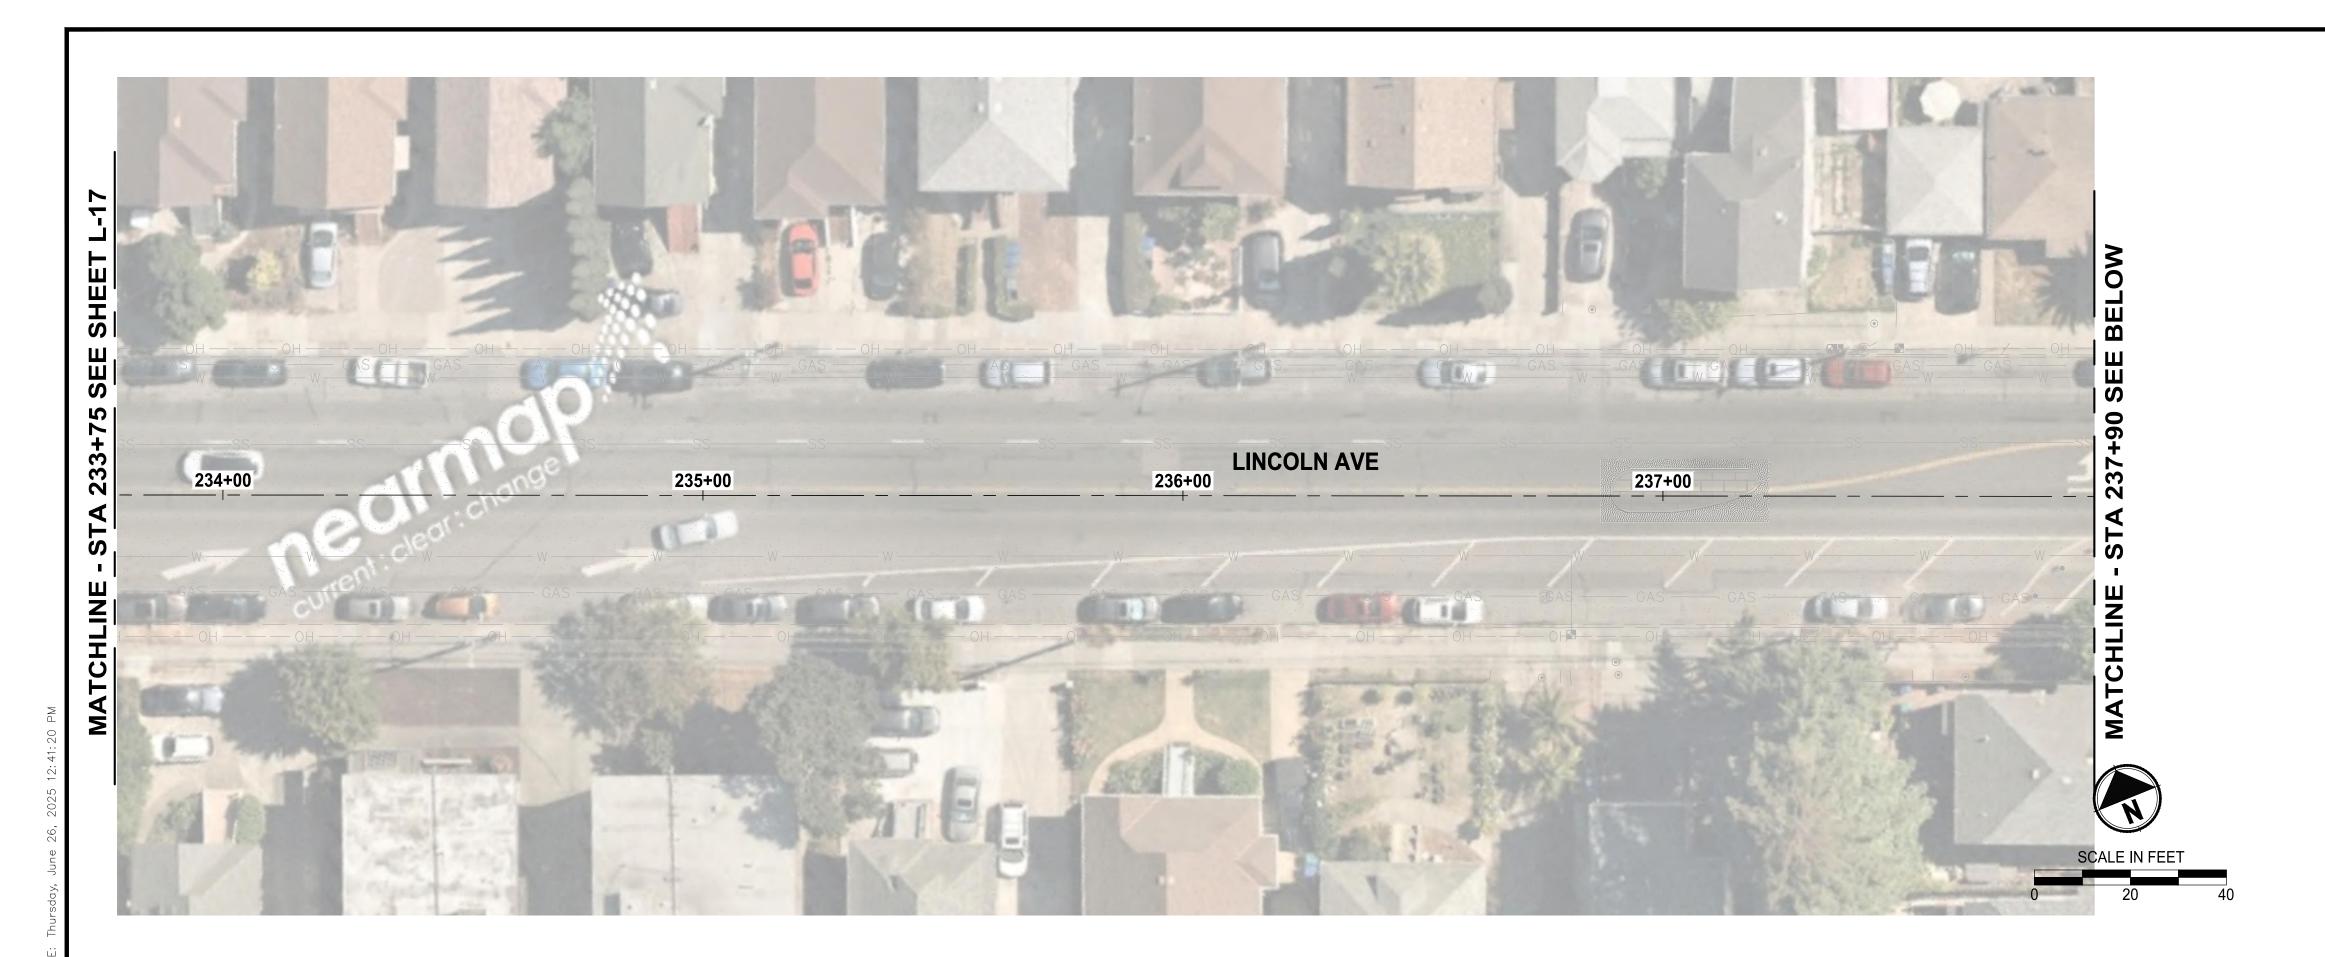

- REFER TO SHEET L-23 FOR LANDSCAPE CONSTRUCTION NOTES, DETAILS, AND PLANT SCHEULE.
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0000000000000000000000000000000000000	ACCOLADE ELM
	ORCHID ROSE
•	SAGELEAF ROCKROSE
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	FORTNIGHT LILY
	WHITE PACIFIC COAST IRIS
	ISLAND MALLOW
$\overline{\bullet}$	DEER GRASS
$\overline{\bullet}$	HUMMINGBIRD SAGE
•	CLEVELAND SAGE
	FOOTHILL SEDGE
	SMALL CAPE RUSH
	BEACH STRAWBERRY
	SPREADING RUSH
	LOW HORIZON COAST ROSEMARY

65 % REVIEW SUBMITTAL

DESIGNED DSB DRAWN DSB CHECKED DCS REVISIONS

APPROVED DP


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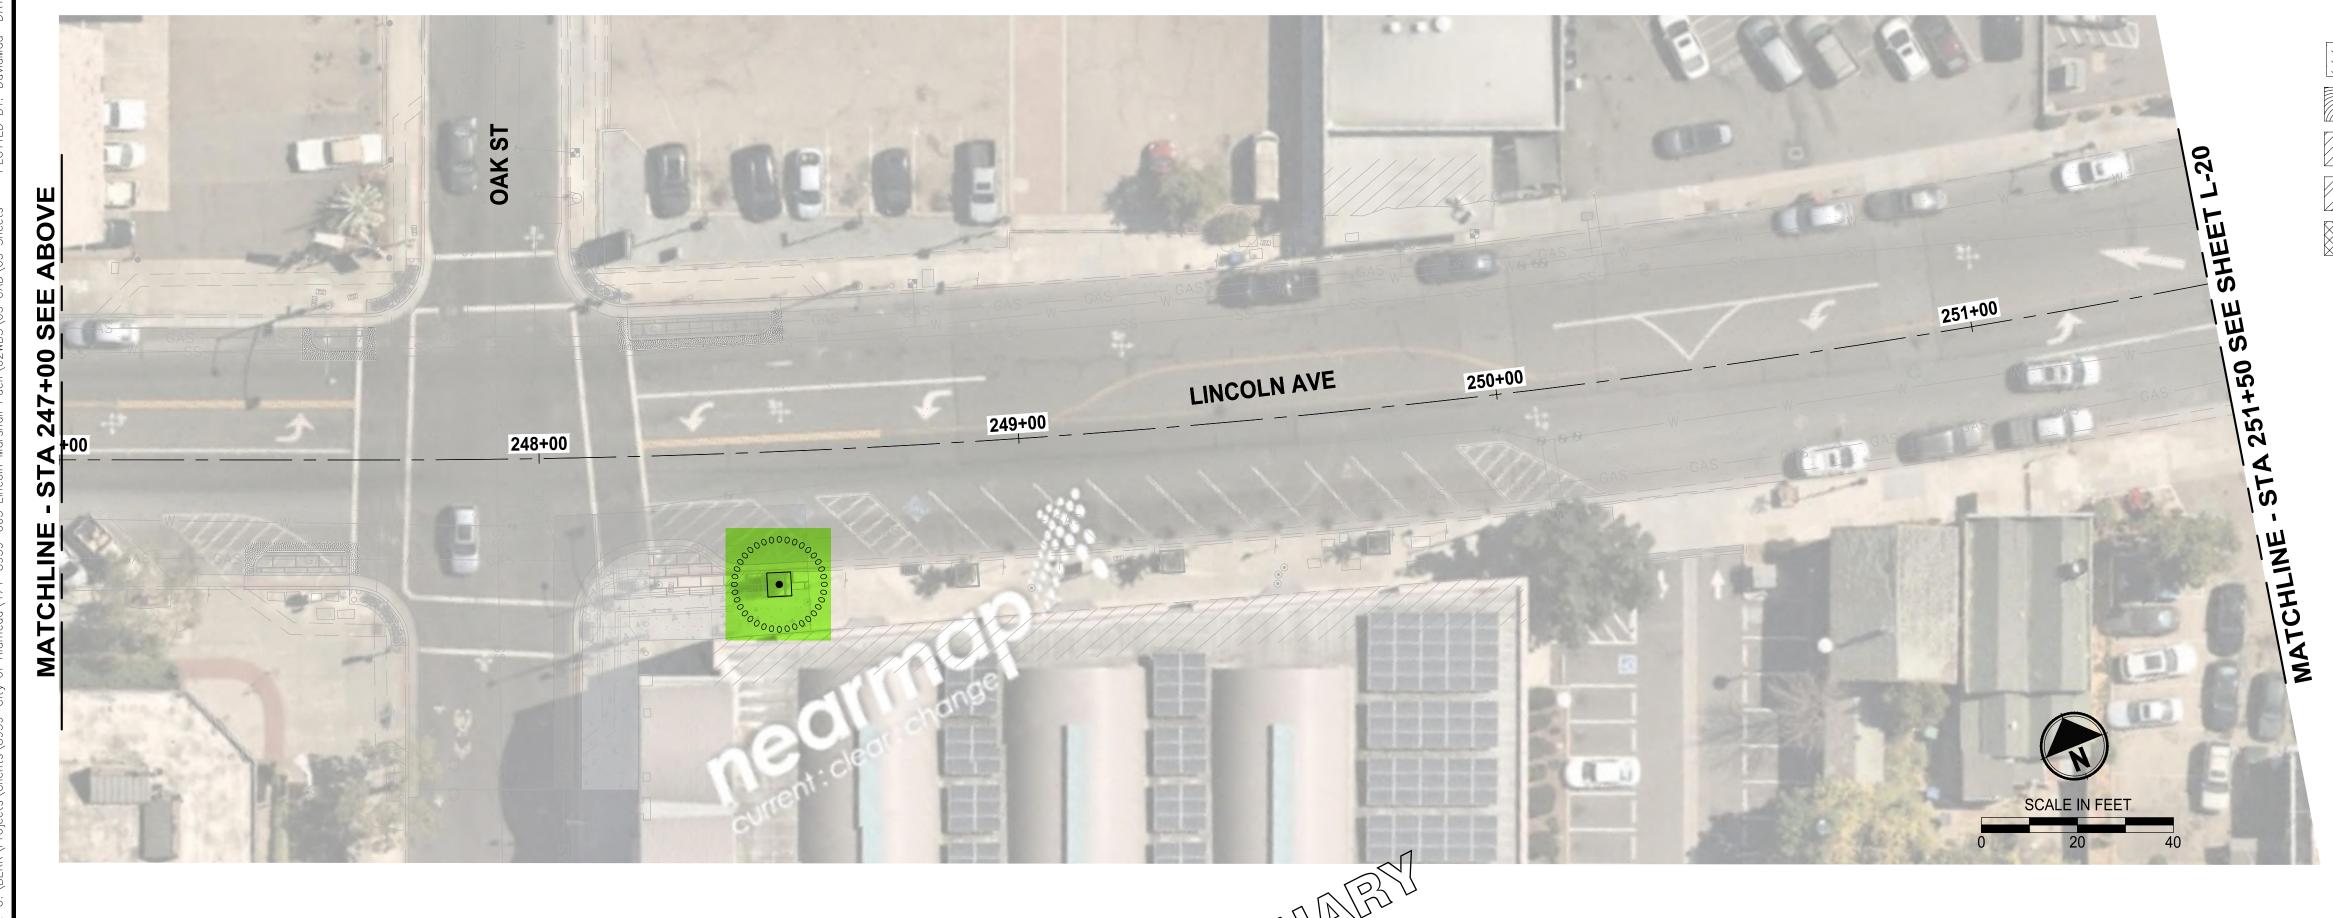
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**CITY OF ALAMEDA** 

CORRIDOR SAFETY IMPROVEMENT PROJECT LINCOLN AVE | MARSHALL WAY | PACIFIC AVE NOT FOR CONSTRUCTION

257 OF 262 LANDSCAPE PLAN



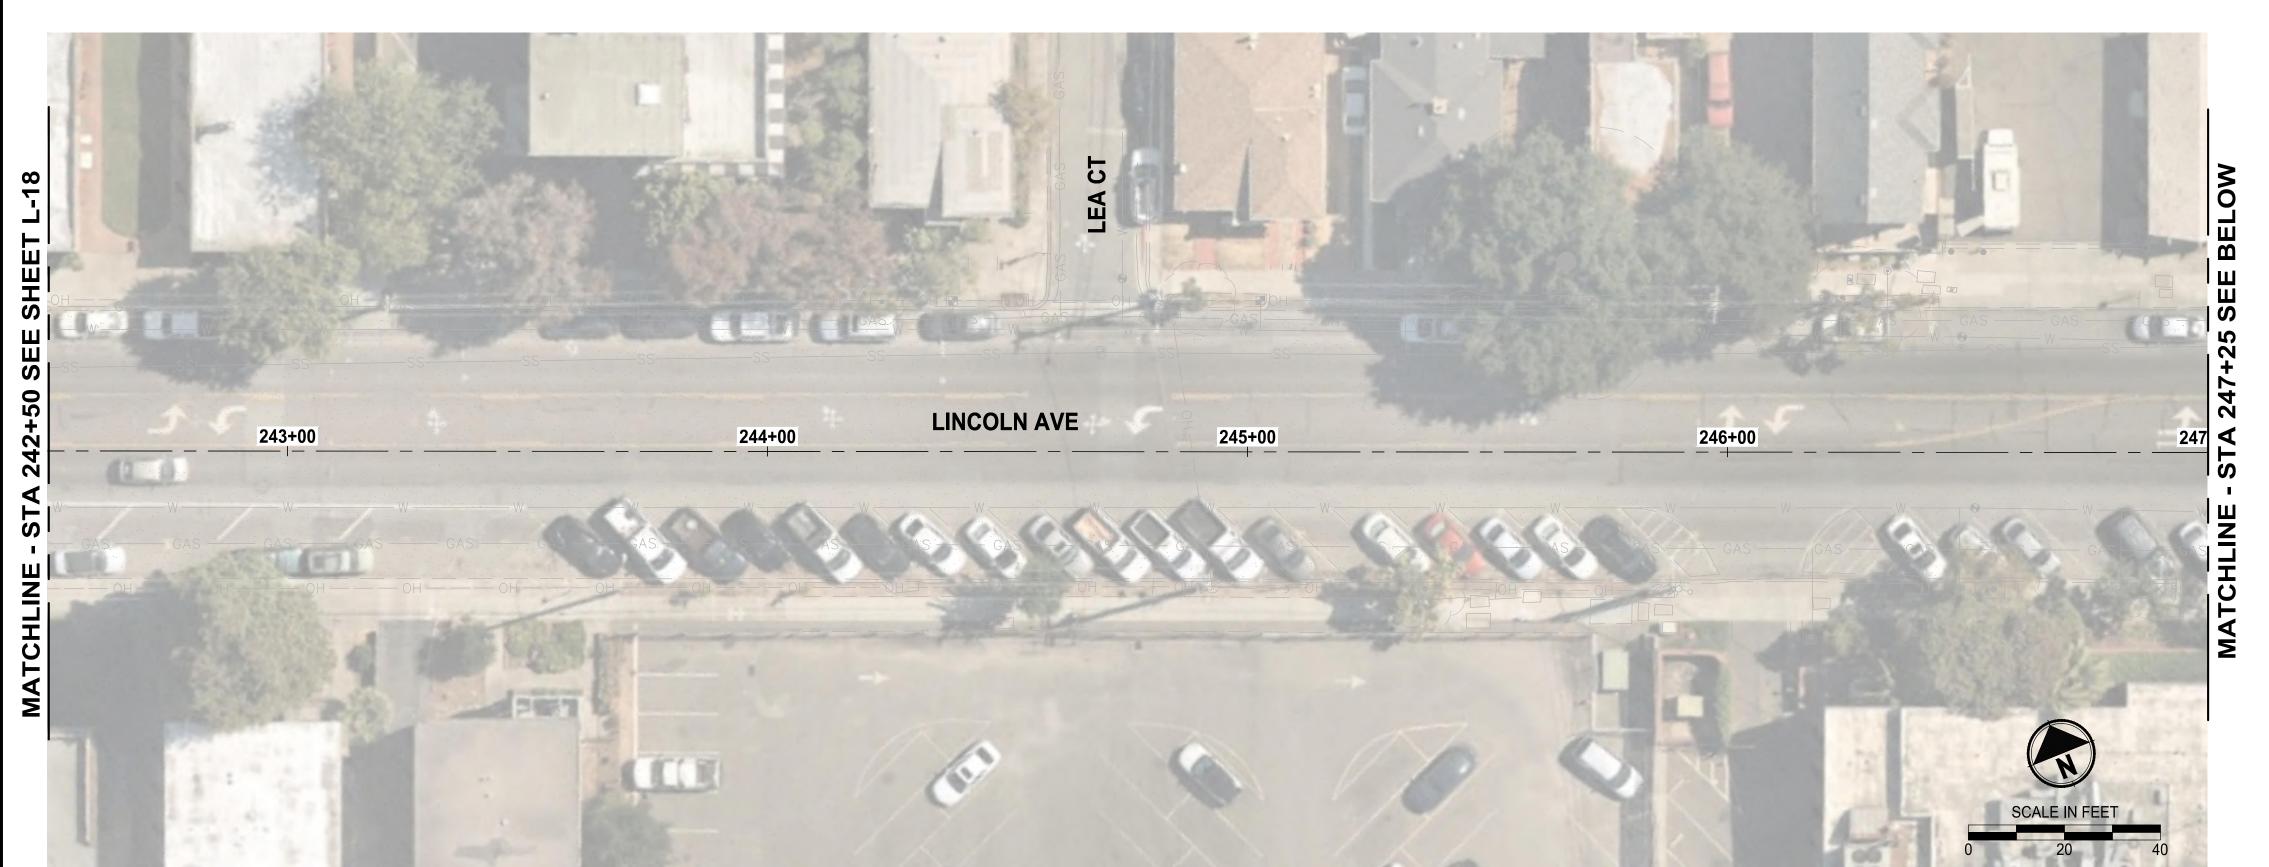

- REFER TO SHEET L-23 FOR LANDSCAPE CONSTRUCTION NOTES, DETAILS, AND PLANT SCHEULE.
- ALL WORK SHALL BE PERFORMED TO THE SATISFACTION OF THE OWNER'S REPRESENTATIVE.
- 3. ALL AREAS DISTURBED BY CONSTRUCTION SHALL BE RESTORED.

## **LEGEND & ABBREVIATIONS**

$\bigcirc$	OCTOBER GLORY RED MAPLE
	RED FLOWERING GUM
	STERLING SILVER LINDEN
00000000000000000000000000000000000000	ACCOLADE ELM
•	ORCHID ROSE
	SAGELEAF ROCKROSE
•	YANKEE POINT CARMEL CREEPER
$\bigcirc$	STICKY MONKEYFLOWER
	FORTNIGHT LILY

WHITE PACIFIC COAST IRIS

ISLAND MALLOW **DEER GRASS** 

HUMMINGBIRD SAGE

**CLEVELAND SAGE** 

FOOTHILL SEDGE SMALL CAPE RUSH

BEACH STRAWBERRY

SPREADING RUSH

LOW HORIZON COAST ROSEMARY

65 % REVIEW SUBMITTAL

L-19

NOT FOR CONSTRUCTION

258 OF 262

LANDSCAPE PLAN


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			DRAWN DSB
			CHECKED DCS
			APPROVED


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CITY OF ALAMEDA
CORRIDOR SAFETY IMPROVEMENT PROJECT LINCOLN AVE | MARSHALL WAY | PACIFIC AVE

1. NO LANDSCAPE IMPROVEMENTS THIS SHEET



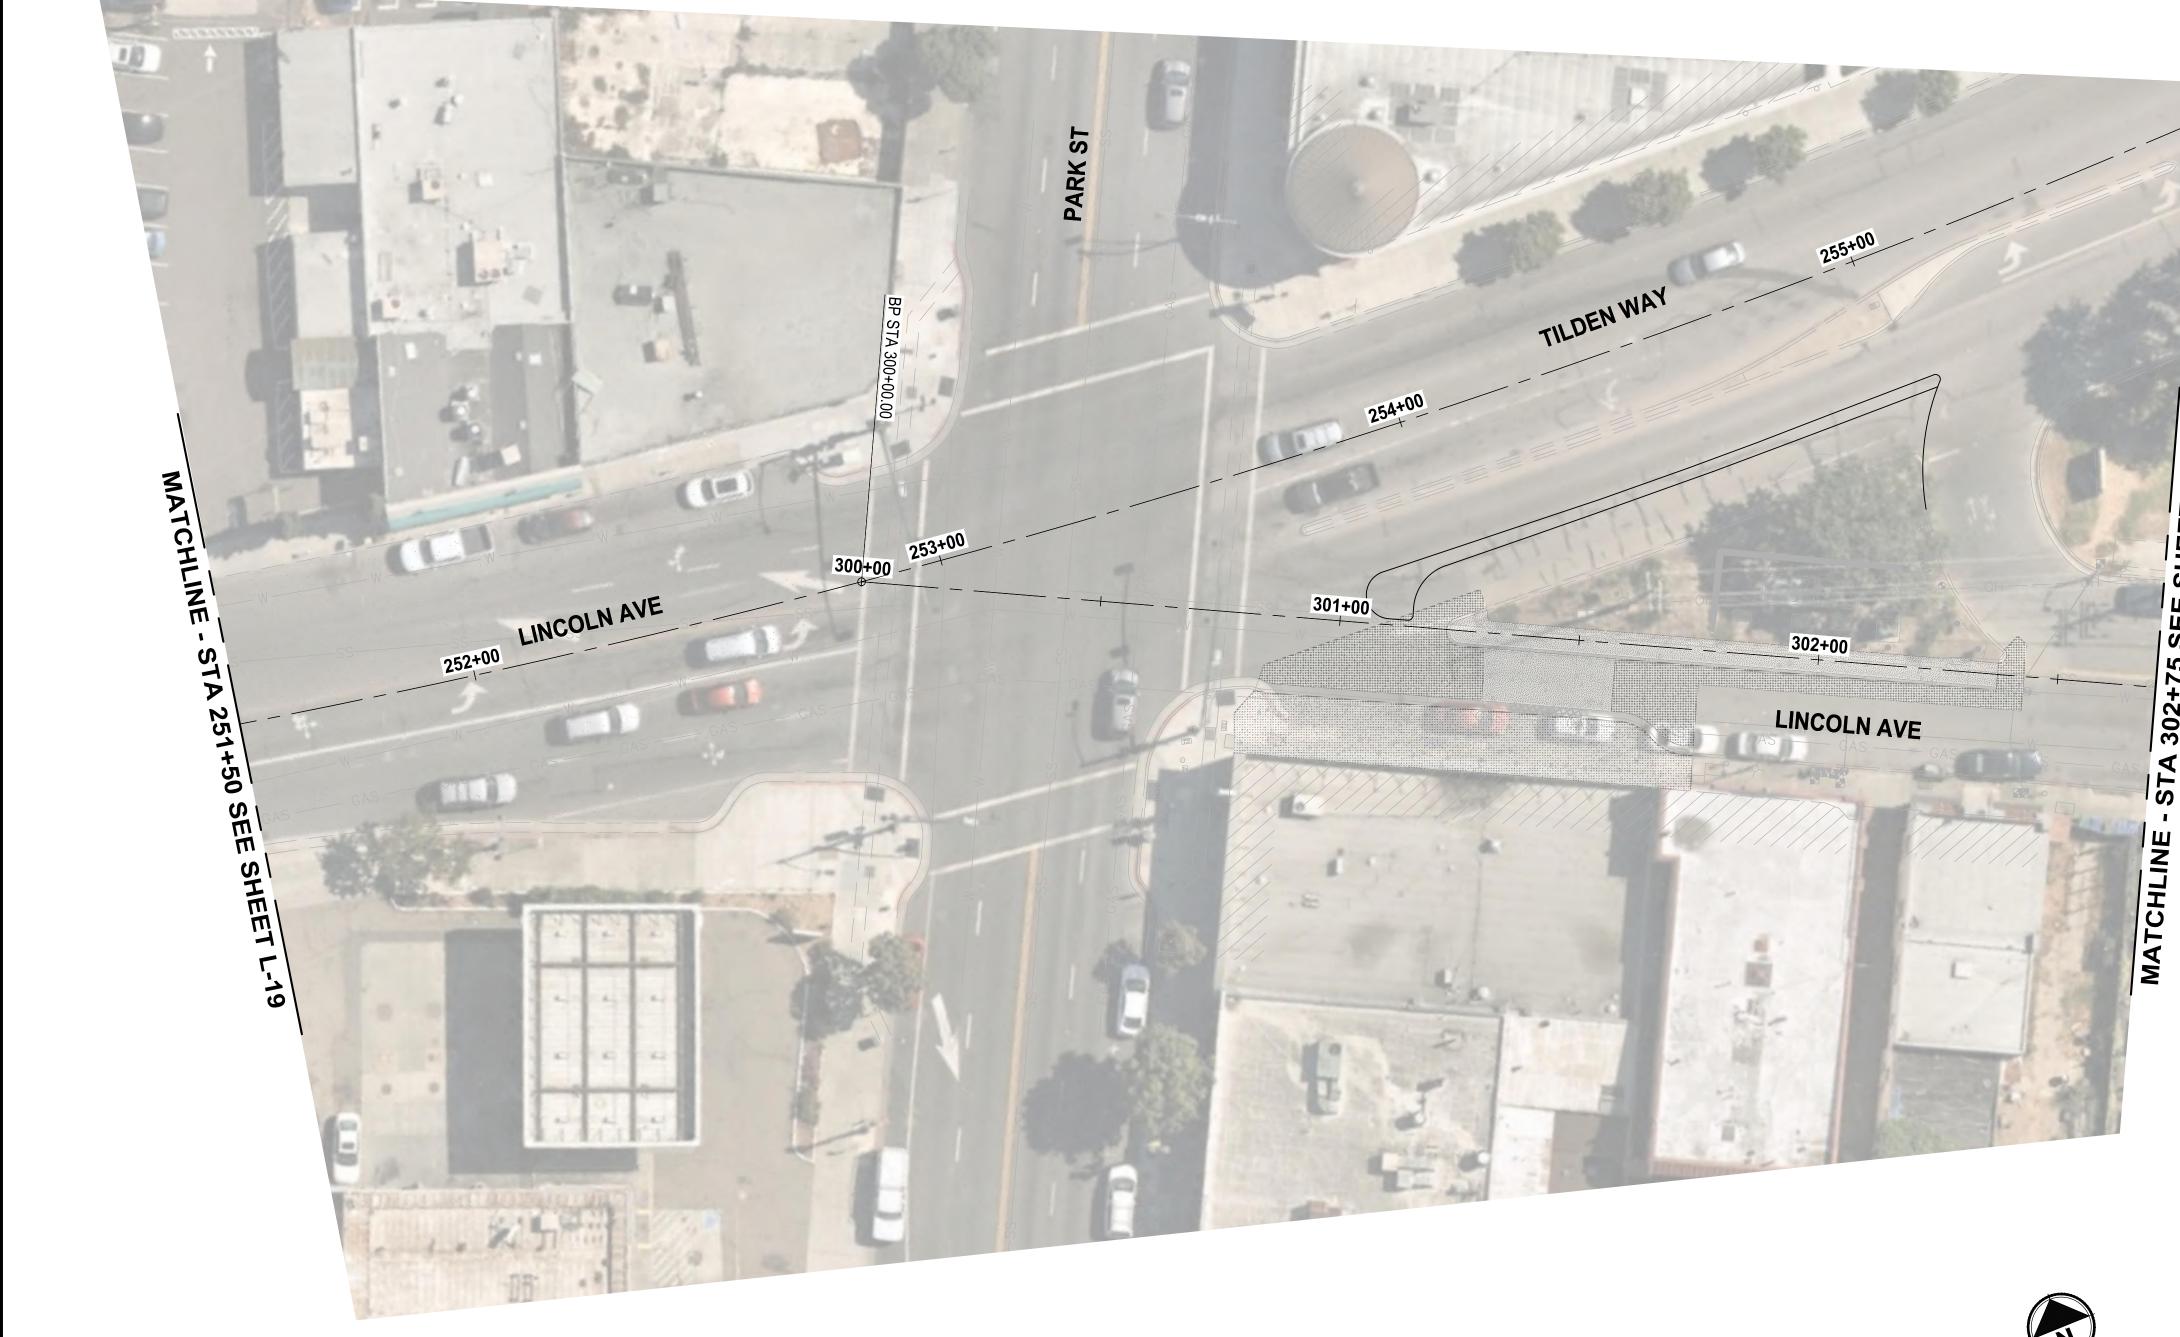

65 % REVIEW SUBMITTAL

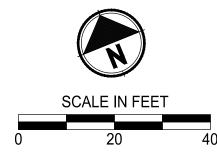NOT FOR CONSTRUCTION

DRAWING NO.
259 OF 262

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Τ.	REVISIONS	DATE	BY	DESIGNED DSB
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00				APPROVED

ONE INCH AT FULL SCALE. IF NOT, SCALE ACCORDINGLY	
FILE NAME SF8939003C-LS	
JOB No. C65700	
DATE 06/2025	

PRELIMINAL.

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CITY OF ALAMEDA
CORRIDOR SAFETY IMPROVEMENT PROJECT
LINCOLN AVE | MARSHALL WAY | PACIFIC AVE

LANDSCAPE PLAN

1. NO LANDSCAPE IMPROVEMENTS THIS SHEET



ABOVE SEE 307+25 LINCOLN AVE 308+00 309+00 310+00 311+00 MATCHLINE SCALE IN FEET

65 % REVIEW SUBMITTAL NOT FOR CONSTRUCTION

ONE INCH AT FULL SCALE. IF NOT, SCALE ACCORDINGLY

DESIGNED DSB DRAWN DSB CHECKED DCS

APPROVED DP


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CITY OF ALAMEDA CORRIDOR SAFETY IMPROVEMENT PROJECT LINCOLN AVE | MARSHALL WAY | PACIFIC AVE

LANDSCAPE PLAN

260 OF 262



- REFER TO SHEET L-23 FOR LANDSCAPE CONSTRUCTION NOTES, DETAILS, AND PLANT SCHEULE.
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DESIGNED DSB DRAWN DSB CHECKED DCS
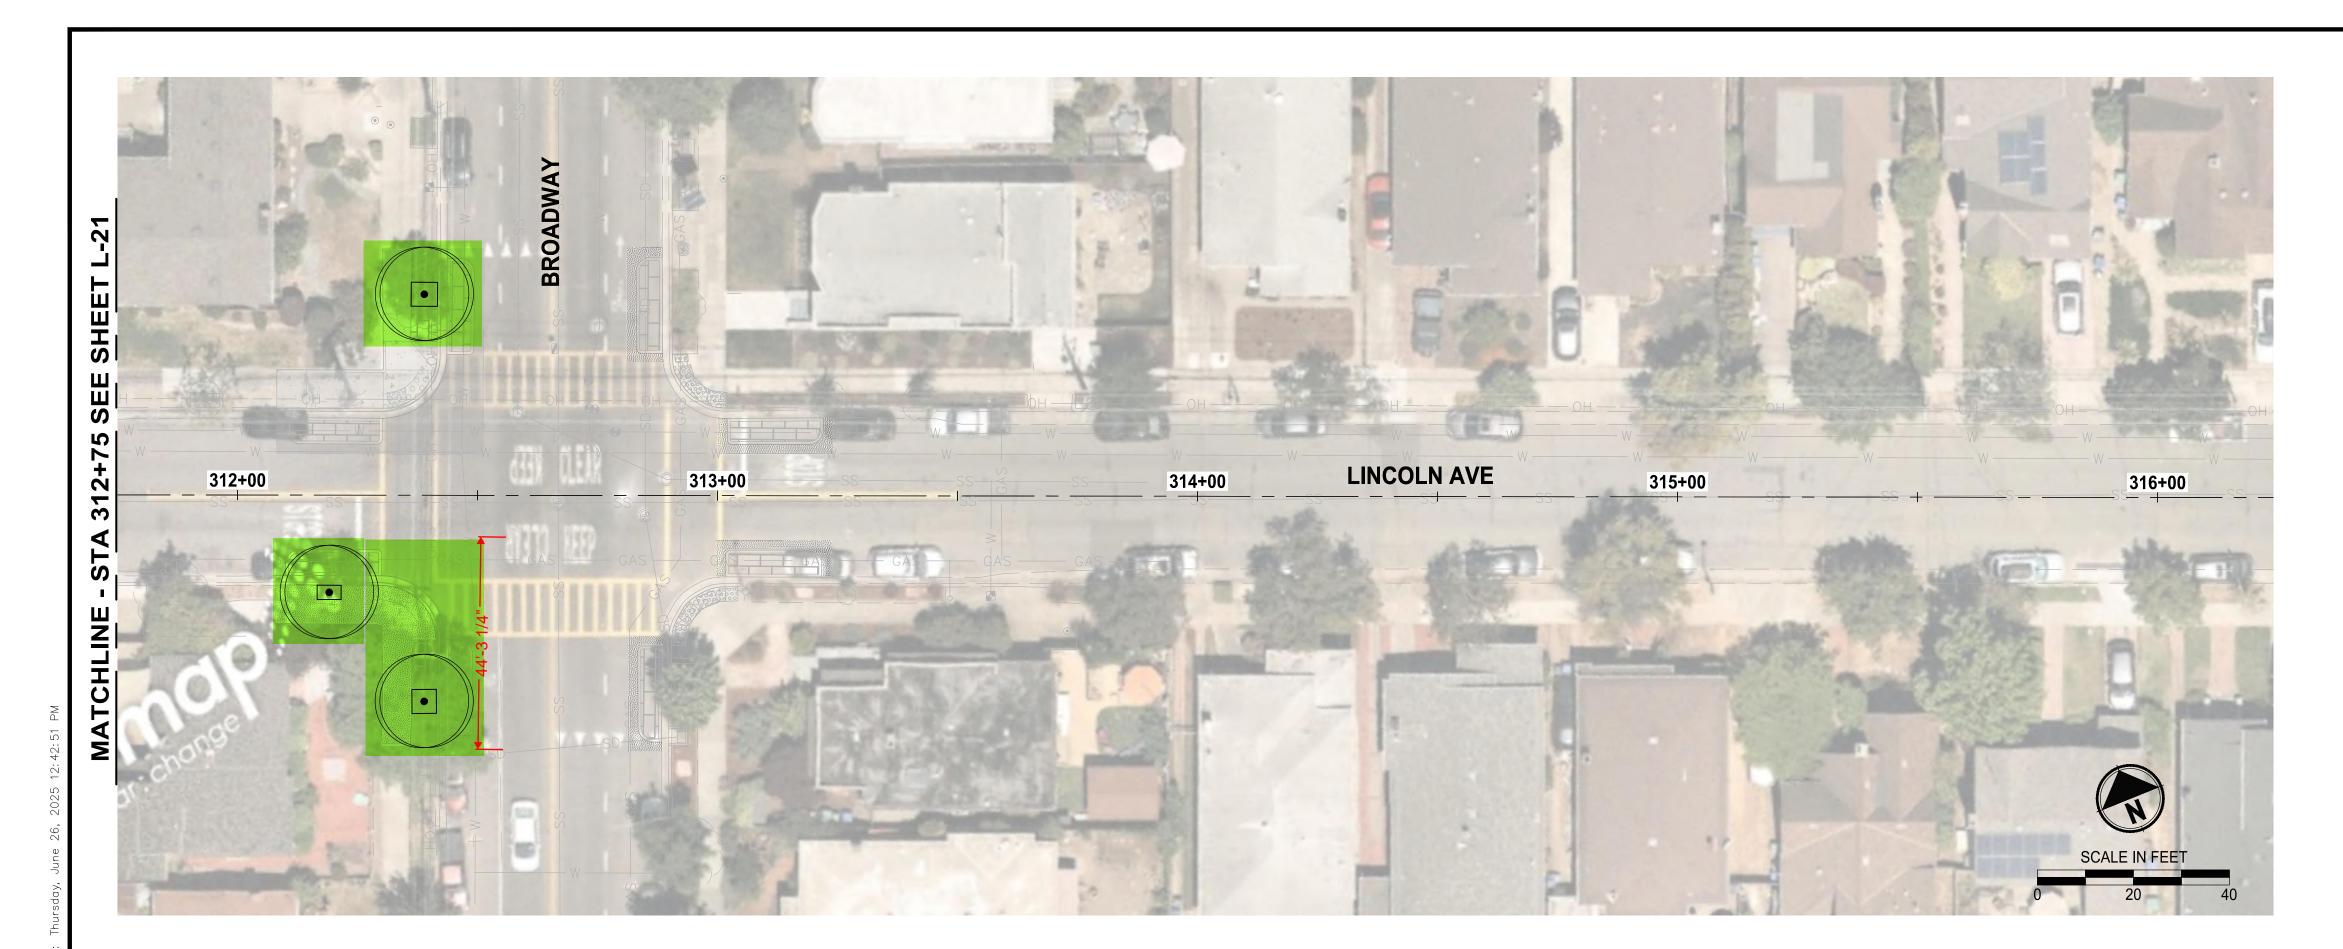
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REVISIONS


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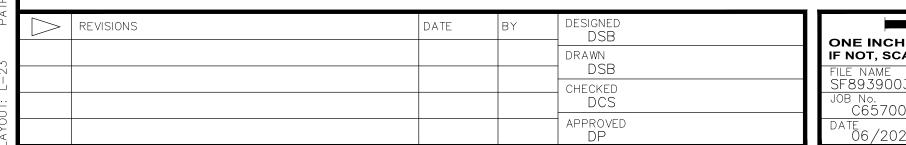
LANDSCAPE PLAN


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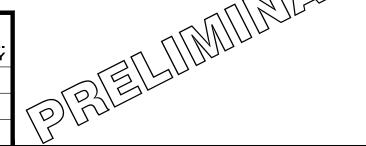



#### **GENERAL LANDSCAPE NOTES:**

- CONTRACTOR SHALL VERIFY THE LOCATION OF SUBSURFACE UTILITIES, PIPES, AND STRUCTURES. SHOULD UTILITIES OR OTHER WORK NOT BE SHOWN ON THE PLANS BE FOUND DURING EXCAVATIONS, PROMPTLY NOTIFY OWNER'S REPRESENTATIVE. FAILURE TO DO SO WILL MAKE CONTRACTOR LIABLE FOR DAMAGE ARISING FROM HIS OPERATIONS SUBSEQUENT TO DISCOVERY OF UTILITIES NOT SHOWN ON PLANS.
- CONTRACTOR TO RECEIVE SITE GRADED TO PLUS OR MINUS 0.10 FEET PRIOR TO PROJECT EXECUTION.
- NO PLANT SPECIES SUBSITUTIONS WILL BE ACCEPTED DURING BIDDING. CONTRACT GROW PLANTS AS REQUIRED. CONTAINER GROWN PLANTS SHALL MEET INDUSTRY STANDARDS FOR SIZE AS SHOWN IN THE AMERICAN ASSOCIATION OF NURSERYMAN GRADES AND STANDARDS AS PUBLISHED IN Z60.1 "AMERICAN STANDARD FOR NURSERY STOCK" MANUAL IN ORDER TO BE ACCEPTED.
- ALL PLANTS AND LAYOUT TO BE APPROVED BY THE OWNER'S REPRESENTATIVE PRIOR TO EXCAVATION OF PLANTING HOLES.
- 5. NOTIFY OWNER'S REPRESENTATIVE 36 HOURS PRIOR TO COMMENCEMENT OF WORK TO COORDINATE PROJECT OBSERVATION MEETINGS.
- CLEAR AND GRUB ALL AREAS TO RECEIVE NEW PLANTING AND PREPARE SOIL PER SPECIFICATION.
- APPLY FERTILIZER TO ALL GROUNDCOVER, SHRUB, AND TREE PLANTING AREAS PER MANUFACTURER'S RECOMMENDATIONS FOR FERTILIZER TYPE (N-P-K RATIO).
- SPACE GROUNDCOVERS TRIANGULARLY IN PLANTING AREAS. HOLD GROUNDCOVER BACK 18 INCHES MINIMUM FROM THE EDGE OF NEW SHRUB PLANTS UNLESS OTHERWISE NOTED.
- PROTECT EXISTING TREES TO REMAIN PER PRESERVATION AND REMOVAL PLAN
- 10. CONTRACTOR IS RESPONSIBLE FOR A THOROUGH CLEAN-UP OF THEIR RESPECTIVE WORK, DAILY AND AT PROJECT CLOSE-OUT
- CONTRACTOR SHALL WARRANTY ALL PLANT MATERIALS FOR A PERIOD OF ONE YEAR AFTER FINAL ACCEPTANCE HAS BEEN GRANTED. CONTRACTOR SHALL PROVIDE WATER FOR ESTABLISHMENT DURING THIS PERIOD.



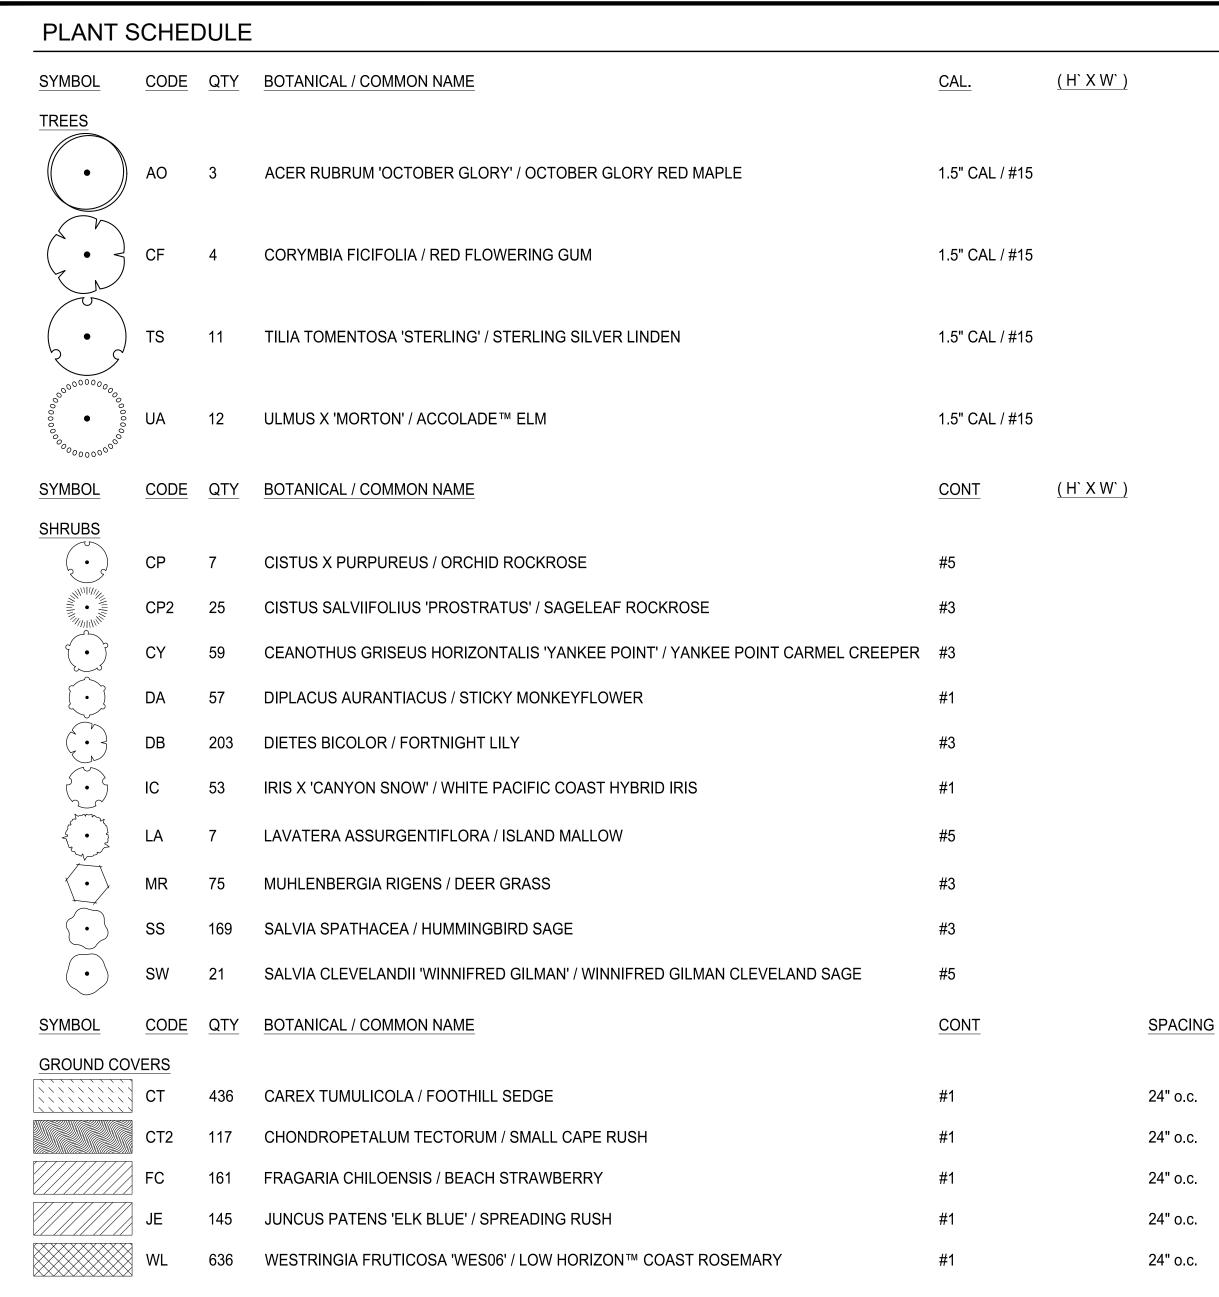

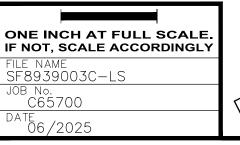

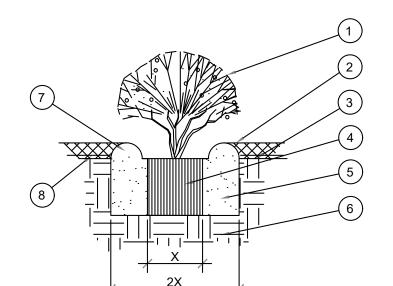

(1) SHRUB, PERENNIAL, OR ORNAMENTAL GRASS. MULCH, TYPE AND DEPTH PER PLANS. PLACE NO (2) MORE THAN 1" OF MULCH WITHIN 6" OF PLANT

(3) FINISH GRADE.


(4) ROOT BALL.

BACKFILL. AMEND AND FERTILIZE ONLY AS RECOMMENDED IN SOIL FERTILITY ANALYSIS.

(6) UNDISTURBED NATIVE SOIL. (7) 3" HIGH EARTHEN WATERING BASIN.

(8) WEED FABRIC UNDER MULCH.

## SHRUB AND PERENNIAL PLANTING SCALE: NTS

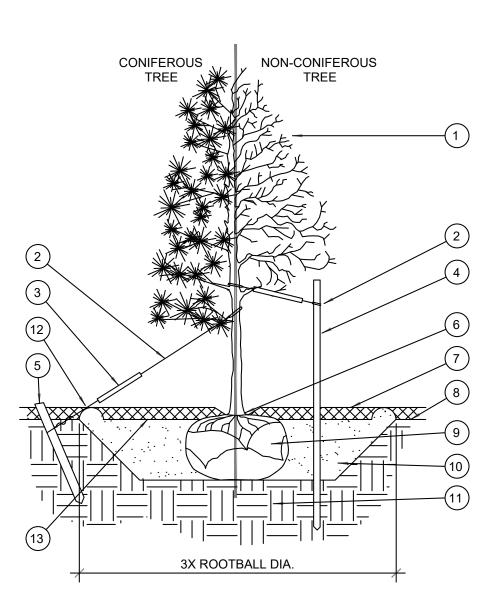

(1) TREE CANOPY.

- FLEXIBLE-HOSE. NAIL STRAPS TO EACH SIDE OF STAKE IN TEARDROP FIGURE.
- (3) 24" X 3/4" P.V.C. MARKERS OVER WIRES.
- 2" DIAMETER LODGEPOLE TREE STAKE. BOTH SIDES (4) PARALLEL TO STREET. CUT TOP OF STAKE AS NECESSARY TO CLEARL LOWEST BRANCH BY 6".
- PRESSURE-TREATED WOOD DEADMAN, TWO PER TREE (MIN.). BURY 2'-6" INTO UNDISTURBED SOIL.
- (6) TRUNK FLARE.
- MULCH, TYPE AND DEPTH PER PLANS. DO NOT o PLACE MULCH WITHIN 6" OF TRUNK.
- $(\,8\,)\,$  FINISH GRADE.
- $(\,9\,)\,$  ROOT BALL.
- BACKFILL. AMEND AND FERTILIZE ONLY AS RECOMMENDED IN SOIL FERTILITY ANALYSIS.
- (11) UNDISTURBED NATIVE SOIL.
- (12) 4" HIGH EARTHEN WATERING BASIN.
- (13) FINISH GRADE.

- 1. CUT AND REMOVE TOP  $\frac{1}{2}$  OF WIRE BASKET, TURN DOWN TOP  $\frac{1}{2}$  OF BURLAP; REMOVE ALL CORD & TWINE FROM BASE OF TRUNK; IF NONDEGRADEABLE WRAP IS USED, REMOVE
- 2. LOOSEN EXTERIOR OF THE ROOT BALL AND THE ROOT MATT AT THE BOTTOM OF THE BALL, CUT ALL
- MAJOR CIRCLING ROOTS.
- QUALIFIED PLANTING FOREMAN.
- 2. CONTRACTOR SHALL VERIFY THAT ADEQUATE DRAINAGE EXISTS PRIOR TO PLANTING.
- 3. CONTRACTOR SHALL VERIFY THE LOCATION OF ALL UTILITIES PRIOR TO PLANTING. 4. TREES SHALL BE 7 TO 10 FEET HIGH SUPPLIED IN FIFTEEN GALLON CONTAINERS. TREES SHALL HAVE A MINIMUM OF 1.5 INCH TRUNK AT DBH.

1. ALL WORK SHALL BE PERFORMED BY PERSONS FAMILIAR WITH THIS TYPE OF WORK AND UNDER THE SUPERVISION OF A

- TREES SHALL CONFORM TO THE STANDARDS SET FORTH IN THE MOST RECENT AMERICAN STANDARDS FOR NURSERY STOCK PUBLISHED BY THE AMERICAN ASSOCIATION OF NURSERYMEN.
- TREES SHALL HAVE A STRAIGHT STRONG TERMINAL LEADER, UNCUT AND UNBROKEN. THE MAIN TRUNK SHALL HAVE
- ACCPTABLE LATERAL GROWTH ALONG ITS LENGTH SHORTER AND SMALLER IN DIAMETER THAN THE MAIN TRUNK.
- 7. ALL TREES THAT, IN THE OPINION OF THE CITY ENGINEER, ARE DISEASED, INSECT INFECTED, OR HAVE GIRDLING ROOTS, WILL
- 8. TREES WITH ROOT FLARE COVERED BY MORE THAN 1.5 INCHES OF SOIL WILL BE REJECTED PRIOR TO INSTALLATION
- 9. PLANTING MIXTURE FOR THE BACKFILL SHALL HAVE NO SOIL AMENDMENTS.

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- 10. IN PARKWAY STRIPS SET PLANTER TOP 1.5 INCHES BELOW SIDEWALK GRADE. IN LAWNS OR GRANDCOVER AREAS SET PLANTER TOP FLUSH WITH FINNISHED GRADE. IN LAWN AREAS, THERE SHALL BE A 2 FOOT MULCH RING CLEARANCE BETWEEN EDGE OF LAWN AND THE TREE.
- 11. STAKING OF TREE IS NOT RECOMMENDED EXCEPT ON WINDY SITES, FOR LARGE EVERGREEN TREES, OR IN AREAS WITH HEAVY TRAFFIC. IF STAKING IS DONE. FLEXIBLE HOSE - NOT TIRES AND WIRES - SHOULD BE USED. NAIL FLEXIBLE TREE STRAP TO EACH SIDE OF THE STAKE IN TEARDROP FIGURE WITH 1 INCH MAX GALVANIZED ROOFING NAIL.
- 12. TREE STAKES TO BE REMOVED AFTER TWO YEARS.
- 13. AT PLANTING PRUNE ONLY CROSSING LIMBS, CO-DOMINANT LEADER, BROKEN, DISEASED OR DEAD BRANCHES, AND ANY BRANCHES THAT POSE A HAZARD TO PEDESTRIANS WHILE PRESERVING FORM AND CHARACTER OF TREE. DO NOT CUT LEADER. DO NOT PRUNE IN ORDER TO REDUCE CANOPY SIZE.
- 14. DO NOT WRAP TRUNK OF TREE.
- 15. A ROOT COLLAR EXCAVATION FOR ALL TREES SPECIED WILL BE DONE BY THE CITY ENGINEER TO ENSURE THAT TREES WERE NOT PLANTED OR GROWN TOO DEEPLY AT THE NURSERY. LANDSCAPE CONTRACTORS SHALL HAVE SUPPLIERS MARK GROUND LEVEL LINE ABOVE ROOTBALL. IF CITY ENGINEER DETERMINES THAT THERE IS EXCESSIVE SOIL OVER THE ROOT CROWN. THE TREES WILL BE REJECTED.
- 16. MULCH SHALL BE 3" DEEP UNLESS OTHERWISE NOTED.

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- 17. TREES SHALL BE WATERED TWICE WEEKLY. ALL TREES NOT MEETING WITH THE APPROVAL OF THE CITY ENGINEER AT THE END OF THAT PERIOD SHALL BE REPLACED BY THE CONTRACTOR.
- 18. DEEP WATERING TUBES.



CITY OF ALAMEDA CORRIDOR SAFETY IMPROVEMENT PROJECT LINCOLN AVE | MARSHALL WAY | PACIFIC AVE LANDSCAPE SCHEDULE, NOTES, & DETAILS

NOTE: ALL PLANTS SHALL BE PLANTED AT EQUAL TRIANGULAR SPACING (EXCEPT WHERE SHOWN ON PLANS AS

INFORMAL GROUPINGS). REFER TO PLANT LEGEND FOR SPACING DISTANCE BETWEEN PLANTS.

**PARKWAY** 

OR ISLAND

OPEN LANDSCAPE

∴⊖∸

SCALE: NOT TO SCALE

**ROOT BARRIER - PLAN VIEW** 

EDGE OF PLANTING AREA -

PLANT SPACING

SCALE: NTS

D

65 % REVIEW SUBMITTAL

NOT FOR CONSTRUCTION

(1) TYPICAL WALKWAY OR PAVING

(3) LINEAR ROOT BARRIER MATERIAL.

SEE NOTES FOR TYPE AND

TYPICAL PLANTING AREA

(6) TYPICAL CURB AND GUTTER

1) ROOT BARRIER; CONTRACTOR SHALL USE DEEP ROOT LINEAR BARRIER #22-29-18-P / HIGH

> DENSITY POLYETHYLENE, MANUFACTURED BY DEEP

ROOT CORP OR EQUAL. SET

TOP FLUSH WITH FINISHED

2) BARRIERS SHALL BE LOCATED

HARDSCAPE. UNDER NO

CONTRACTOR USE ROOT

BARRIERS OF A TYPE THAT

COMPLETELY ENCIRCLE THE

— PLANT CENTER (TYP.)

IMMEDIATELY ADJACENT TO

CIRCUMSTANCES SHALL THE

GRADE. 24" DEEP.

ROOTBALL.

MANUFACTURER. INSTALL PER

MANUFACTURER'S SPECIFICATIONS.

(2) TREE TRUNK

TREE CANOPY

DRAWING NO. 262 OF 262